ABBREVIATIONS:

ADDL

ALT

AFF

ASTM AWS AB & OR **APPROX** ARCH (α) BAL BETW BM BRG BLK **BORBOT** BEW BRKT BLDG CIP CTRD CLR COL CONC CMU CONST CONSTJT OR (CONT CJ DET DIA OR Ø DIM DN DWG EΑ ELECT


EL OR 🕀 ELEV EMBED EQ EQUIP EXIST EXP BOLT EJ OR EXP JT EXT

FF FT FIN FIN FL FPRF FL FD FTG FDN GA GALV GWB or GYP HGT H OR HORIZ HDR INFO INCL ID INSUL INT IN\ LWC LBS

ADDITIONAL ALTERNATE MATL MAX **ABOVE FINISH FLOOR** MECH AMERICAN SOCIETY FOR TESTING **MEMB** AND MATERIALS MEP AMERICAN WELDING SOCIETY MID ANCHOR BOLT **MID-PT** AND MIN APPROXIMATELY MR ARCHITECT OR ARCHITECTURAL AT NFPA BALANCE BETWEEN NOM BEAM NWC BEARING Ν BLOCK NIC BOTTOM NTS BOTTOM EACH WAY NO OR # BRACKET BUILDING OC **OPNG** CAST-IN-PLACE OPP CENTERED OD CENTERLINE OF CLEAR P.T. COLUMN PT CONCRETE PTD CONCRETE MASONRY UNIT PTB CONSTRUCTION PSF CONSTRUCTION JOINT PSI CONTINUOUS PVC CONTROL JOINT P/C DETAIL DIAMETER REF DIMENSION REINF DOWN DRAWING REQD RD EACH \mathbf{S} ELECTRICAL SCH OR SCHED ELEVATION SECT ELEVATOR SH EMBEDMENT SIM EQUAL SOG EQUIPMENT EXISTING SPECS **EXPANSION BOLT** SPKR **EXPANSION JOINT** SQ EXTERIOR STN STL STD **FINISH FACE** STL FEET OR FOOT ST STL FINISH STRUCT **FINISHED FLOOR** SYM **FIREPROOF** FLOOR TEMP **FLOOR DRAIN** FOOTING THK FOUNDATION Х GAGE OR GAUGE ΤO GALVANIZED T & B GYPSUM WALL BOARD TOC HEIGHT TOS HORIZONTAL TOW HEADER TYP INFORMATION UNO INCLUDING OR INCLUSIVE **INSIDE DIAMETER** V OR VERT **INSIDE FACE** VIF INSULATION W INTERIOR WWPA INVERT JOINT W/ LIGHT WEIGHT CONCRETE W/O WP POUNDS

MANUF OR MFR MANUFACTURER MATERIAL MAXIMUM MECHANICAL MEMBRANE MECHANICAL EQUIPMENT PAD MIDDLE **MID-POINT** MINIMUM MOISTURE RESISTANT NATIONAL FOREST PRODUCTS ASSOCIATION NOMINAL NORMAL WEIGHT CONCRETE NORTH NOT IN CONTRACT NOT TO SCALE NUMBER ON CENTER OPENING OPPOSITE OUTSIDE DIAMETER **OUTSIDE FACE** PRESSURE TREATED POINT PAINTED POST-TENSIONED BAR POUNDS PER SQUARE FOOT POUNDS PER SQUARE INCH POLYVINYL CHLORIDE PRECAST CONCRETE RADIUS REFERENCE **REINFORCE, REINFORCING** OR REINFORCEMENT REQUIRED ROOF DRAIN SEALANT SCHEDULE SECTION SHEET SIMILAR SLAB ON GRADE SOUTH SPECIFICATIONS SPRINKLER SQUARE STAINLESS STEEL **STANDARD** STEEL STAINLESS STEEL STRUCTURAL SYMMETRICAL **TEMPERATURE OR** TEMPORARY THICK OR THICKNESS TIMES OR BY TOP OF TOP AND BOTTOM TOP OF CURB or CONCRETE TOP OF STEEL TOP OF WALL TYPICAL UNLESS NOTED OTHERWISE VERTICAL **VERIFY IN FIELD** WEST WESTERN WOOD PRODUCTS ASSOCIATION WITH WITHOUT WORKING POINT

SPRINGFIELD STREET RESIDENCES

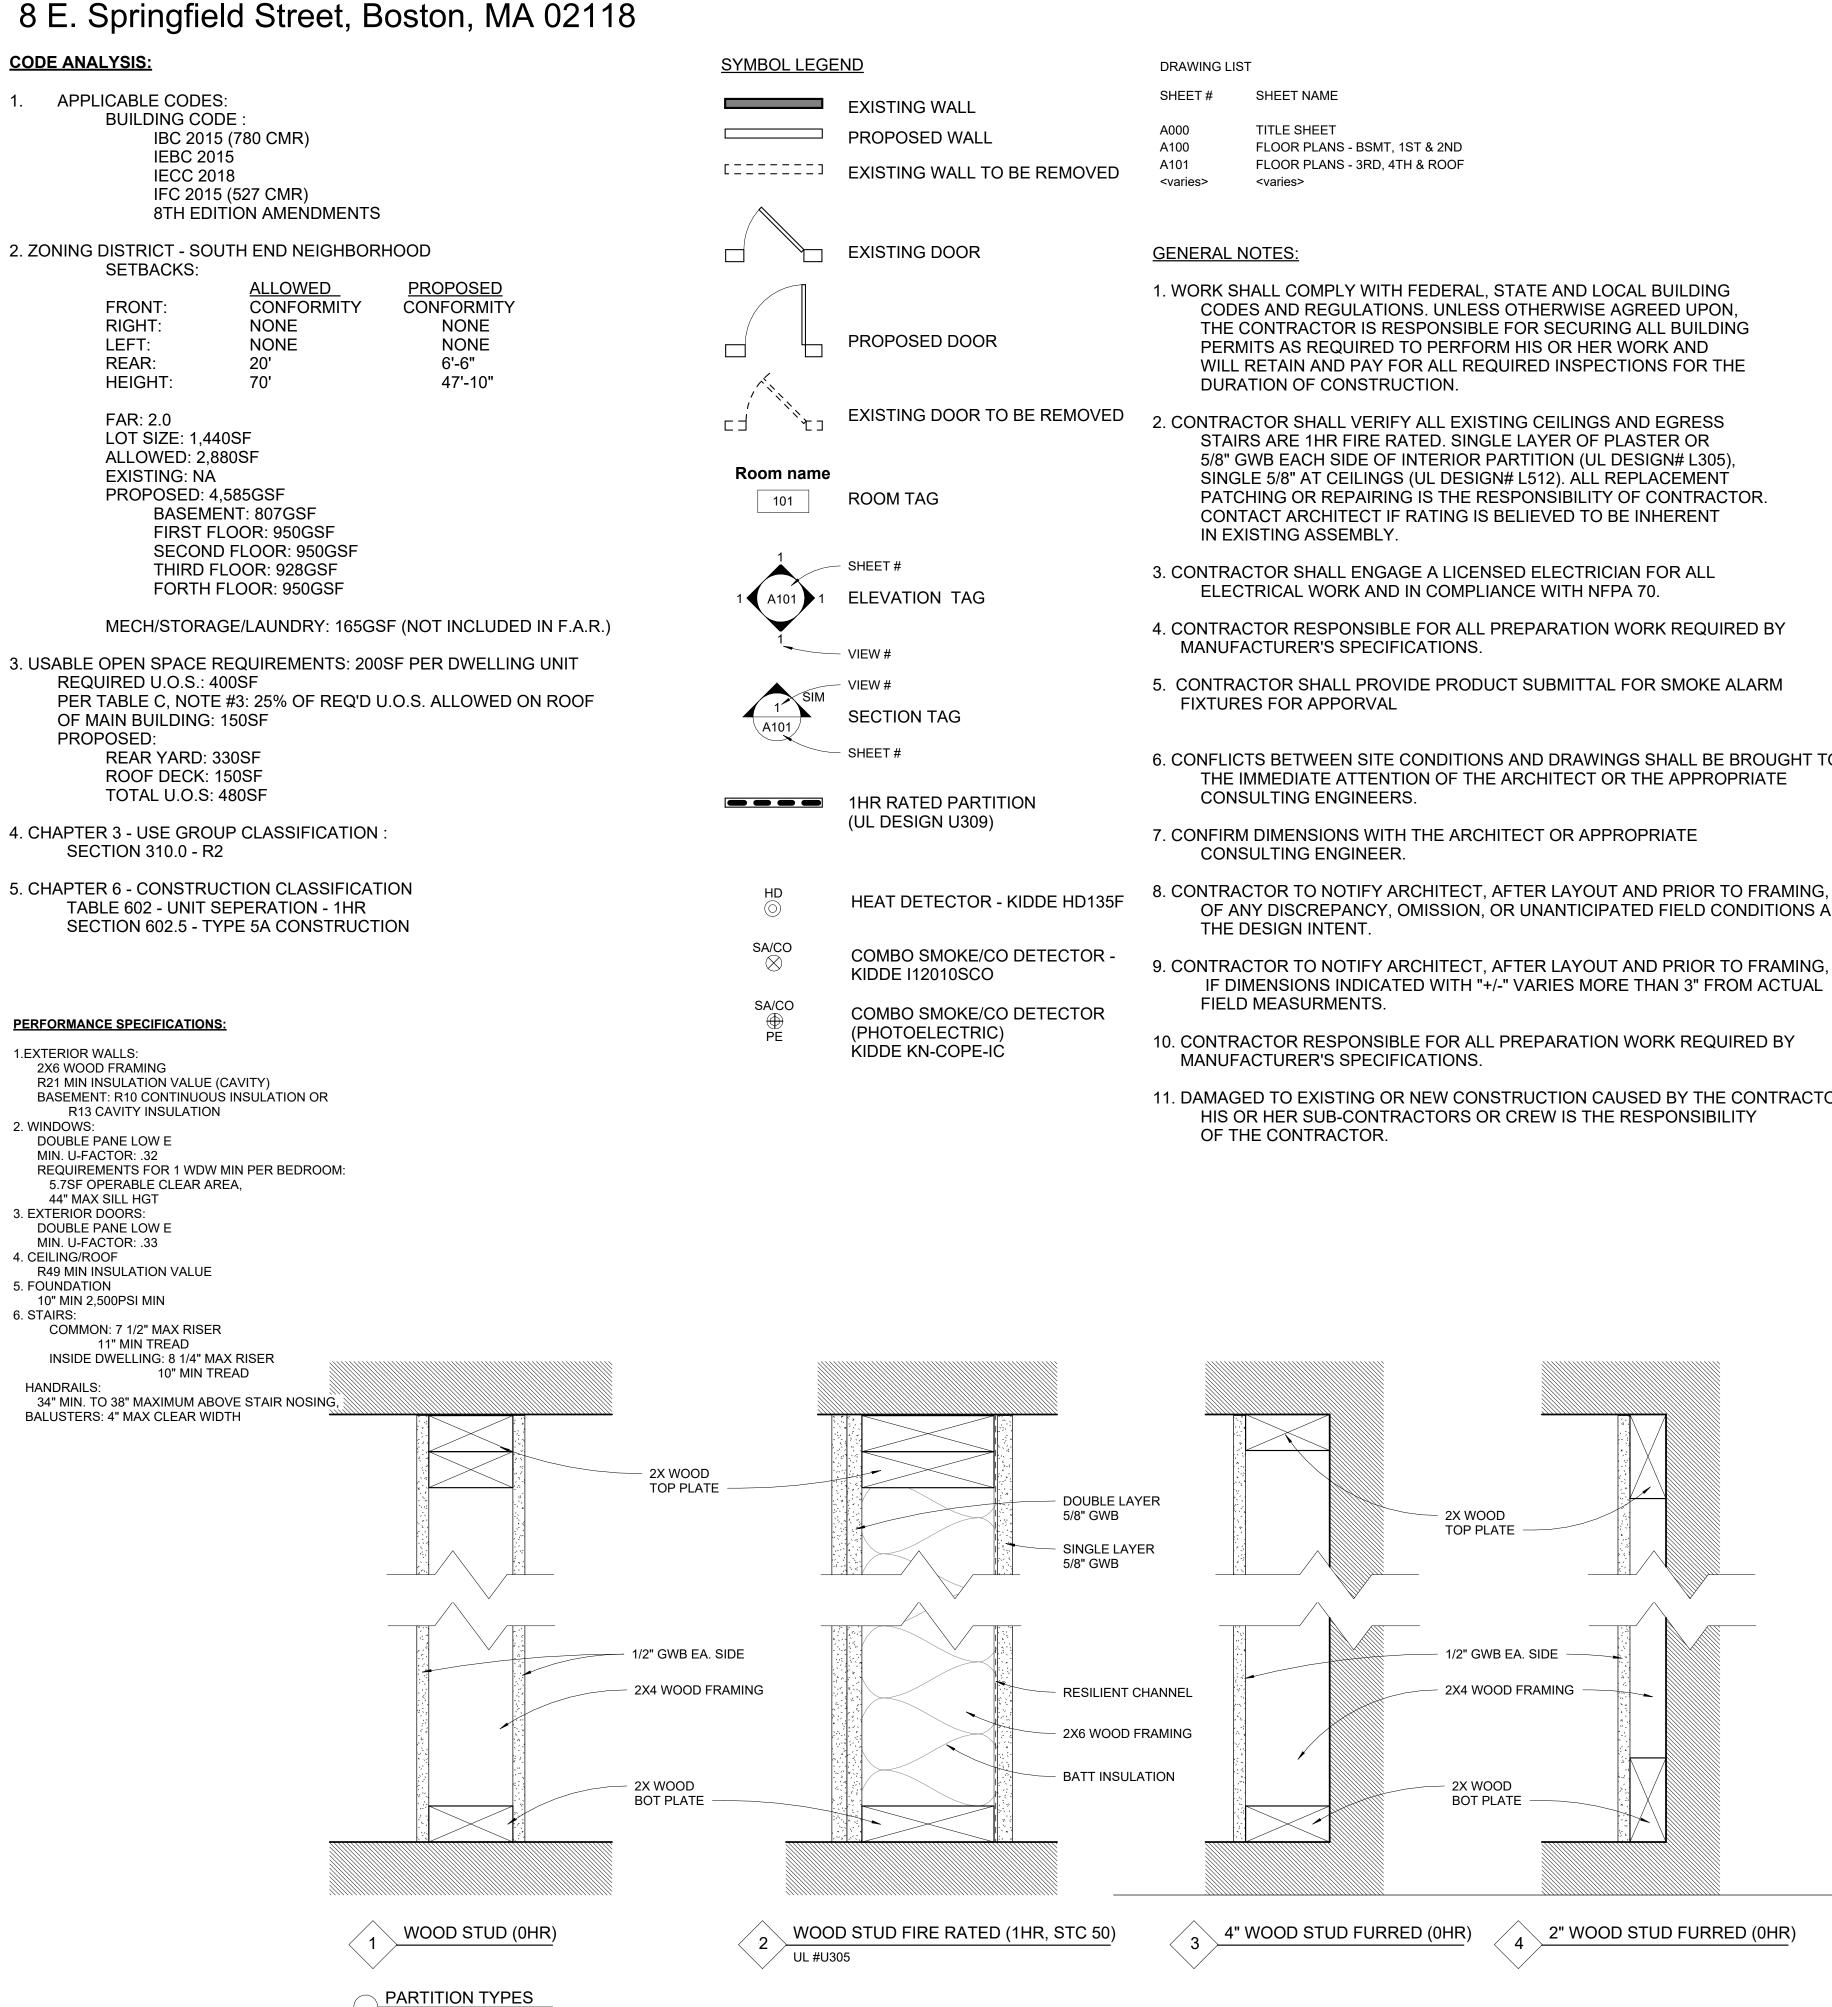

✓ 3" = 1'-0"

SHEET #	SHEET NAME

A000	TITLE SHEET
A100	FLOOR PLANS - BSMT, 1ST & 2ND
A101	FLOOR PLANS - 3RD, 4TH & ROOF
<varies></varies>	<varies></varies>

- 6. CONFLICTS BETWEEN SITE CONDITIONS AND DRAWINGS SHALL BE BROUGHT TO
- OF ANY DISCREPANCY, OMISSION, OR UNANTICIPATED FIELD CONDITIONS ALTER

- 11. DAMAGED TO EXISTING OR NEW CONSTRUCTION CAUSED BY THE CONTRACTOR,



PROJECT: **Springfield Street** Residences 8 Springfield St

Boston, MA 02118

CLIENT: **River Front Realty**

275 Main St Boston, MA

PROJECT TEAM:

DRAWING TITLE:

STAMP

REVISIONS:



No. 2029

BOSTON

February 23, 2024

SELDC APPROVAL


DRAWING NUMBER:

A000

DOCUMENT PHASE

As indicated

ROJECT #

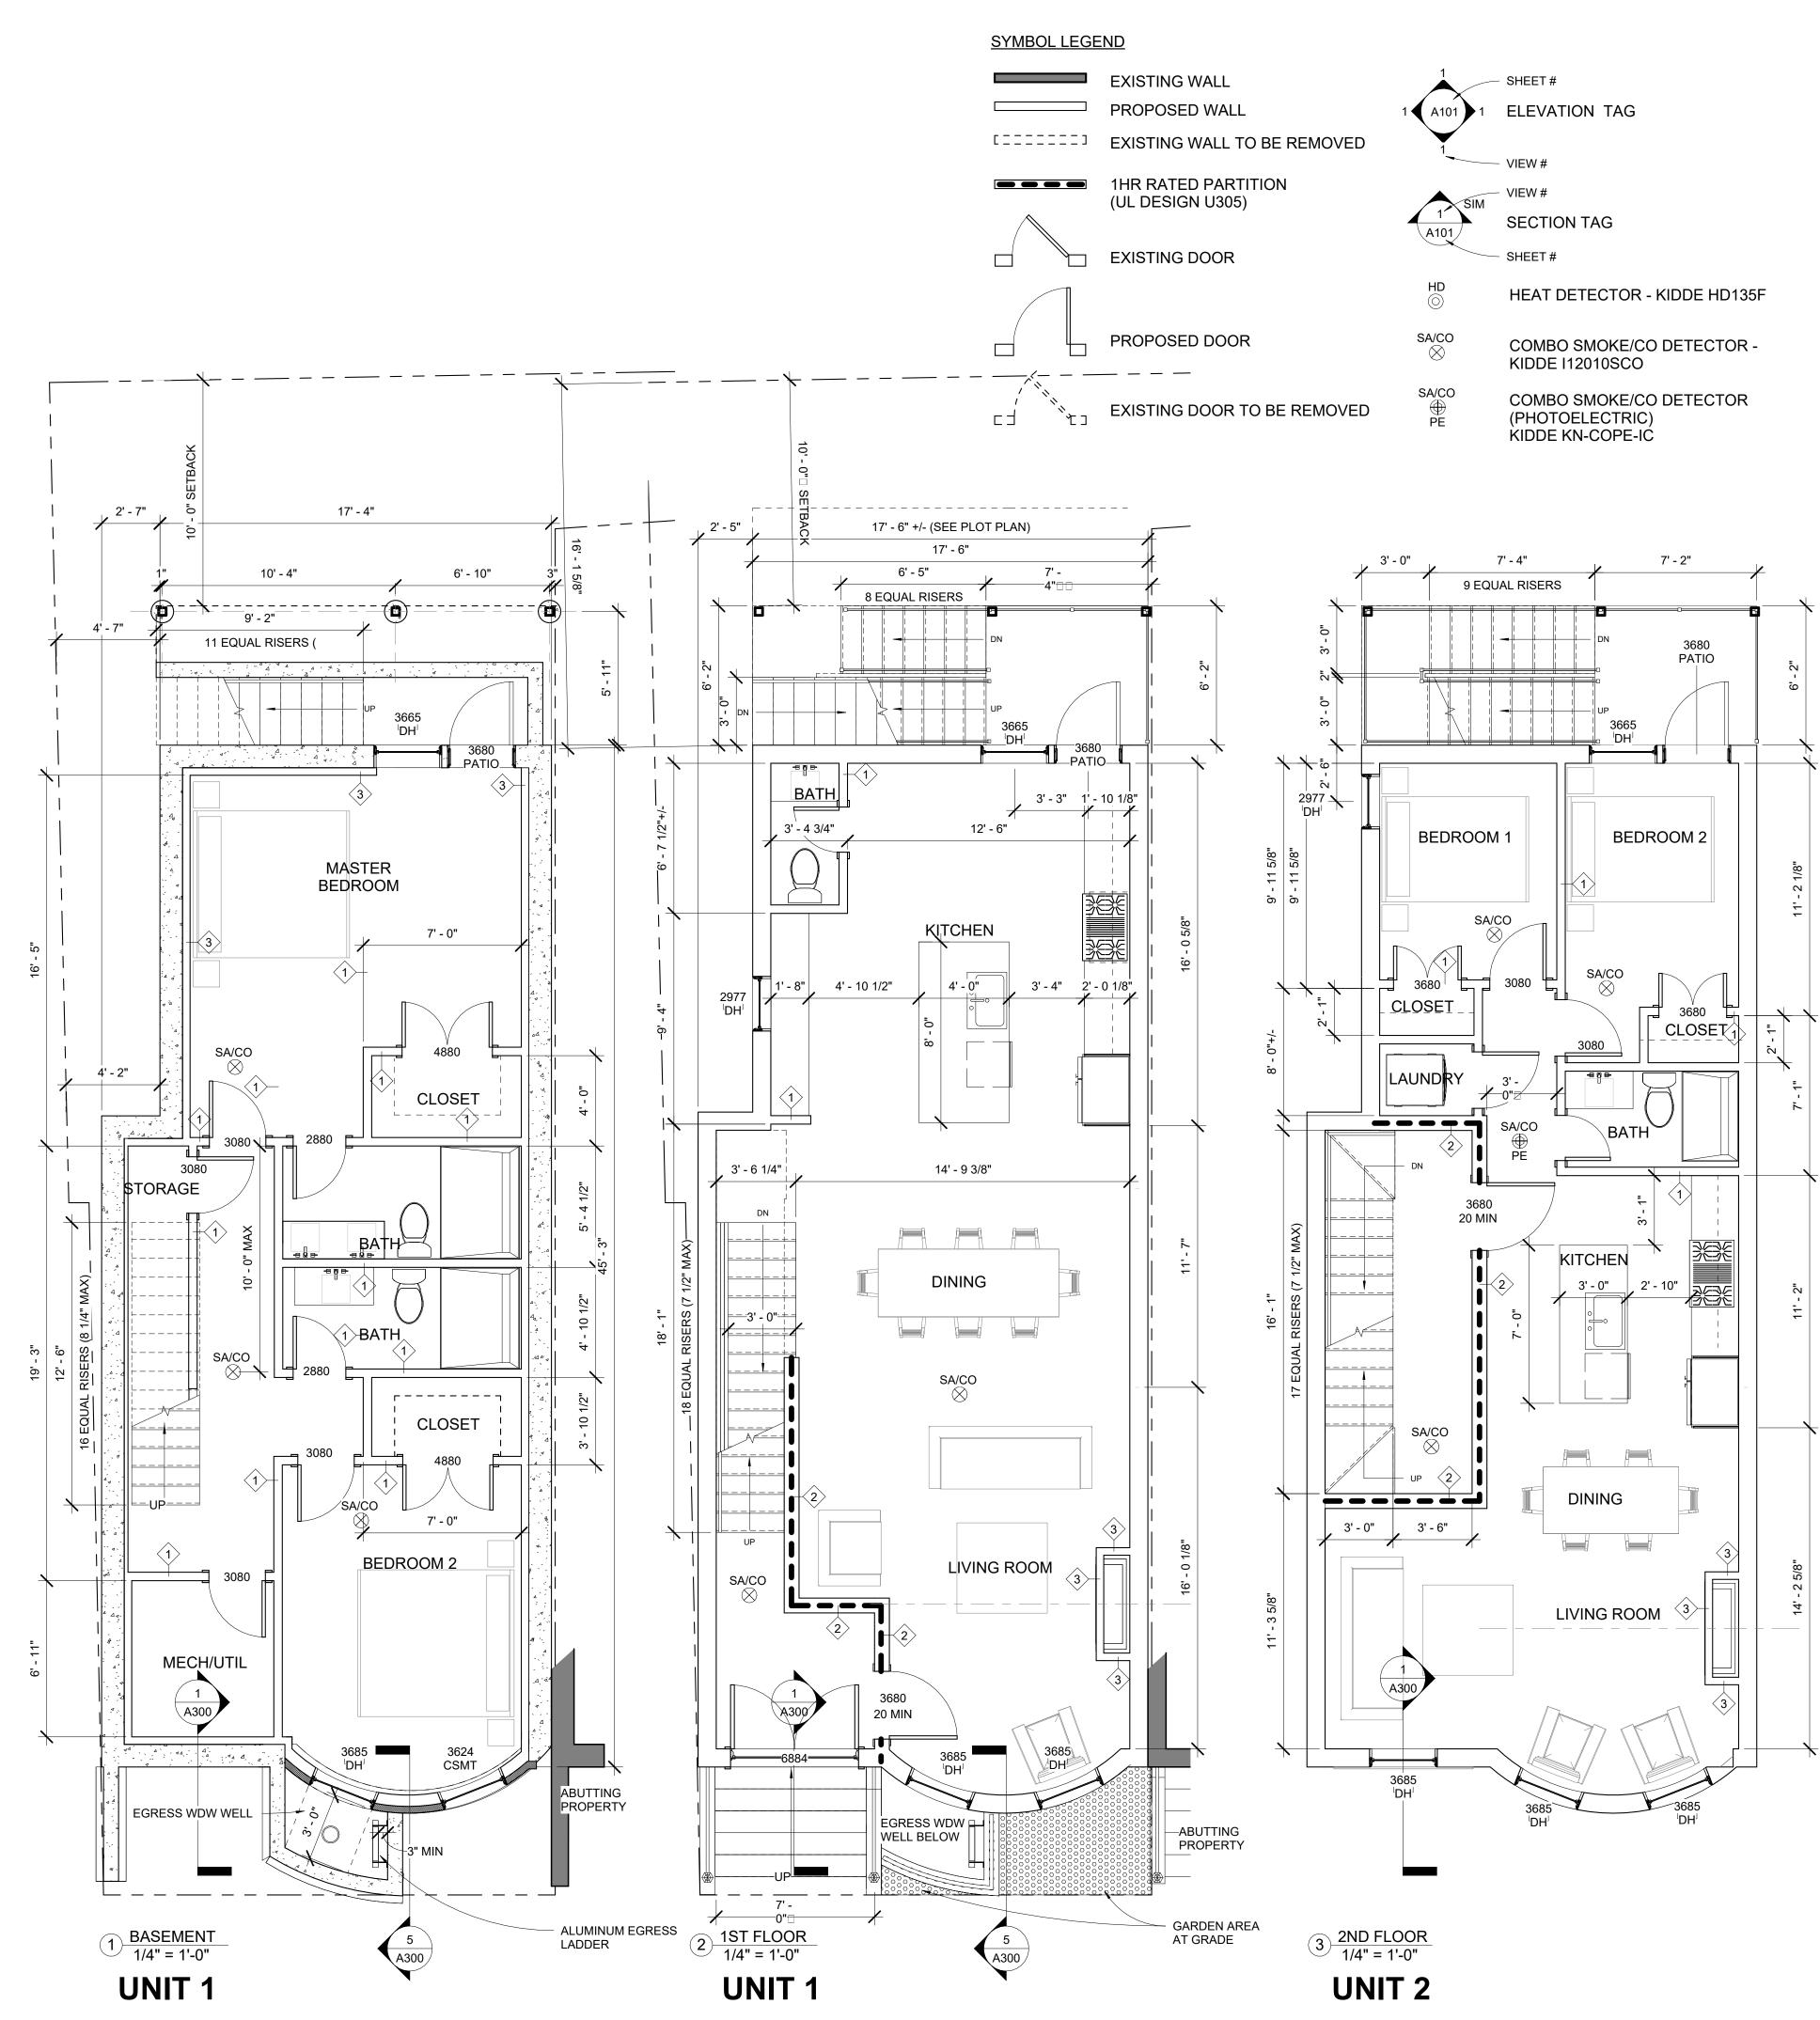

PAE Tem †Co <u>MIN</u> FLO

<u>GEN</u>

1. WC

2. CO

3. CO

4. CO

5. CC

6. CO

7. CO

8. CO


9. CO


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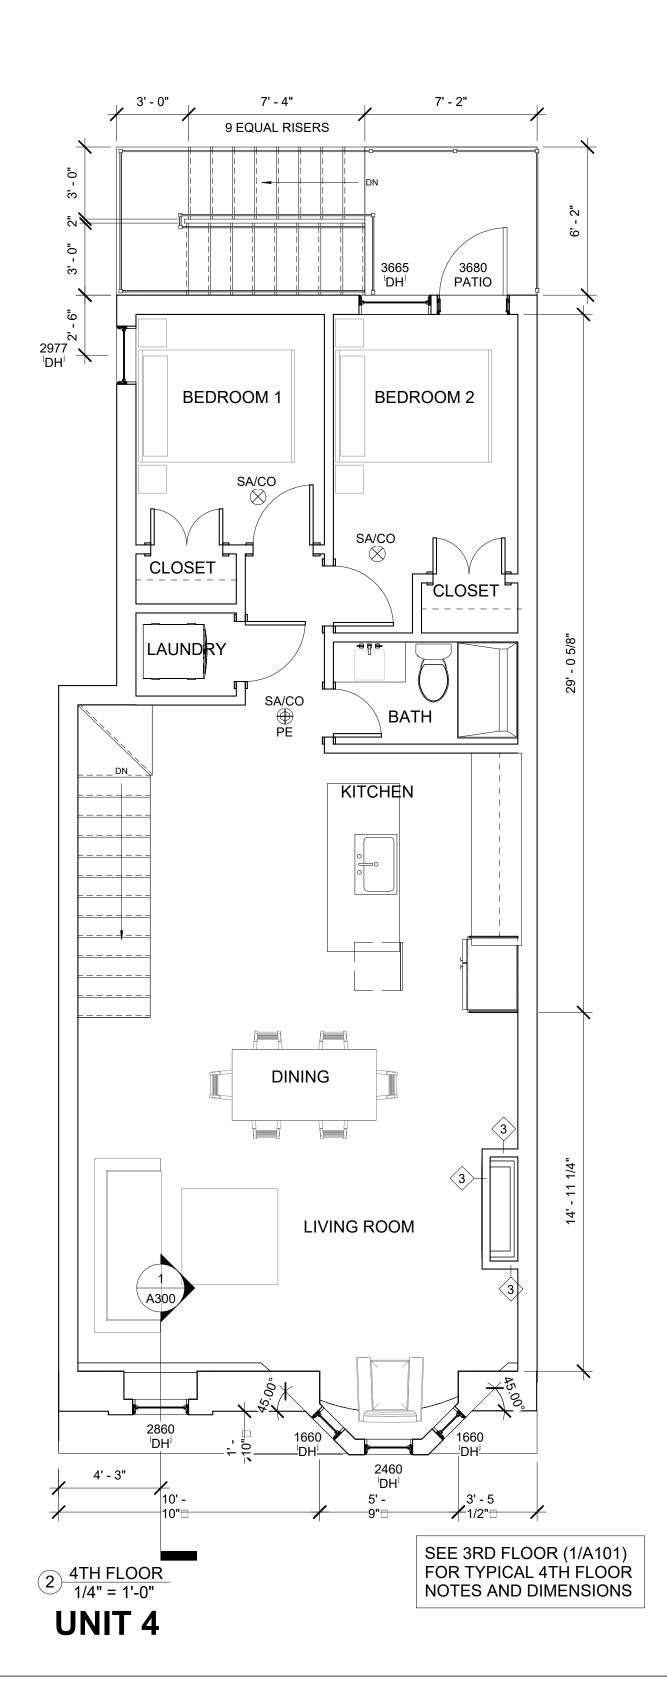
	S47 a
	studio47 architects, inp 517 boston post rd suite #30 sudbury, ma 01776
FLOOR-CEILING SYSTEMS, WOOD-FRAMED GA FILE NO. FC 5116 PROPRIETARY† 1 HOUR 50 to 54 STC	p: 508.500.4730 www.s47a.com
WOOD JOISTS, GYPSUM WALLBOARD, RESILIENT CHANNELS, GLASS FIBER INSULATION	
One layer 5/8" proprietary type X gypsum wallboard or gypsum veneer base applied at right angles to resilient furring channels 24" o.c. with 1" Type S drywall screws 12" o.c. Gypsum board end joints located midway between continuous channels and attached to additional piecess of channel 54" long with screws at 12" o.c. Resilient furring channels applied at right angles to 2 x 10 wood joists 16" o.c. with 1 1/4" Type W drywall screws. Wood joists supporting 5/8" interior plywood with exterior glue subfloor and 1 5/8" perlite-sand concrete	PROJECT: Springfield Street
reinforced with No. 19 SWG galvanized hexagonal wire mesh. 3" glass fiber insulation 0.90 pcf in joist space stapled to subfloor.	Residences 8 Springfield St
PROPRIETARY GYPSUM BOARD Approx. Ceiling American Gypsum Company 5/8" FIREBLOC TYPE C Weight: 2 psf CertainTeed Gypsum, Inc. 5/8" ProRocm Type C Gypsum Panels Fire Test: UL R3453-7, 5-1-70;	Boston, MA 02118
G-P Gypsum 5/8" ToughRock® Fireguard® C Based on UL R3660-7, -8, Lafarge North America Inc. 5/8" Firecheck® Type C 11-12-87; R2717-61, 8-18-87; National Gypsum Company 5/8" Gold Bond® Brand FIRE-SHIELD C™ Based on UL R7094, Grassum Wallboard 90NK10635, 10-24-90; 10-24-90;	
Gypsum Wallboard S0NK 10033, 10-24-90, PABCO Gypsum 5/8" FLAME CURB® Super 'C' Based on UL R8742, Temple-Inland Forest Products Corporation 5/8" FLAME CURB® Super 'C' 88NK22591, 10-6-88; UL Design L516 UL Design L516	
UL Design L514 Sound Test: KAL L 224-28-65, 3-30-65 IIC & Test: (74 C & P)	CLIENT: River Front Realty
+Contact the manufacturer for more detailed information on proprietary products.	275 Main St
MINIMUIM FLOOR ASSEMBLY (STC 50)	Boston, MA
FLOOR-CEILING SYSTEMS, WOOD-FRAMED	
GA FILE NO. FC 5240 GENERIC 1 HOUR 45 to 49 STC FIRE SOUND	
WOOD JOISTS, GYPSUM WALLBOARD, RESILIENT CHANNELS, One layer 1/2" type X gypsum wallboard or gypsum veneer base applied at right angles to resilient furning channels 24" o.c. with 1" Type S drywall screws 12" o.c. Gypsum board end joints located midway between continuous channels and attached to additional pieces of channel 54" long with screws 12" o.c. Resilient furring channels applied at right angles to 2 x 10 wood joists 16" o.c. with 1 1/4" Type W drywall screws. Wood joists supporting 1" nominal T & G wood subfloor and 1" nominal wood finish floor, or 19/32" plywood finished floor with long edges T & G and 15/32" interior plywood	PROJECT TEAM:
with exterior glue subfloor perpendicular to joists with joints staggered.	
Approx. Ceiling	
Weight: 3 psf Fire Test: UL R1319-65, 11-16-64 UL Design, L514	
Sound Test: CK 6512-6, 7, 4-15-65 IIC & Test: 39(67 C & P) CK 6512-6, 4-15-65	
ACCEPTABLE FLOOR ASSEMBLY IF FIELD TESTED (STC45)	
GENERAL NOTES:	
1. WORK SHALL COMPLY WITH FEDERAL, STATE AND LOCAL BUILDING	
CODES AND REGULATIONS. UNLESS OTHERWISE AGREED UPON, THE CONTRACTOR IS RESPONSIBLE FOR SECURING ALL BUILDING PERMITS AS REQUIRED TO PERFORM HIS OR HER WORK AND WILL RETAIN AND PAY FOR ALL REQUIRED INSPECTIONS FOR THE DURATION OF CONSTRUCTION.	
2. CONTRACTOR SHALL VERIFY ALL EXISTING CEILINGS AND EGRESS STAIRS ARE 1HR FIRE RATED. SINGLE LAYER OF PLASTER OR 5/8" GWB EACH SIDE OF INTERIOR PARTITION (UL DESIGN# L305), SINGLE 5/8" AT CEILINGS (UL DESIGN# L512). ALL REPLACEMENT PATCHING OR REPAIRING IS THE RESPONSIBILITY OF CONTRACTOR. CONTACT ARCHITECT IF RATING IS BELIEVED TO BE INHERENT IN EXISTING ASSEMBLY.	REVISIONS:
3. CONTRACTOR SHALL ENGAGE A LICENSED ELECTRICIAN FOR ALL ELECTRICAL WORK AND IN COMPLIANCE WITH NFPA 70.	
4. CONTRACTOR RESPONSIBLE FOR ALL PREPARATION WORK REQUIRED BY MANUFACTURER'S SPECIFICATIONS.	
5. CONTRACTOR SHALL PROVIDE PRODUCT SUBMITTAL FOR SMOKE ALARM FIXTURES FOR APPORVAL	DRAWING TITLE:
6. CONFLICTS BETWEEN SITE CONDITIONS AND DRAWINGS SHALL BE BROUGHT TO THE IMMEDIATE ATTENTION OF THE ARCHITECT OR THE APPROPRIATE CONSULTING ENGINEERS.	PLANS - BSMT, 1ST & 2ND
7. CONFIRM DIMENSIONS WITH THE ARCHITECT OR APPROPRIATE CONSULTING ENGINEER.	
8. CONTRACTOR TO NOTIFY ARCHITECT, AFTER LAYOUT AND PRIOR TO FRAMING, OF ANY DISCREPANCY, OMISSION, OR UNANTICIPATED FIELD CONDITIONS ALTER THE DESIGN INTENT.	STAMP
9. CONTRACTOR TO NOTIFY ARCHITECT, AFTER LAYOUT AND PRIOR TO FRAMING, IF DIMENSIONS INDICATED WITH "+/-" VARIES MORE THAN 3" FROM ACTUAL FIELD MEASURMENTS.	CONNEL NO. 20293 BOSTON
10. CONTRACTOR RESPONSIBLE FOR ALL PREPARATION WORK REQUIRED BY MANUFACTURER'S SPECIFICATIONS.	THE OF MASSING
11. DAMAGED TO EXISTING OR NEW CONSTRUCTION CAUSED BY THE CONTRACTOR, HIS OR HER SUB-CONTRACTORS OR CREW IS THE RESPONSIBILITY OF THE CONTRACTOR.	February 23, 2024 DATE OF ISSUE SELDC APPROVAL DOCUMENT PHASE
\mathcal{A}	<u>1/4" = 1'-0"</u> SCALE 2318.00
	2310.00 PROJECT #
	DRAWING NUMBER:
	A100

ARCHITECT






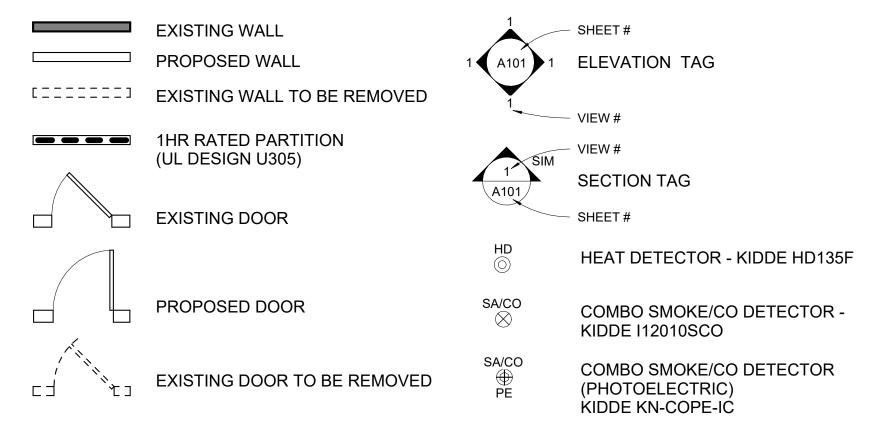

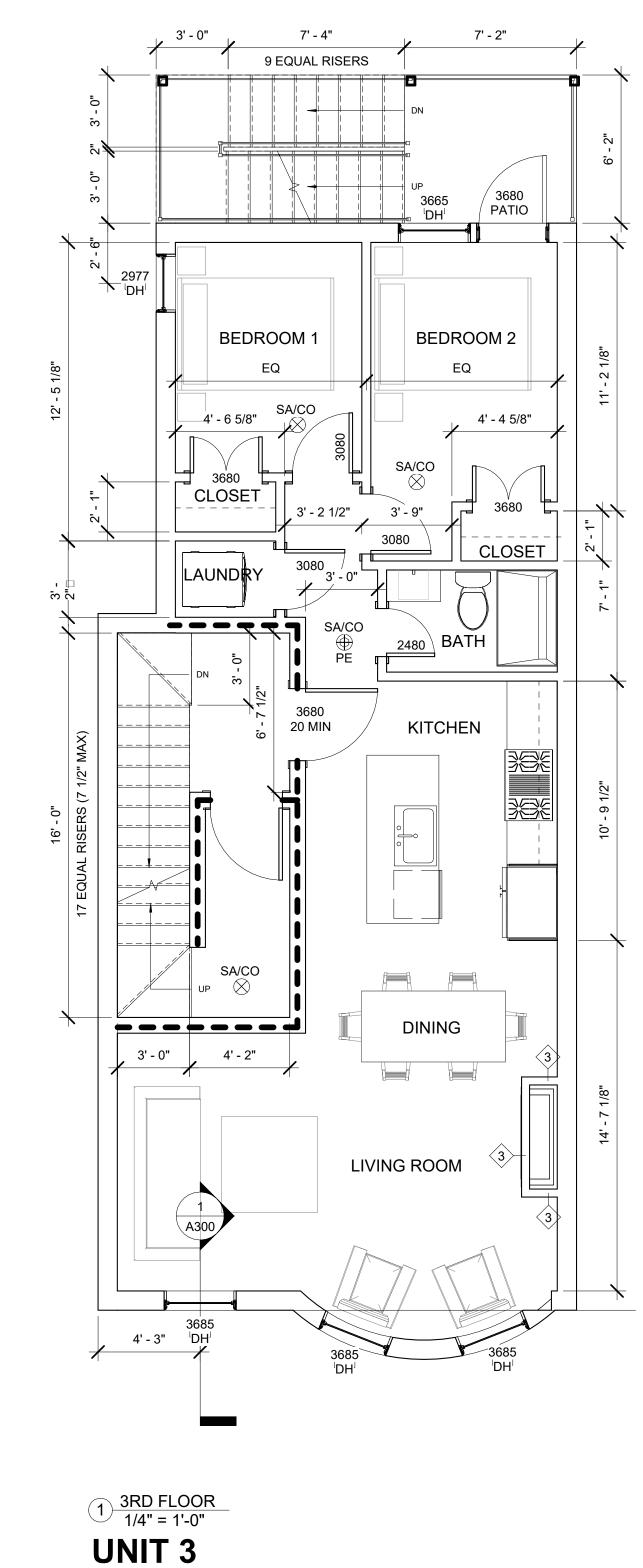

SYMBOL LEGEND

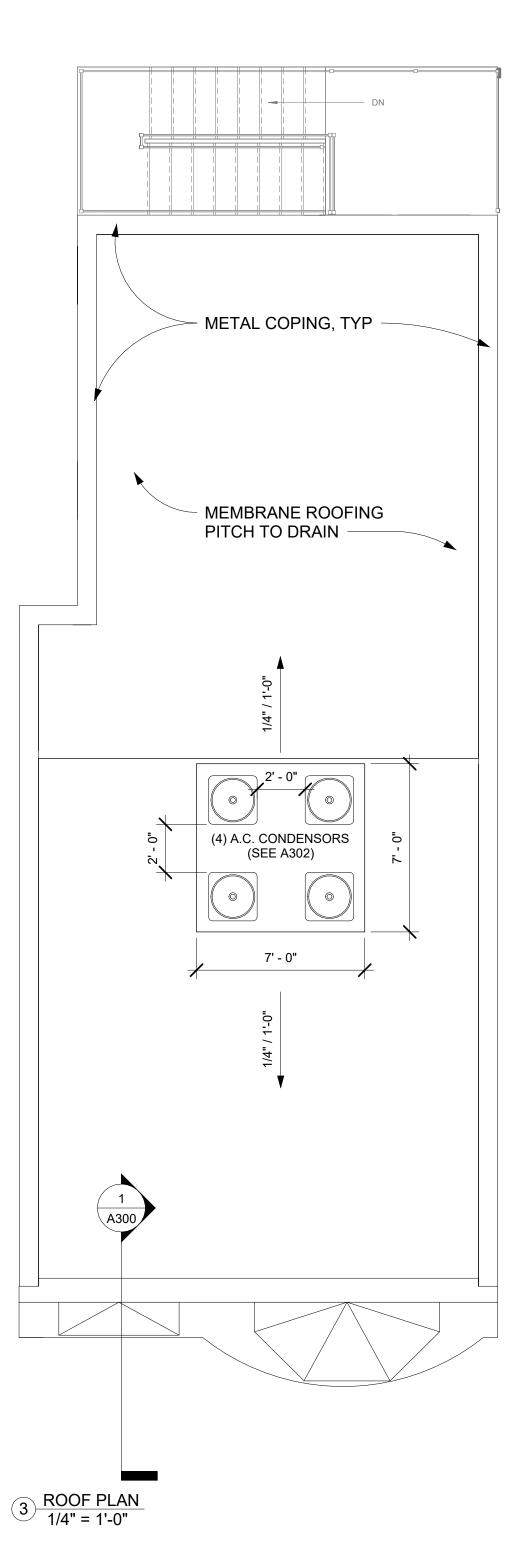

An Ce G-I Laf Na
PA Tei
†C
M
FL

<u>AC(</u>

<u>GENE</u>

1. WC

2. CO

3. CO

4. CO

5. CC

6. CO


7. CO

8. CO

9. CO

11. D

FLOOR-CEILING SYSTEMS, WOOD-FRAMED	ARCHITECT 547 a studio47 architects, inp 517 boston post rd suite #30 sudbury, ma 01776 p: 508.500.4730
GA FILE NO. FC 5116 PROPRIETARY† 1 HOUR 50 to 54 STC WOOD LOISTE OVERUM WALL BOARD DESULIENT CHANNELS FIRE SOUND	www.s47a.com
WOOD JOISTS, GYPSUM WALLBOARD, RESILIENT CHANNELS, GLASS FIBER INSULATION One layer 5/8" proprietary type X gypsum wallboard or gypsum veneer base applied at right angles to resilient furring channels 24" o.c. with 1" Type S drywall screws 12" o.c. Gypsum board end joints located midway between continuous channels and attached to additional pieces of channel 54" long with screws at 12" o.c. Resilient furring channels applied at right angles to 2 x 10 wood joists 16" o.c. with 1 1/4" Type W drywall screws. Wood joists supporting 5/8" interior plywood with exterior glue subfloor and 1 5/8" perlite-sand concrete reinforced with No. 19 SWG galvanized hexagonal wire mesh. 3" glass fiber insulation 0.90 pcf in joist space stapled to subfloor.	PROJECT: Springfield Street Residences 8 Springfield St
PROPRIETARY GYPSUM BOARDApprox. CeilingAmerican Gypsum Company5/8" FIREBLOC TYPE CCertainTeed Gypsum, Inc.5/8" ProRocTM Type C Gypsum PanelsG-P Gypsum5/8" ToughRock® Fireguard® CLafarge North America Inc.5/8" ToughRock® Fireguard® CNational Gypsum Company5/8" Gold Bond® Brand FIRE-SHIELD CTMGypsum5/8" Gold Bond® Brand FIRE-SHIELD CTMGypsumGypsum WallboardPABCO Gypsum5/8" FLAME CURB® Super 'C'Temple-Inland Forest Products Corporation5/8" FLAME CURB® Super 'C'Start Products Corporation5/8" TG-CUL Design L516	Boston, MA 02118
UL Design L514 Sound Test: KAL L 224-28-65, 3-30-65 IIC & Test: (74 C & P) KAL L 224-27-65, 3-30-65	CLIENT: River Front Realty
†Contact the manufacturer for more detailed information on proprietary products. MINIMUIM FLOOR ASSEMBLY (STC 50)	275 Main St Boston, MA
Subscription Subscription GA FILE NO. FC 5240 GENERIC WOOD JOISTS, GYPSUM WALLBOARD, RESILIENT CHANNELS, 1 HOUR One layer 1/2" type X gypsum wallboard or gypsum veneer base applied at right angles to resilient furning channels 24" o.c. with 1" Type S drywall screws 12" o.c. Gypsum board end joints located midway between continuous channels and attached to additional pieces of channel 54" long with screws 12" o.c. Resilient furring channels applied at right angles to 2 x 10 wood joists 16" o.c. with 1 1/4" Type W drywall screws. Wood joists supporting 1" nominal T & G wood subfloor and 1" nominal wood finish floor, or 19/32" plywood finished floor with long edges T & G and 15/32" interior plywood with exterior glue subfloor perpendicular to joists with joints staggered. 1 HOUR fine	PROJECT TEAM:
Approx. Ceiling Weight: 3 psf Fire Test: UL R1319-65, 11-16-64 UL Design, L514 Sound Test: CK 6512-6, 7, 4-15-65 IIC & Test: 39(67 C & P) CK 6512-6, 4-15-65	
ACCEPTABLE FLOOR ASSEMBLY IF FIELD TESTED (STC45)	
GENERAL NOTES: 1. WORK SHALL COMPLY WITH FEDERAL, STATE AND LOCAL BUILDING CODES AND REGULATIONS. UNLESS OTHERWISE AGREED UPON, THE CONTRACTOR IS RESPONSIBLE FOR SECURING ALL BUILDING PERMITS AS REQUIRED TO PERFORM HIS OR HER WORK AND WILL RETAIN AND PAY FOR ALL REQUIRED INSPECTIONS FOR THE DURATION OF CONSTRUCTION.	
2. CONTRACTOR SHALL VERIFY ALL EXISTING CEILINGS AND EGRESS STAIRS ARE 1HR FIRE RATED. SINGLE LAYER OF PLASTER OR 5/8" GWB EACH SIDE OF INTERIOR PARTITION (UL DESIGN# L305), SINGLE 5/8" AT CEILINGS (UL DESIGN# L512). ALL REPLACEMENT PATCHING OR REPAIRING IS THE RESPONSIBILITY OF CONTRACTOR. CONTACT ARCHITECT IF RATING IS BELIEVED TO BE INHERENT IN EXISTING ASSEMBLY.	REVISIONS:
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5. CONTRACTOR SHALL PROVIDE PRODUCT SUBMITTAL FOR SMOKE ALARM FIXTURES FOR APPORVAL	DRAWING TITLE:
6. CONFLICTS BETWEEN SITE CONDITIONS AND DRAWINGS SHALL BE BROUGHT TO THE IMMEDIATE ATTENTION OF THE ARCHITECT OR THE APPROPRIATE CONSULTING ENGINEERS.	PLANS - 3RD, 4TH & ROOF
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9. CONTRACTOR TO NOTIFY ARCHITECT, AFTER LAYOUT AND PRIOR TO FRAMING, IF DIMENSIONS INDICATED WITH "+/-" VARIES MORE THAN 3" FROM ACTUAL FIELD MEASURMENTS.	No. 20293 BOSTON BOSTON
10. CONTRACTOR RESPONSIBLE FOR ALL PREPARATION WORK REQUIRED BY MANUFACTURER'S SPECIFICATIONS.	THE OF MARSHE
11. DAMAGED TO EXISTING OR NEW CONSTRUCTION CAUSED BY THE CONTRACTOR, HIS OR HER SUB-CONTRACTORS OR CREW IS THE RESPONSIBILITY OF THE CONTRACTOR.	February 23, 2024DATE OF ISSUESELDC APPROVALDOCUMENT PHASE1/4" = 1'-0"SCALE2318.00PROJECT #
	A101

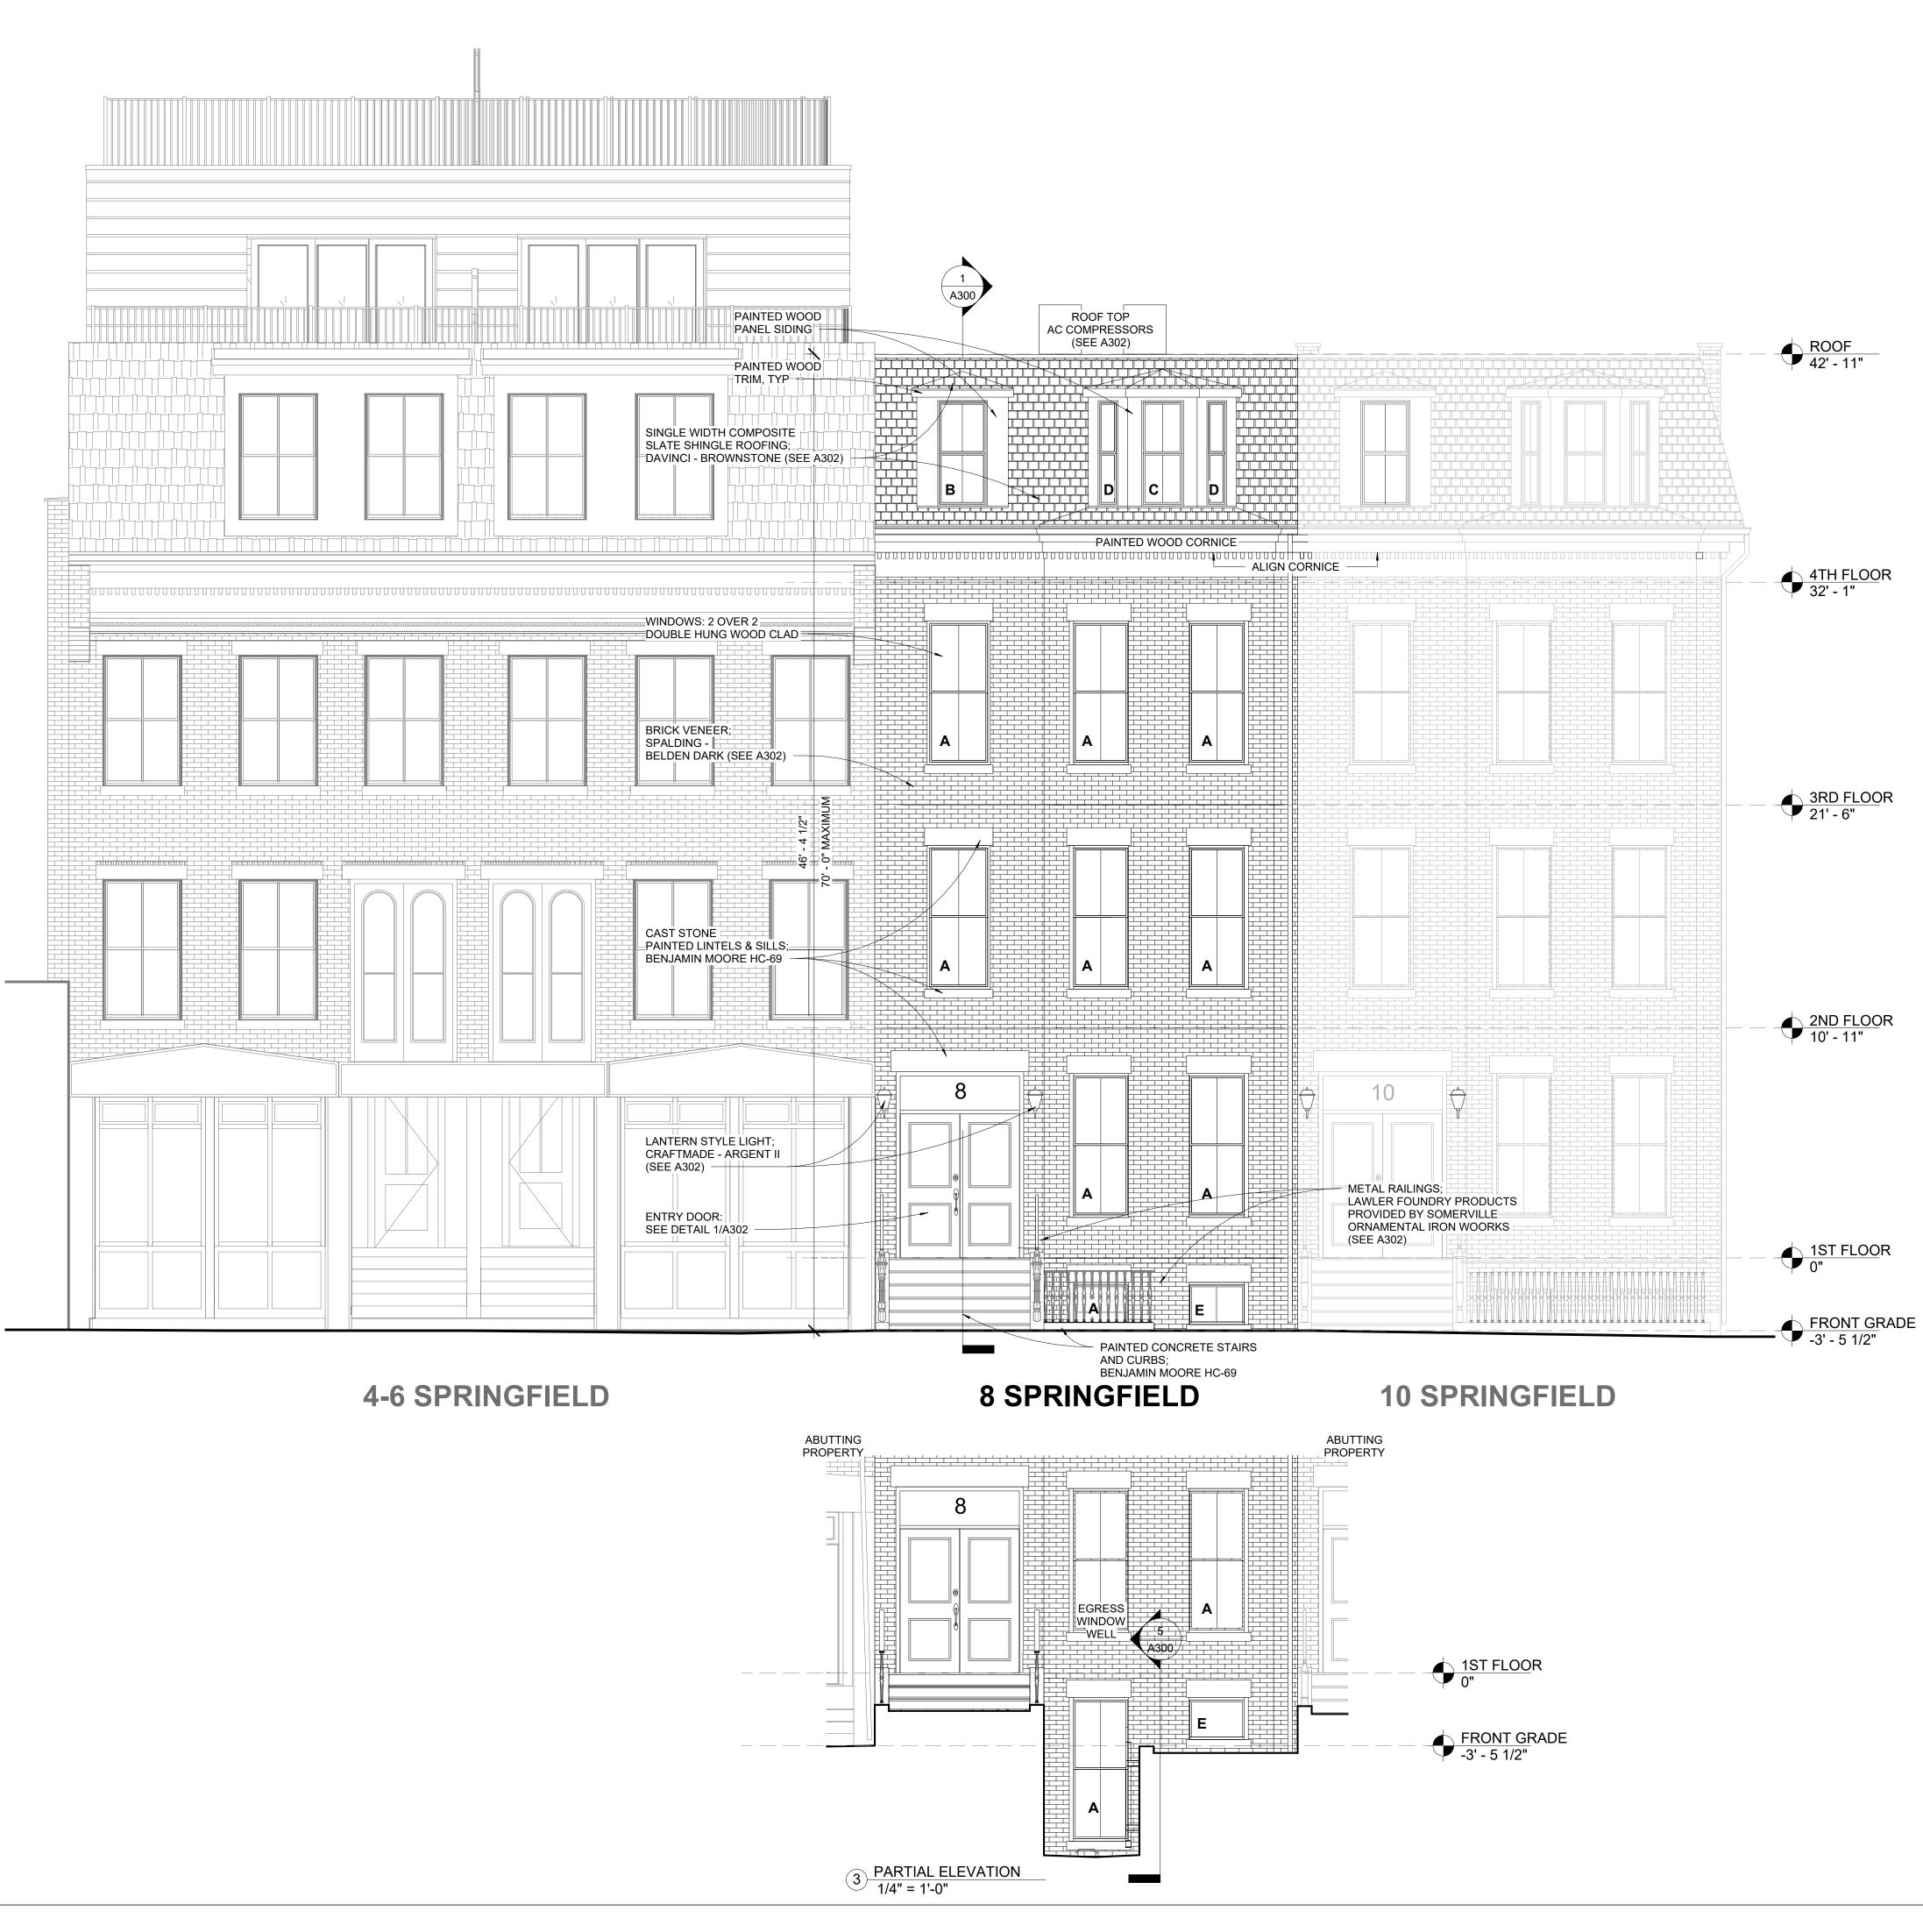

SOUTH END LANDMARK DISTRICT STANDARDS AND CRITERIA (INFORMATIONAL PURPOSES ONLY)

II. NEW CONSTRUCTION

A. GENERAL STATEMENT OF INTENT 1. The District contains vacant parcels of varying sizes and shapes, many of which once held rowhouses. New construction on these sites have a potential for reinforcing and enhancing the streetscape of the South End. Inappropriate design could introduce the intrusive elements of incompatible bulk, material and detail. To insure that new construction has a positive effect on the historic physical character of the Landmark District, proposals for new construction will be reviewed for compatibility with the existing architecture in such critical factors as land coverage, bulk, material, and proportion. Therefore, the focus of the standards and criteria is on the compatibility of new construction with the existing character of the South End without dictating style or taste.

2. Plans of proposed new construction shall be submitted to the South End District Subcommission for review. A building permit may not be issued prior to the issuance of a Certificate of Design Approval or of Exemption.

3. These regulations shall apply only to facades visible from a public street or avenue, existing or proposed, in accordance with Sections 1.A., 3 and 5.

4. For buildings of monumental character, such as schools, churches, or other institutional uses, the Commission may waive portions of these standards and criteria which it deems to be inappropriate. The standards and criteria pertaining to height and materials shall be enforced. Where a new non-residential building has frontage on a block of predominantly residential rowhouse character, the Commission may require stricter adherence to these standards and criteria for that frontage alone.

5. The Landmark Commission shall determine the required degree on conformity of the new construction to the architecture of adjacent buildings, according to the strength of the existing neighborhood design and the configuration of the parcels to be developed. The applicable definitions and intent of the two categories are as follows:

a. Category A, defined as any vacant parcel or collection of parcels that share a party wall with an existing structure. Within this category, stricter conformity will be required of the new construction on the narrower parcels, especially those with existing buildings adjoining two sides, corner parcels, and parcels on a block of exceptionally strong or uniform character.

b. Category B, defined as any parcel or group of parcels which is not abutted by an existing structure. Within this category, less strict conformity to existing neighborhood design will be required. 6. Traditional architectural designs are permitted if in nineteenth century styles which are appropriate to

the Landmark District, but shall not be expressly required by these standards and criteria. 7. These regulations shall not be deemed to supplant or nullify provisions of the Boston Zoning Ordinance or Sign Code, beyond the immediate scope of these provisions, nor any portion of the Massachusetts Building Code.

B. HEIGHTS

1. The maximum height of any new construction shall be seventy feet, and minimum shall be thirty feet, the latter being exclusive of ells.

- 2. Within this limitation, the following shall apply to any new construction on parcels in Category A: a. The new building shall have the same height and cornice line as adjacent existing buildings having
- common property lines. b. In the event a new building has two such abutters of differing heights and cornice lines, it shall conform to one of them, or it may step to match, i.e., each at the common property line.
- c. In the event the height of the adjacent existing building is greater or smaller than the overall limitation, or is radically different from the remainder of the block, the Commission may set the height for the new building.

C. SETBACK:

- 1. The maximum setback for a new building shall be ten feet, except as follows: a. A new building in Category A shall have the same setback as adjacent buildings having common property lines.
- b. In the event a new building in Category A has two such abutters with different setbacks, it shall have the same setback as one of them, or it may step to match both of them. c. A corner building in Category A shall have the same setback as its abutters on the primary
- frontage. No setback is required on the secondary frontage; if one is provided, it shall be the same as the adjacent building on the secondary frontage.

D. LOT COVERAGE:

A new building shall occupy the full width of its primary frontage, at the property or setback line.

E. BUILDING MATERIALS:

The following materials shall be required on all exterior surfaces within the scope of these regulations:

- 1. Walls shall be of masonry construction similar in color and texture to the majority of adjacent buildings. In general, smooth-textured red brick in standard size and coursing is acceptable; a standard brick being defined as 2 ¹/₄" x 4"x8", nominal dimension. Other materials will be judged on their own merits and the neighborhood design context.
- 2. Exterior steps shall be of stone, or concrete having the appearance of stone on exposed surfaces. Lintels and sills, if expressed, shall be of similar material.
- 3. Cornices, if expressed, shall be of brick, wood or a combination thereof. If metal is used as a flashing or covering, it shall be of an appropriate finish or color; white or shiny metal other than copper is unacceptable.
- 4. Windows, storm sash and trim shall be wood or anodized aluminum in appropriate colors and finishes; white or shiny metal is unacceptable
- 5. Visible roofs, such as mansards and gables, shall be of slate or of composition shingle similar in appearance to slate. Metal may be allowed if subdued in color and detail; white or shiny metal other than copper is unacceptable.

2. Window openings shall approximate the number, size and positioning of those of its abutters. The vertical dimension of the opening should exceed the horizontal. 3. The entrance doorway shall approximate those of adjacent buildings in overall size, proportion and

position. 4. For new buildings in either category, the use of elements which give the existing buildings of the district their essential character is recommended. Where used, they should approximate the proportions and materials of the existing buildings. These elements include, but are not limited to the following:

- a. Bay, bow, oriel, and dormer windows
- b. Mansard and gable roofs c. Cornices
- d. Exterior steps
- e. Decorative ironwork, railings and fences
- f. Recessed doorways
- g. Entrance canopies
- h. Chimneys
- i. Exterior lighting

5. It is not required that new buildings on the larger parcels in Category A or B conform internally to the narrow rowhouse configuration typical of the district. It is recommended that such larger buildings avoid the appearance of monolithic apartment blocks through the use of design elements characteristic of the rowhouse blocks. Entrance doorways and steps should occur at a maximum of 45 feet on center; a more frequent spacing of 18 to 28 feet is recommended; the use of repeating bay, bow or oriels is especially recommended.

III. PUBLIC AREAS

A. GENERAL

The intent is to retain and improve those aspects of the public areas which contribute to and enhance the character of the South End. Alterations to existing street layouts or proposed new streets must be reviewed for conformance to the criteria below: 1. Sidewalks and Curbs:

- a. Public sidewalks should be designed and constructed to reinforce the character of the district.
- b. Granite and brick are preferred materials, but concrete walking surface may be allowed after review. Existing brick sidewalks must be repaired and restored. New or repaired concrete sidewalks must be approved for color or tone, and may not be patched with asphalt. c. Granite curbs must be retained and reused wherever possible.
- d. Existing sidewalks shall not be reduced in width.
- e. Permanent use of Jersey barriers is not allowed.



PROJECT: **Springfield Street** Residences

8 Springfield St Boston, MA 02118

CLIENT: **River Front Realty**

275 Main St Boston, MA

PROJECT TEAM:

DRAWING TITLE:


REVISIONS:

EXTERIOR ELEVATIONS

STAMP	
February 23, 2024	
SELDC APPROVAL	
<u>1/4" = 1'-0"</u> SCALE	
2318.00 PROJECT #	


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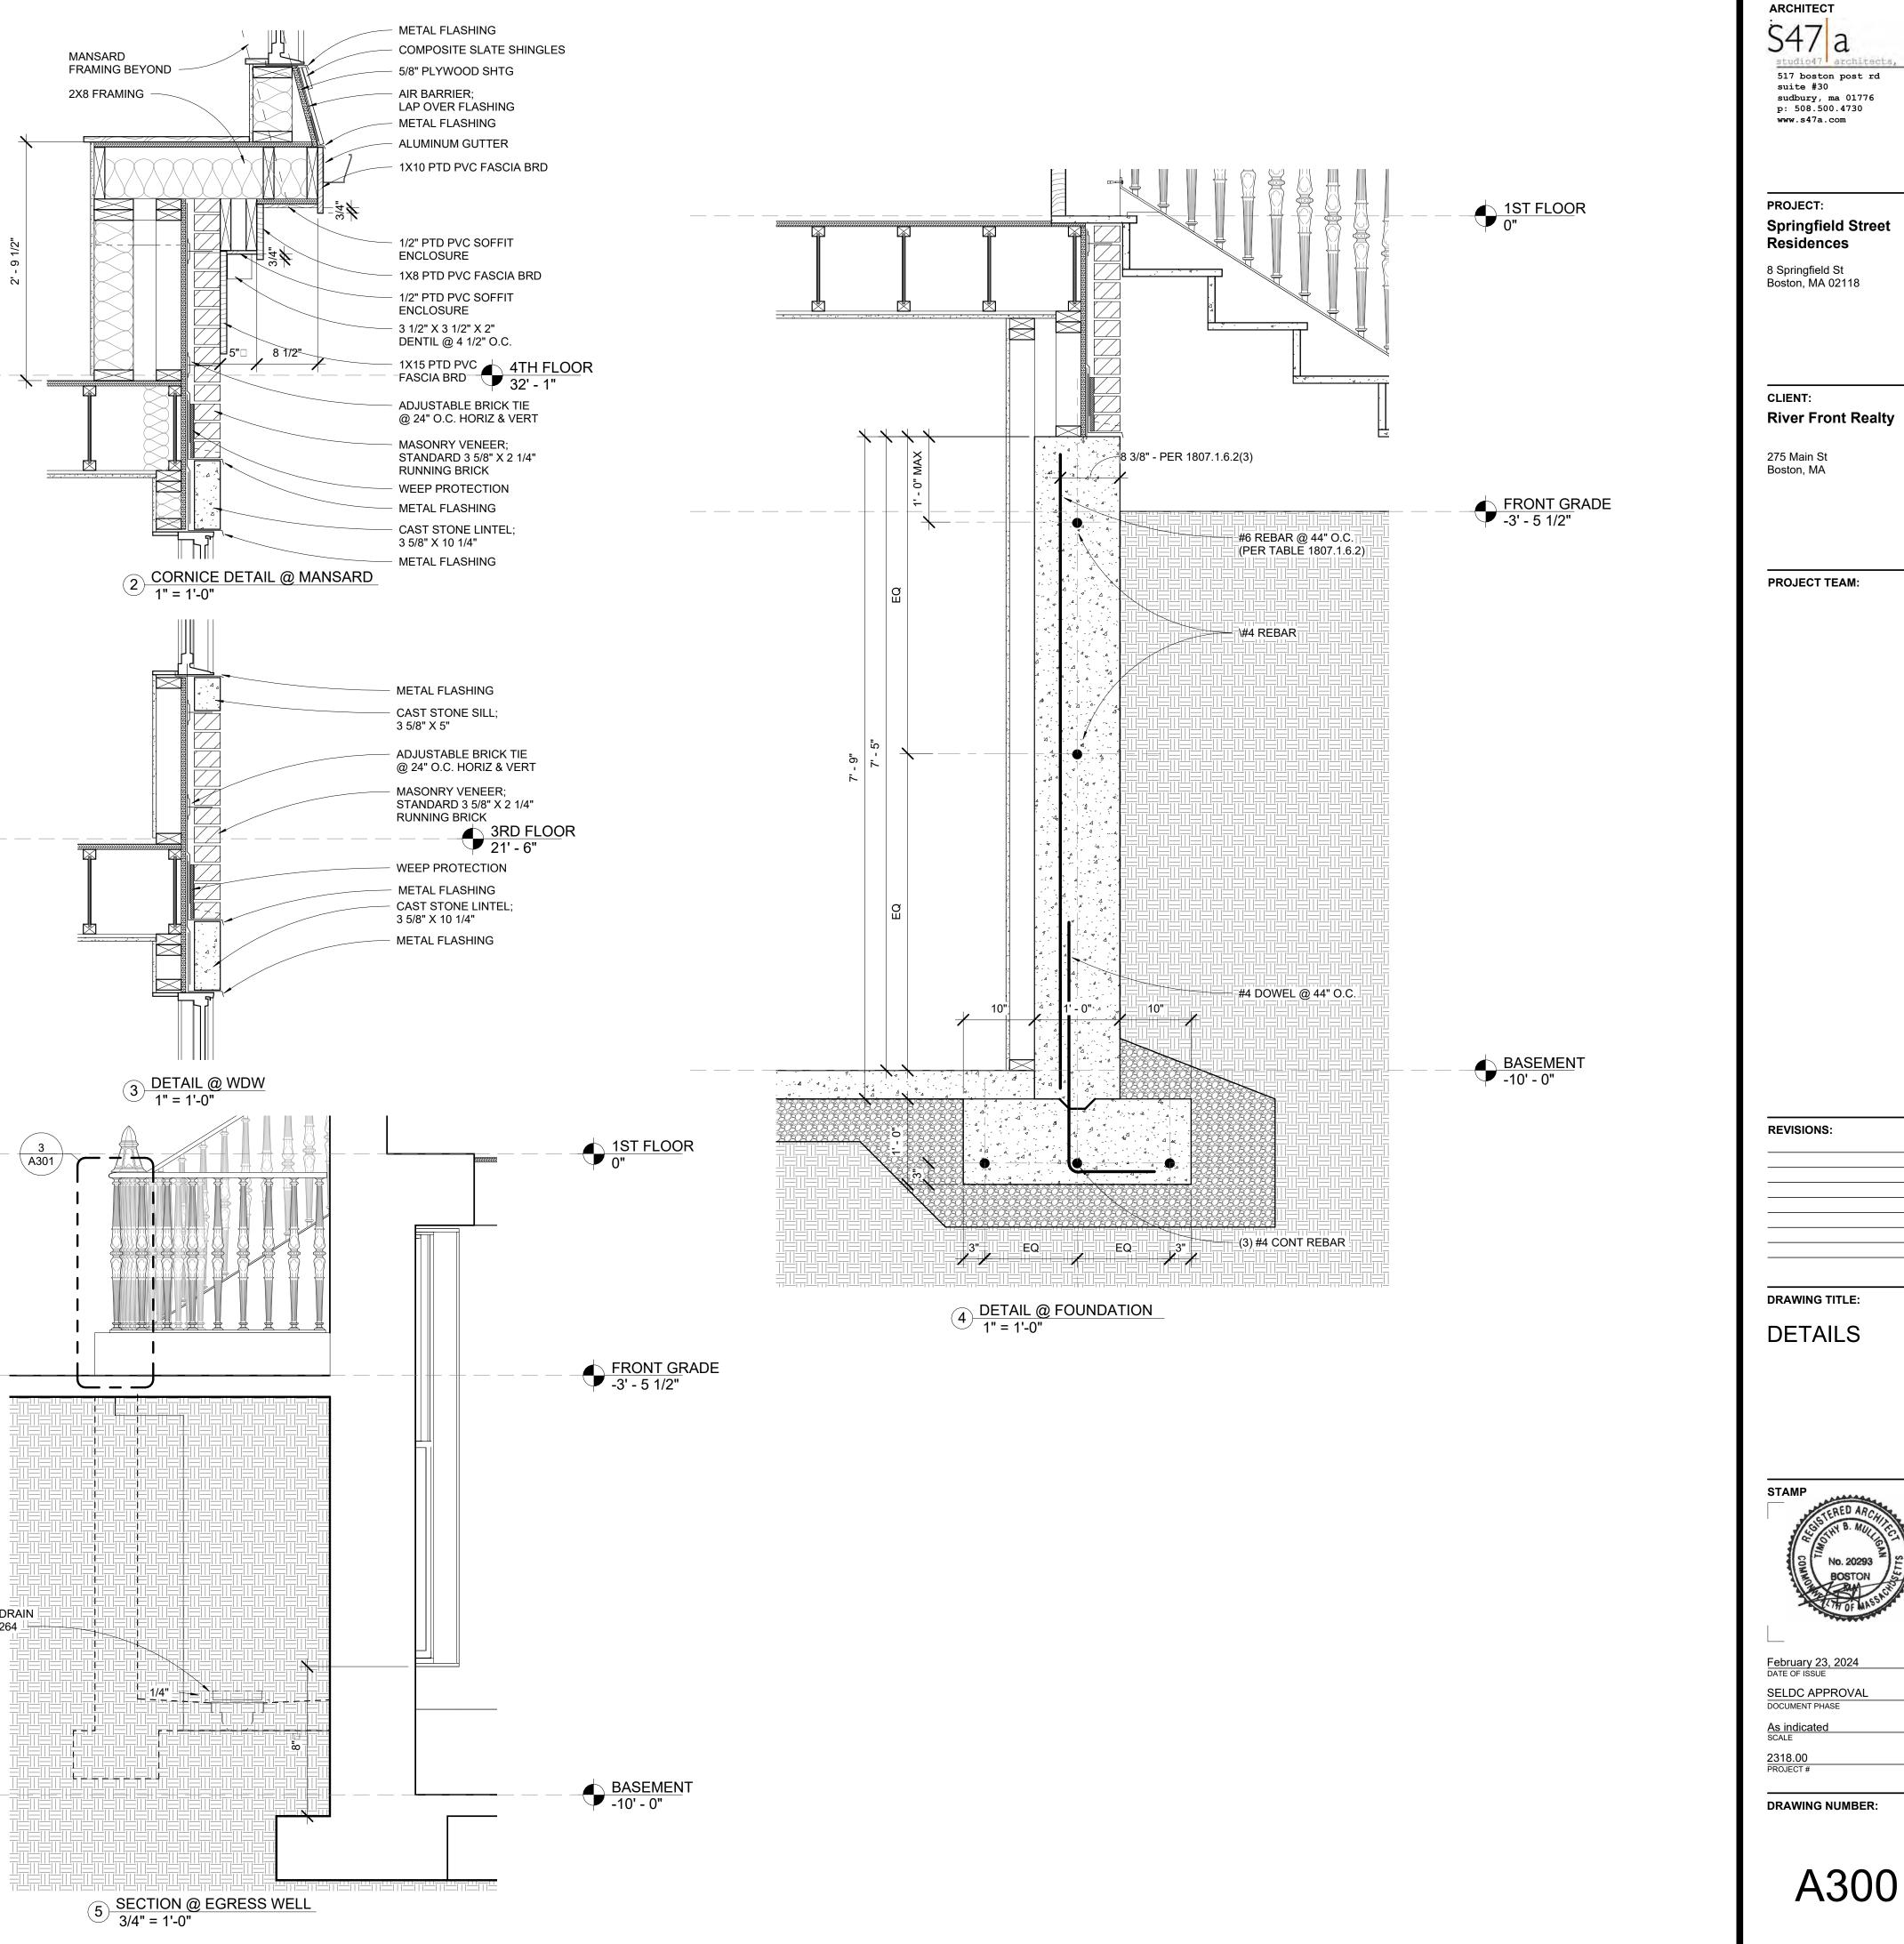


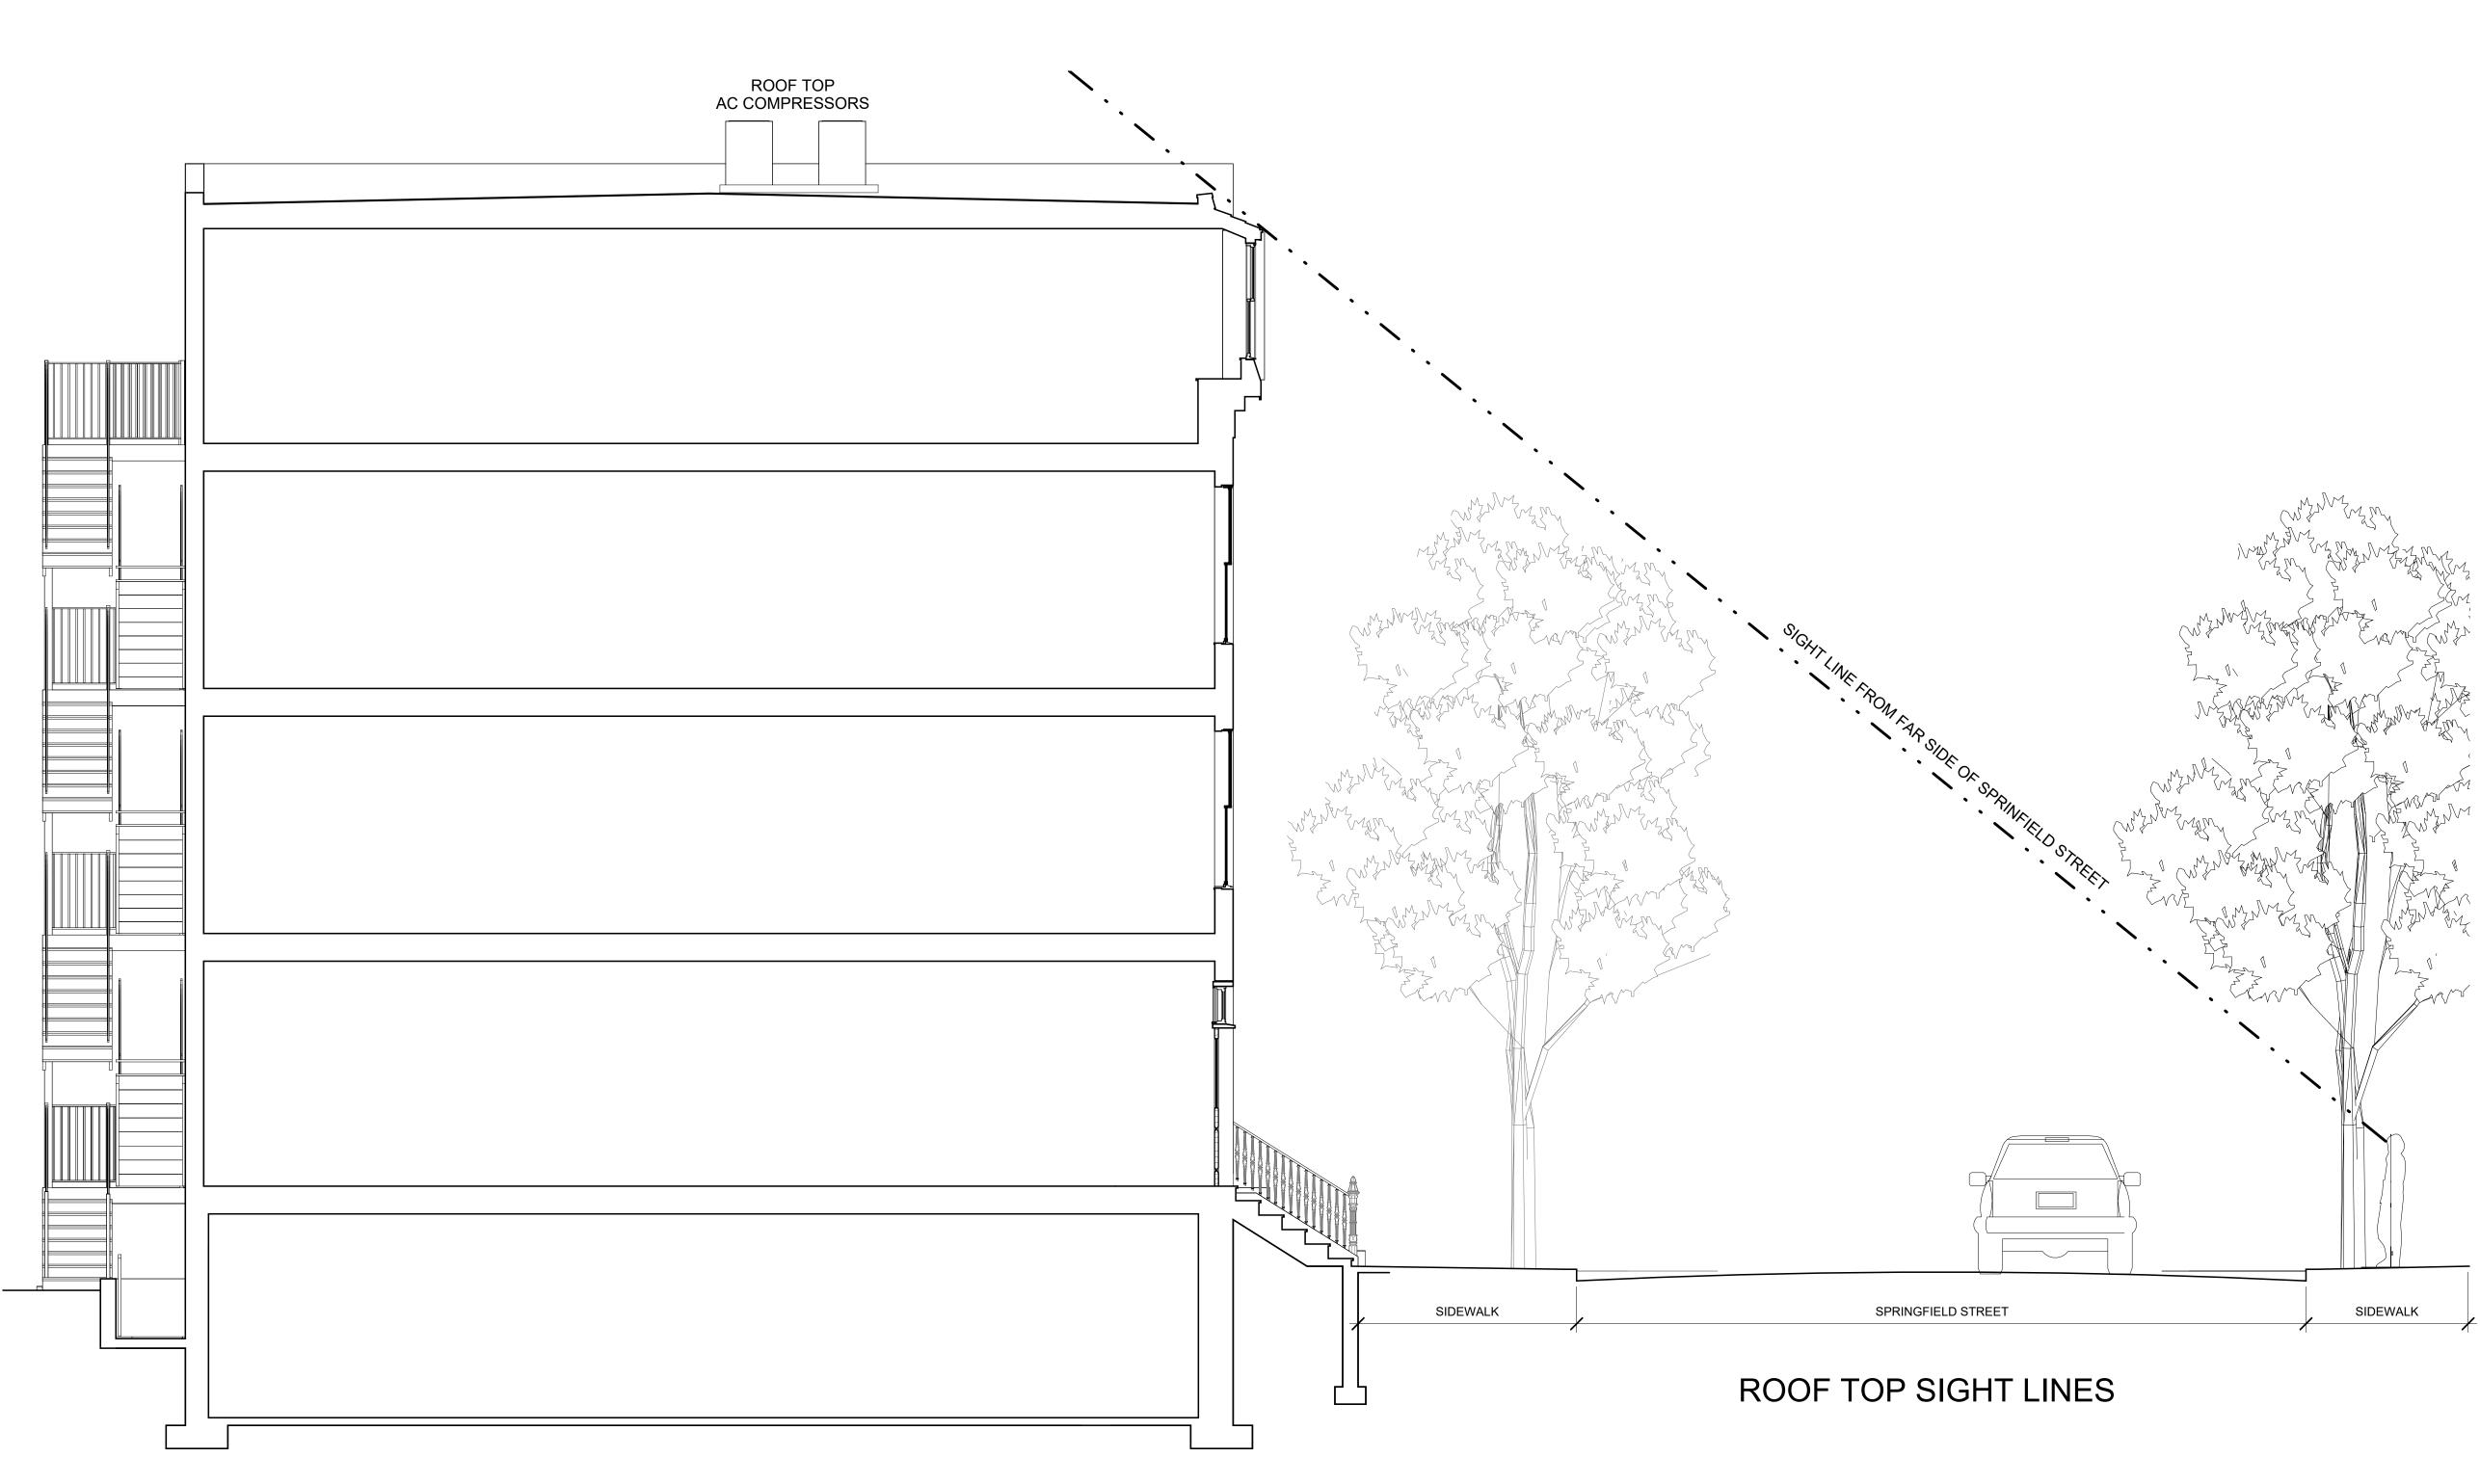

1 <u>SITE SECTION</u> 1/4" = 1'-0"

ARCHITECT 5447 a studio47 architects, inc 517 boston post rd suite #30 sudbury, ma 01776 p: 508.500.4730 www.s47a.com
PROJECT: Springfield Street Residences 8 Springfield St Boston, MA 02118
CLIENT: River Front Realty 275 Main St Boston, MA
PROJECT TEAM:
REVISIONS:
DRAWING TITLE:
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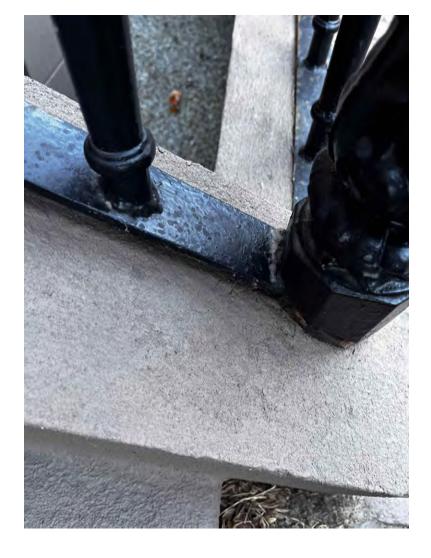


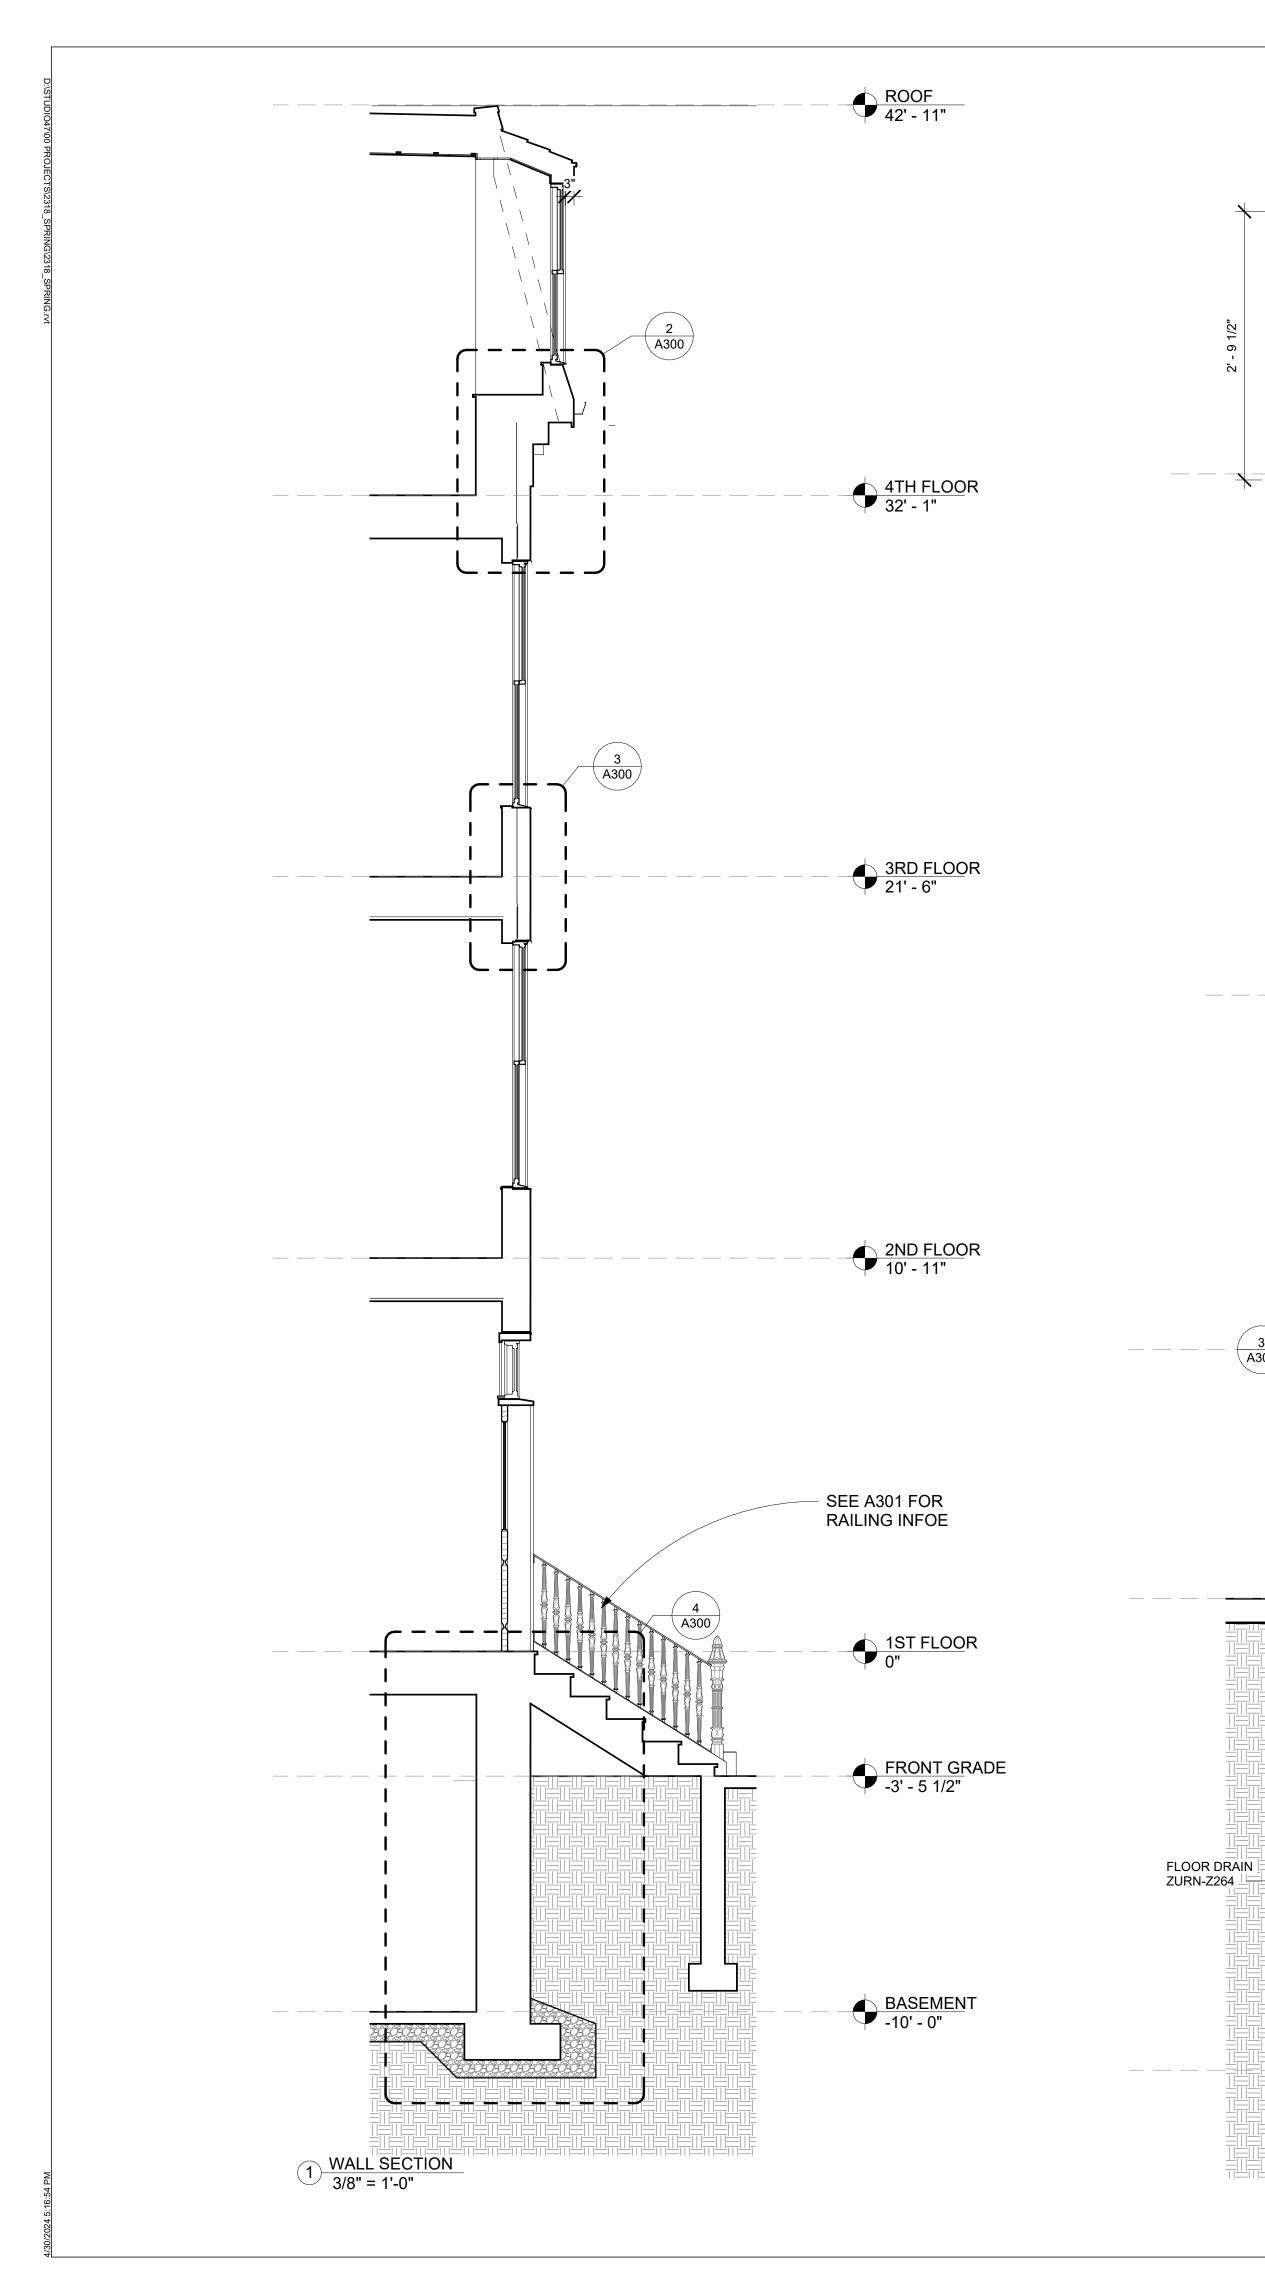

RAILING PRECEDANT SAMPLES FROM THE ABUTTING PROPERTY AT #10 E. SPRINGFIELD


BOTTOM RAIL TO CURB AND CORNER POST

TOP & BOTTOM RAIL TO MASONRY






2 RAILING ELEVATION DETAIL 1 1/2" = 1'-0"

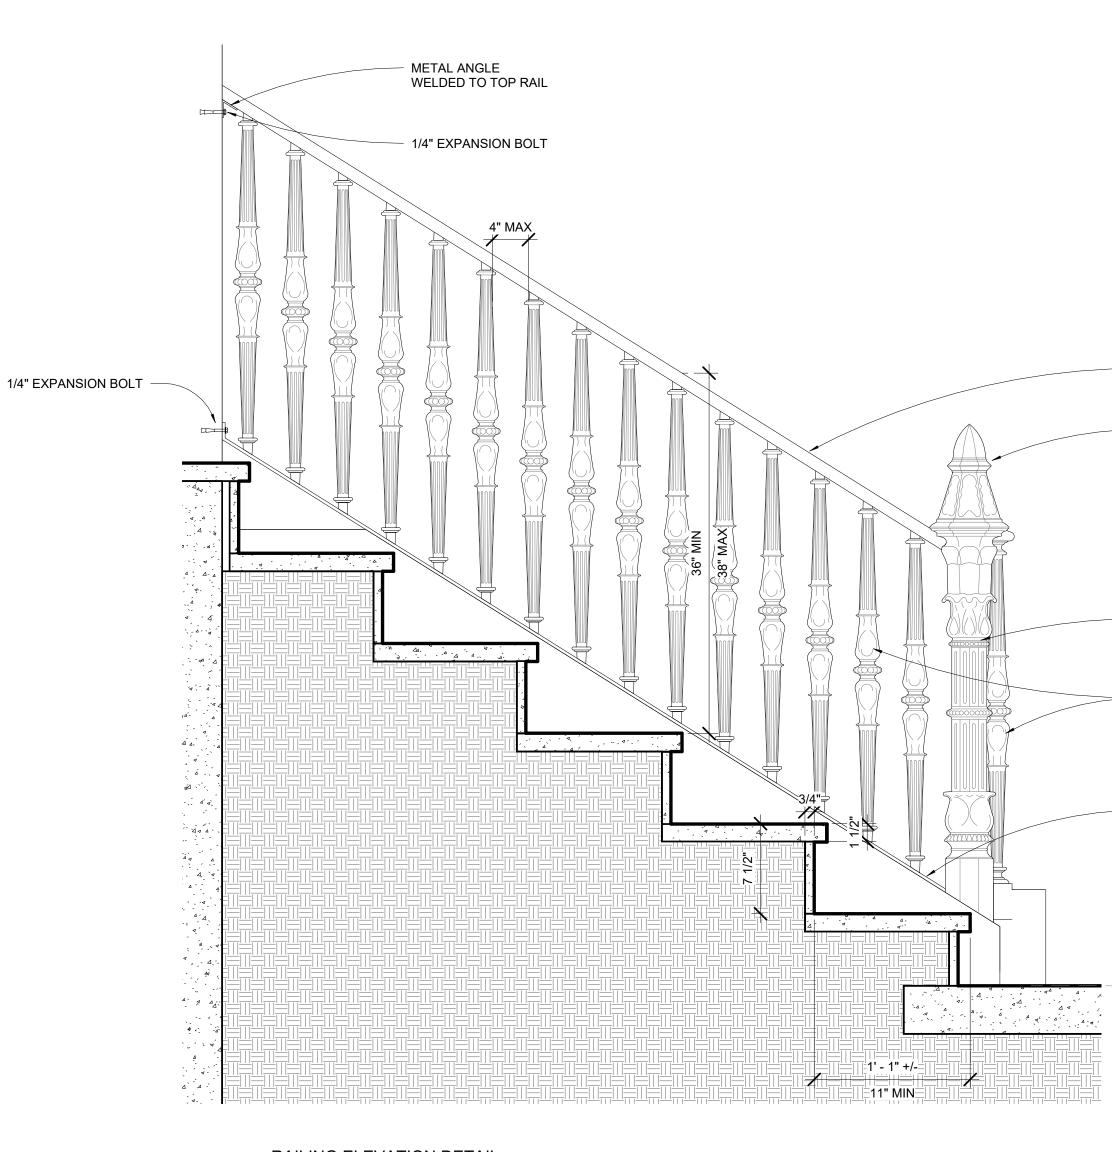

STUDIO47\00 PROJECTS\2318_SPRING\2318_SPRIN


TOP RAIL TO CORNER POST

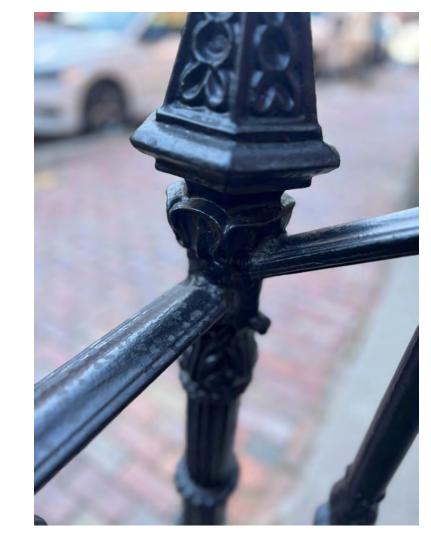



BALUSTER AND CORNER POST CHOOSEN TO MATCH THE STYLE AND PROFILE OF THE EXISTING RAILING AT THE ABUTTING PROPERTY AT #10 EAST SPRINGFIELD.

1 RAILING ELEVATION DETAIL 1 1/2" = 1'-0"

3 BALUSTER DETAIL 1 1/2" = 1'-0"

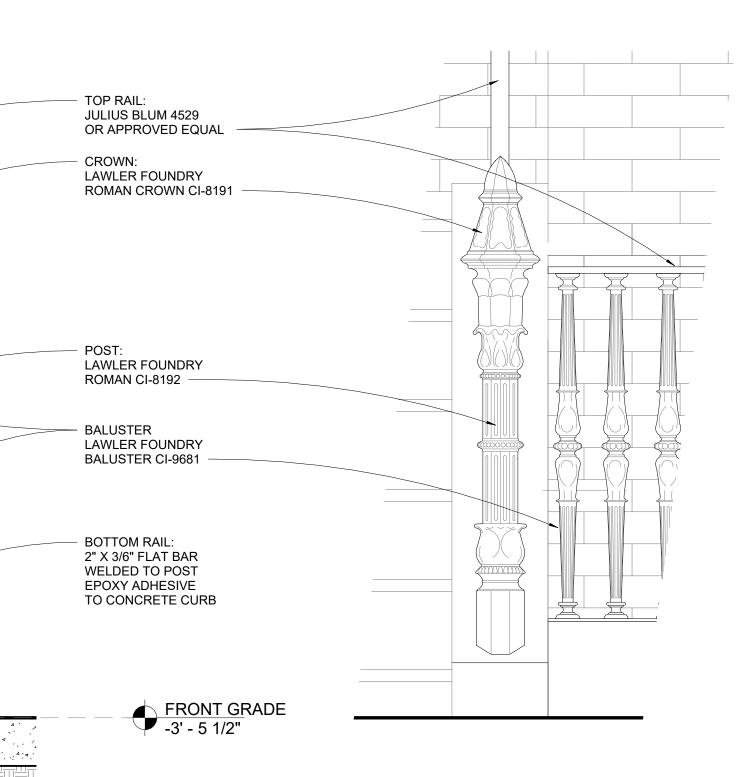

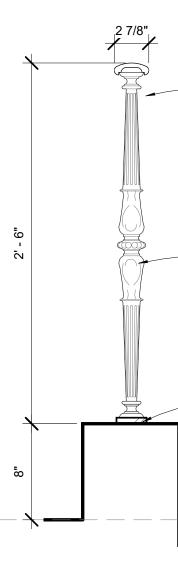

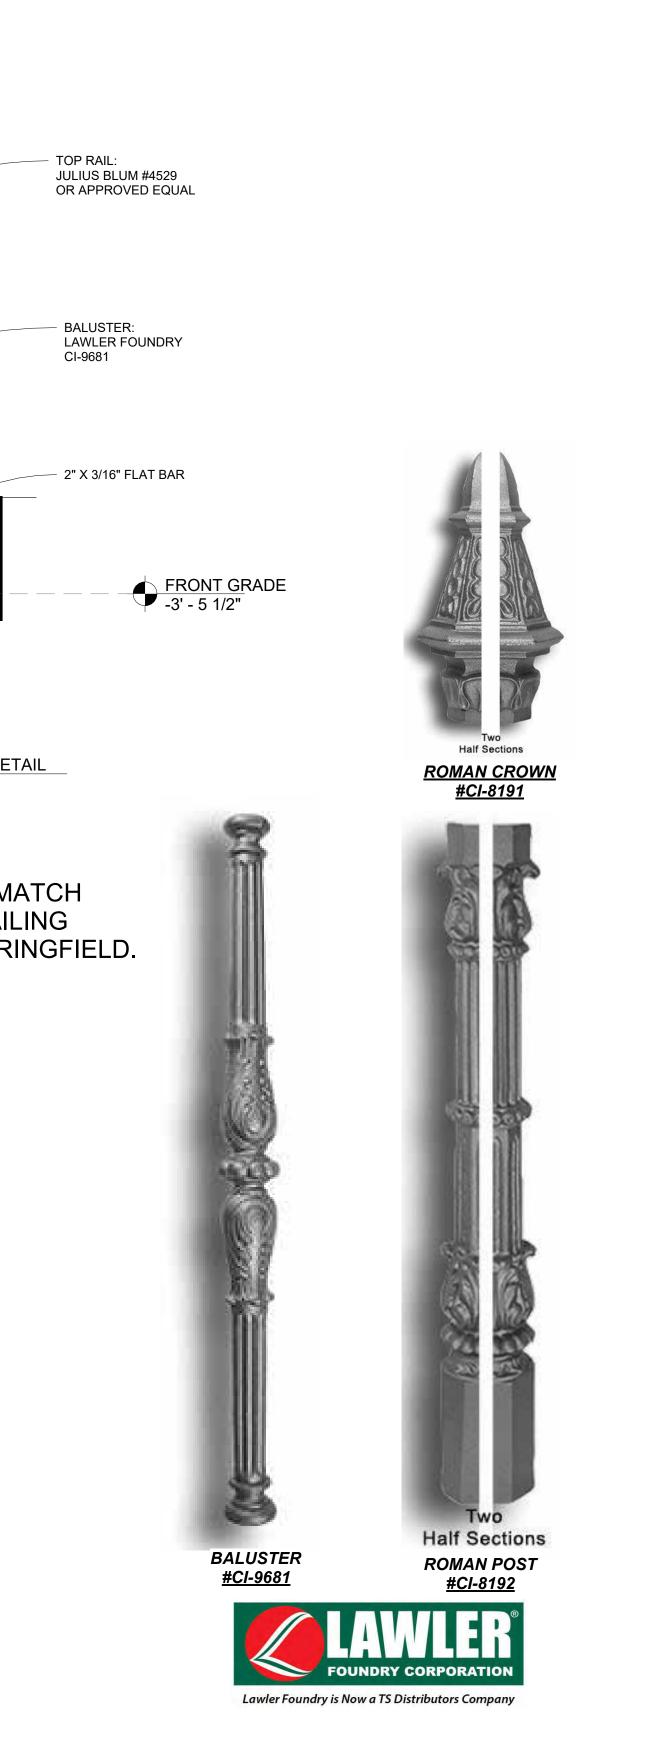

S47 a	
<pre>studio47 architects, d 517 boston post rd suite #30 sudbury, ma 01776 p: 508.500.4730 www.s47a.com</pre>	
PROJECT: Springfield Street Residences	
8 Springfield St Boston, MA 02118	

CLIENT:

275 Main St

Boston, MA

PROJECT TEAM:

River Front Realty

RE	VISIONS:
	ETAILS
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ST	Sister B. MULLER
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AC COMPRESSOR





Variable Speed Air Conditioner




SINGLE-WIDTH SLATE



<u>ROOFING</u>



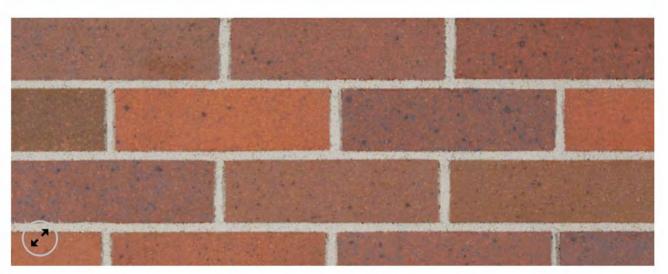

BRICK VENEER - BELDEN DARK 470-470

MASONRY



CAST STONE: HC-69 **PAINT** BENJAMIN MOORE







CRAFTMADE ARGENT II 1 - LIGHT 6" OUTDOOR WALL LIGHT EXTERIOR LIGHTING

S47 a studio47 architects, inc 517 boston post rd suite #30 sudbury, ma 01776 p: 508.500.4730 www.s47a.com
PROJECT: Springfield Street Residences 8 Springfield St Boston, MA 02118
CLIENT: River Front Realty 275 Main St Boston, MA
PROJECT TEAM:
REVISIONS:
drawing title: MATERIALS
STAMP STERED ARCHING No. 20293 BOSTON BOSTON TH OF MASSING
February 23, 2024 DATE OF ISSUE SELDC APPROVAL DOCUMENT PHASE As indicated SCALE 2318.00 PROJECT #
A302

ARCHITECT



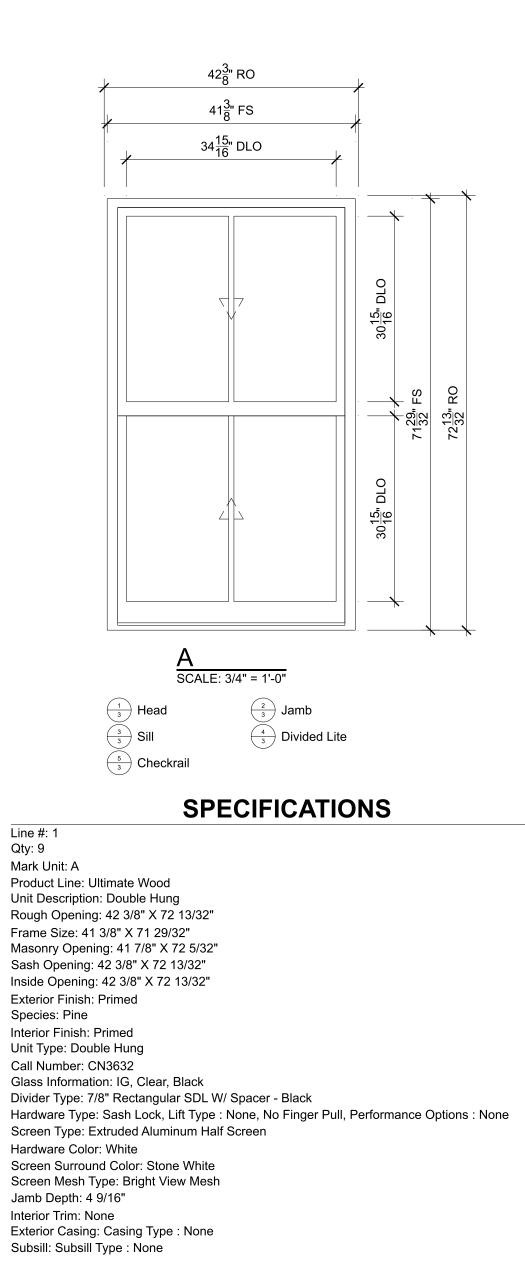


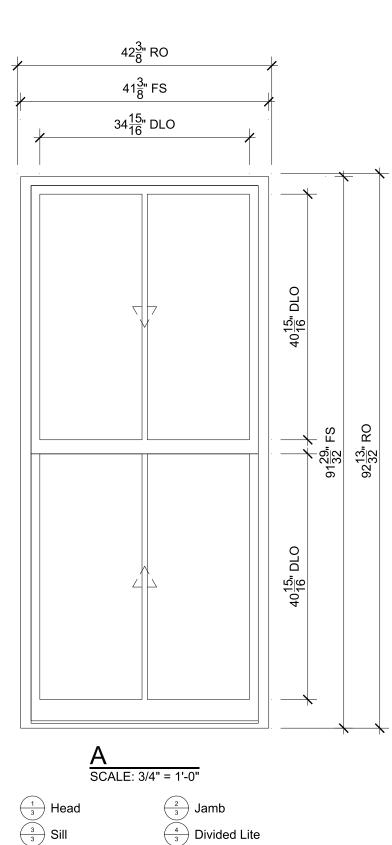


SPECIFICATIONS

Line #: 2 Qty: 2 Mark Unit: A Product Line: Ultimate Wood Unit Description: Double Hung Rough Opening: 42 3/8" X 92 13/32" Frame Size: 41 3/8" X 91 29/32" Masonry Opening: 41 7/8" X 92 5/32" Sash Opening: 42 3/8" X 92 13/32" Inside Opening: 42 3/8" X 92 13/32" Exterior Finish: Primed Species: Pine Interior Finish: Primed Unit Type: Double Hung Call Number: CN3642 Glass Information: IG, Clear, Black Divider Type: 7/8" Rectangular SDL W/ Spacer - Black Hardware Type: Sash Lock, Lift Type : None, No Finger Pull, Performance Options : None Screen Type: Extruded Aluminum Half Screen Hardware Color: White Screen Surround Color: Stone White Screen Mesh Type: Bright View Mesh Jamb Depth: 4 9/16" Interior Trim: None Exterior Casing: Casing Type : None Subsill: Subsill Type : None

 $\binom{5}{3}$ Checkrail

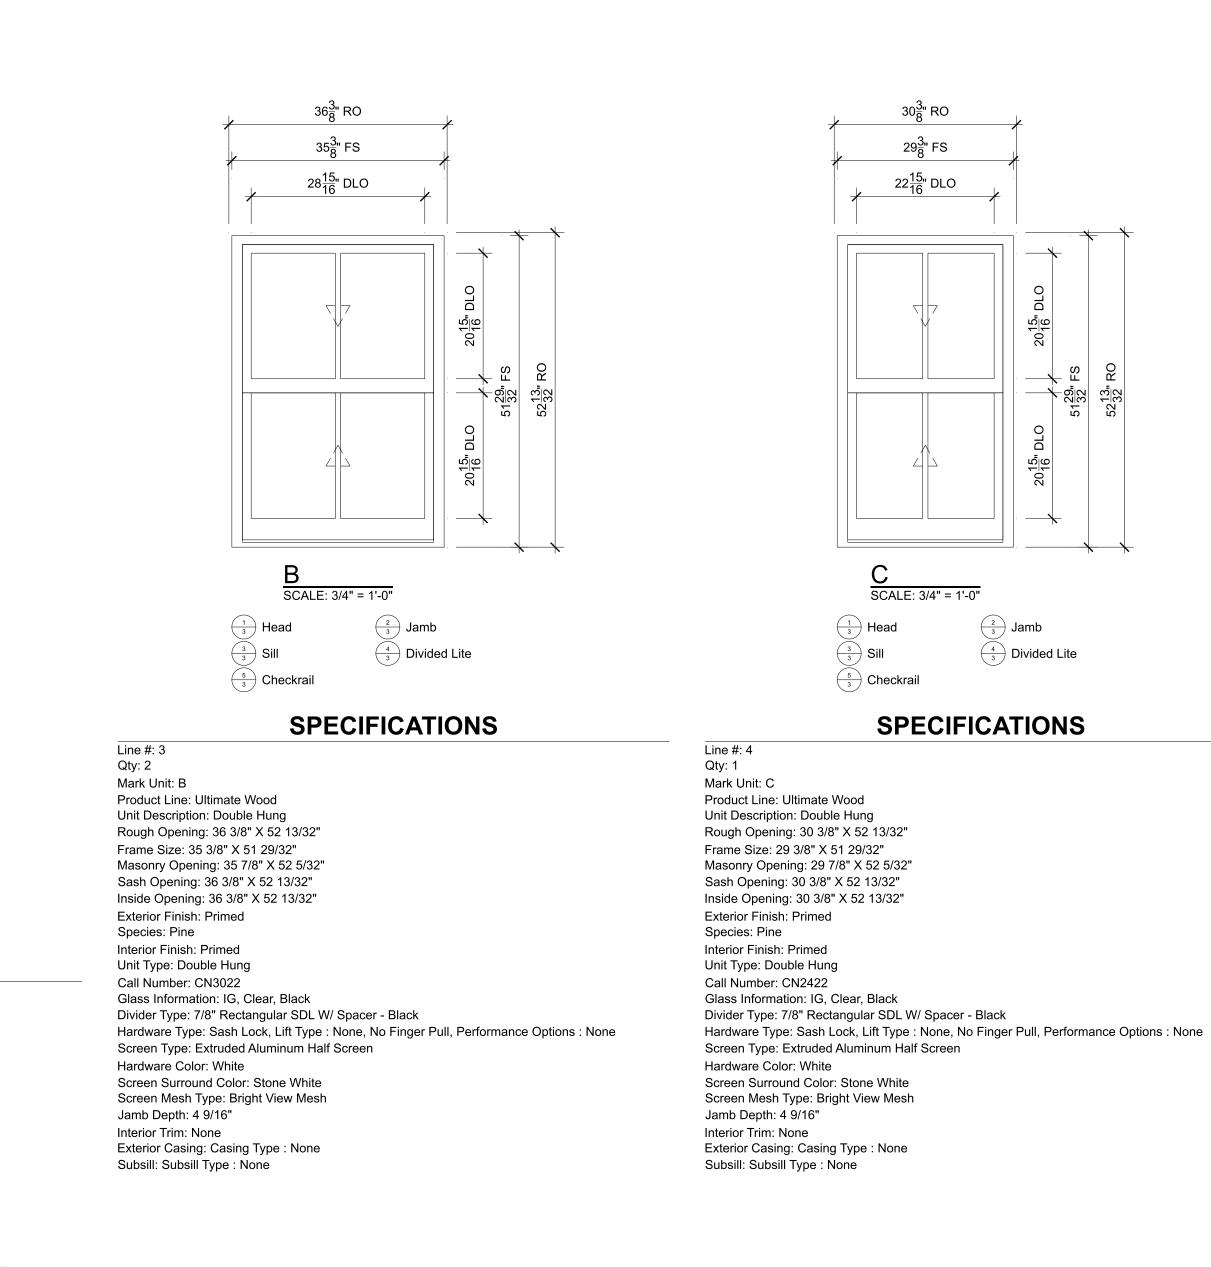

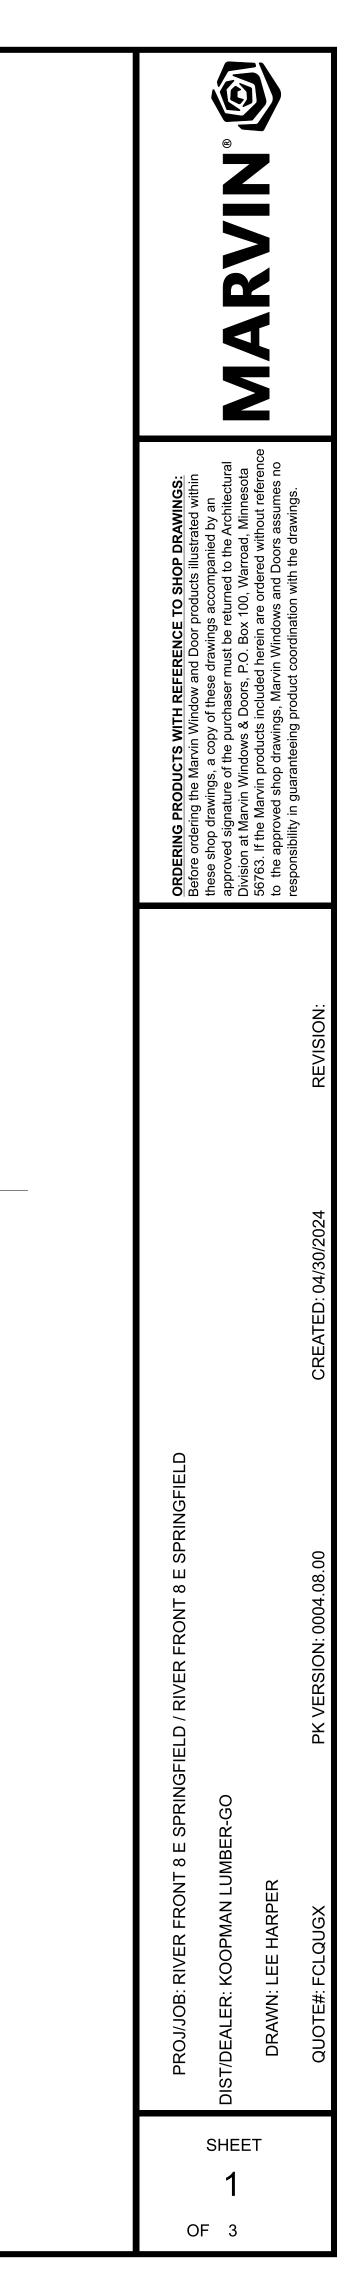


19" RO 18" FS 11<u>9</u>" DLO Q ∇ <u>1</u>0 D \land \angle 20<u>15</u>.

D SCALE: 3/4" = 1'-0" 6 3 Head $\left(\frac{7}{3}\right)$ Jamb

SPECIFICATIONS

Qty: 2 Mark Unit: D Product Line: Ultimate Wood Unit Description: Double Hung Rough Opening: 19" X 52 13/32" Frame Size: 18" X 51 29/32" Masonry Opening: 18 1/2" X 52 5/32" Sash Opening: 19" X 52 13/32" Inside Opening: 19" X 52 13/32" Exterior Finish: Primed Species: Pine Interior Finish: Primed Unit Type: Double Hung Call Number: CN22 height Glass Information: IG, Clear, Black Divider Type: 7/8" Rectangular SDL W/ Spacer - Black Hardware Type: Sash Lock, Lift Type : None, No Finger Pull, Performance Options : None Screen Type: Extruded Aluminum Half Screen Hardware Color: White Screen Surround Color: Stone White Screen Mesh Type: Bright View Mesh Jamb Depth: 4 9/16" Interior Trim: None Exterior Casing: Casing Type : None Subsill: Subsill Type : None

Line #: 5

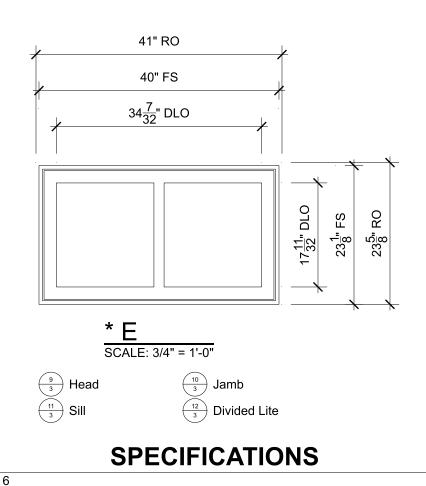

Line #: 6 Qty: 1 Mark Unit: E Product Line: Ultimate Wood Unit Description: Casement Rough Opening: 41" X 23 5/8" Frame Size: 40" X 23 1/8" Masonry Opening: 40 1/2" X 23 3/8" Sash Opening: 41" X 23 5/8" Inside Opening: 41" X 23 5/8" Exterior Finish: Primed Species: Pine Interior Finish: Primed Unit Type: Casement, Stationary Call Number: CN4024 Glass Information: IG, Low E2 w/Argon, Black Divider Type: Rectangular ADL Hardware Type: None Screen Type: None Hardware Color: None Screen Surround Color: None Screen Mesh Type: None Jamb Depth: 4 9/16" Interior Trim: None Exterior Casing: Casing Type : None Subsill: Subsill Type : None

* The quote for this unit has an error on it. Please verify availability prior to order.

ORDERING PRODUCTS WITH REFERENCE TO SHOP DRAWINGS: Before ordering the Marvin Window and Door products illustrated within	these shop drawings, a copy of these drawings accompanied by an approved signature of the purchaser must be returned to the Architectural Division at Marvin Windows & Doors, P.O. Box 100, Warroad, Minnesota	56763. If the Marvin products included herein are ordered without reference to the approved shop drawings, Marvin Windows and Doors assumes no responsibility in guaranteeing product coordination with the drawings.	
			REVISION:
			CREATED: 04/30/2024
PROJ/JOB: RIVER FRONT 8 E SPRINGFIELD / RIVER FRONT 8 E SPRINGFIELD	0		PK VERSION: 0004.08.00
PROJ/JOB: RIVER FRONT 8 E SPRI	DIST/DEALER: KOOPMAN LUMBER-GC	DRAWN: LEE HARPER	QUOTE#: FCLQUGX
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