6 Mt.Vernon Place



Figure 7: Photograph of Mount Vernon Place c. 1860. Boston Public Library. Mt. Vernon Place c. 1860



Mt. Vernon Place c. 2014

Attachments: 'A' Shutters 'B' Dog and Pintle 'C' Windows 'D' Light Fixture 'E' South Door

6 Mt.Vernon Place

Proposed Adjustments

06.16.2017

Approval Requested for: 1. New Shutters, East and South Facade 2. New Windows, East and South Facade 3. Revised Rail Design at Rear, and Eliminated Fire Escape





6 Mt.Vernon Place Proposed Adjustments 06.16.2017

Existing North Elevation

MV 7 Level 4

MV 7 Level 3

MV 7 Level 2

MV 7 Level 1

MV 7 Level 0





6 Mt. Vernon Place

7 Mt. Vernon Place

6 Mt.Vernon Place Proposed Adjustments 06.16.2017

Previously Approved North Elevation (no change requested)




MV 7 LEVEL 1 105' - 3 1/2"

MV7 LEVEL 2 117' - 11 1/2"






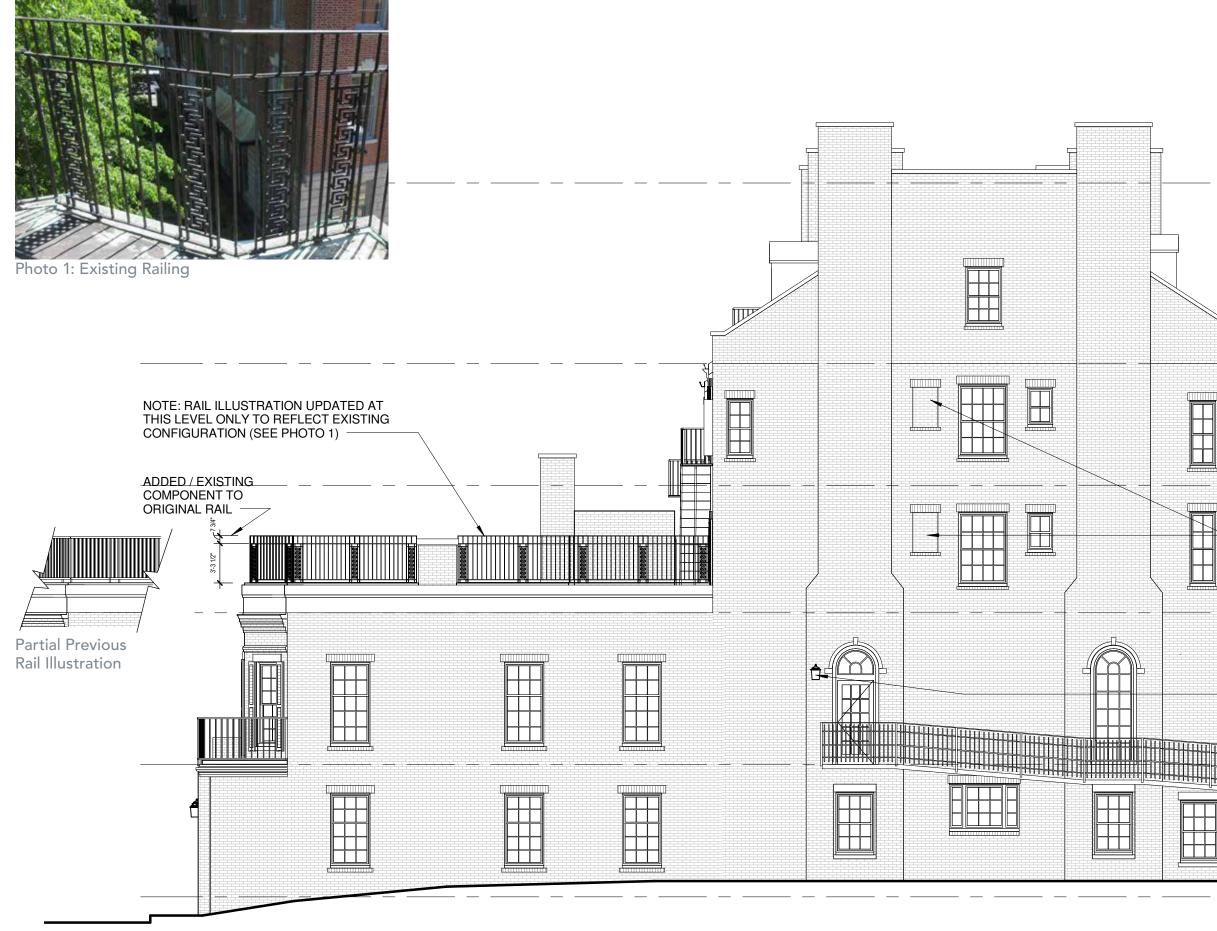

6 Mt.Vernon Place Proposed Adjustments 06.16.2017

Updated Existing East Elevation

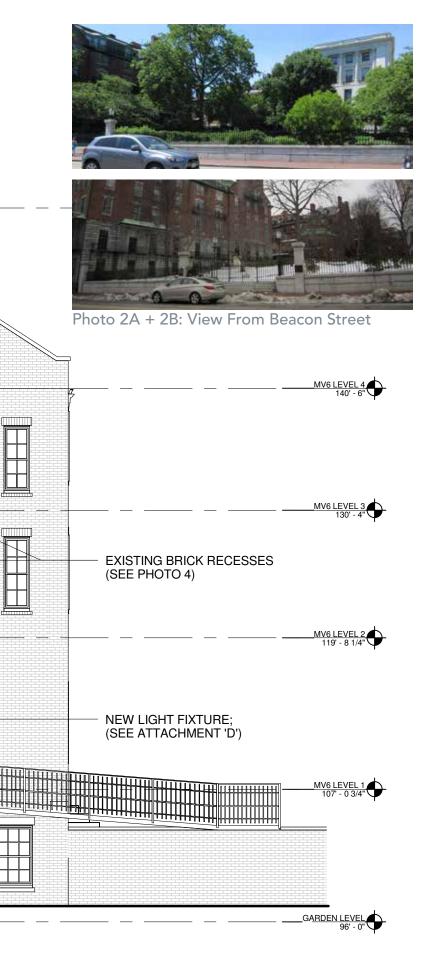





PROPOSED NEW SHUTTERS AT THESE SIX WINDOWS TOTAL, WITH NEW DOGS; (SEE SHUTTERS ATTACHMENT 'A' DOGS ATTACHMENT 'B'; AND PHOTO 3 ABOVE)

6 Mt.Vernon Place


Proposed Adjustments 06.16.2017

Proposed East Elevation



Photo 4: Partial East Elevation - View from State House



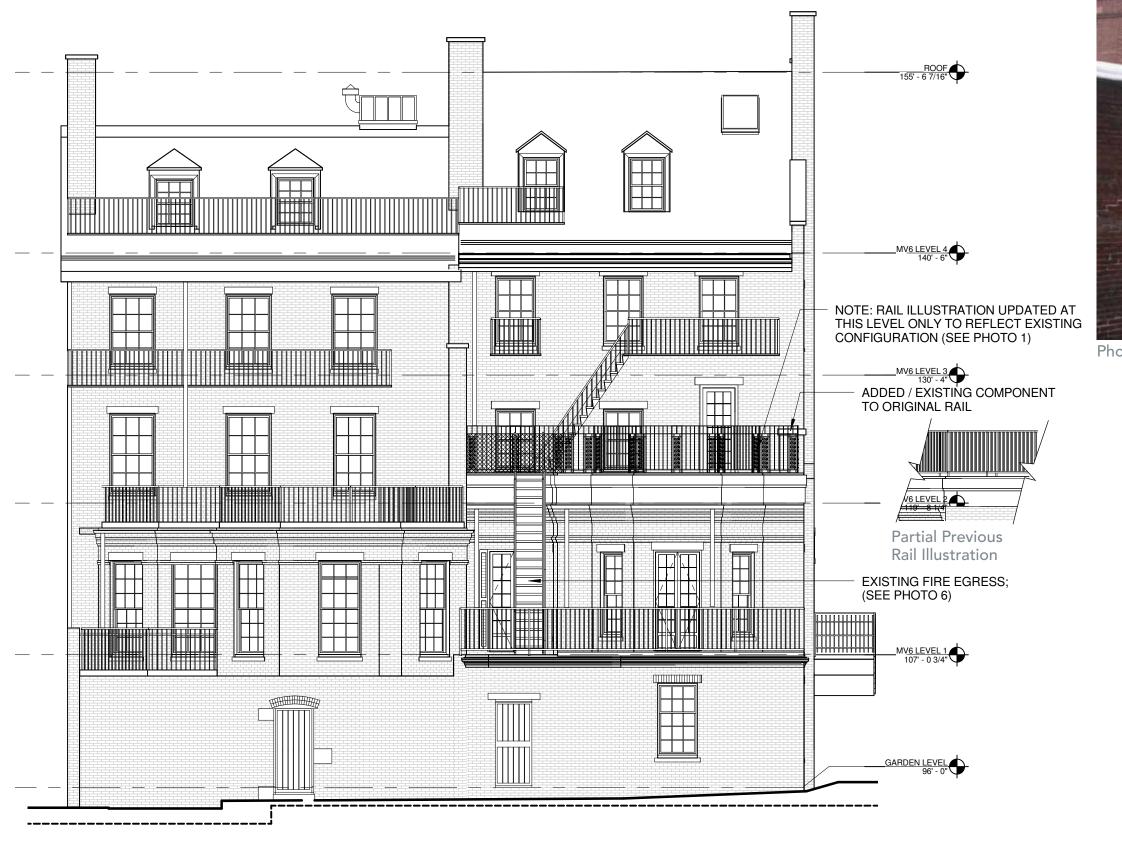

7 Mt. Vernon Place

6 Mt. Vernon Place

6 Mt.Vernon Place

Proposed Adjustments 06.16.2017

Updated Existing South Elevation



Photo 6: Existing Fire Escape



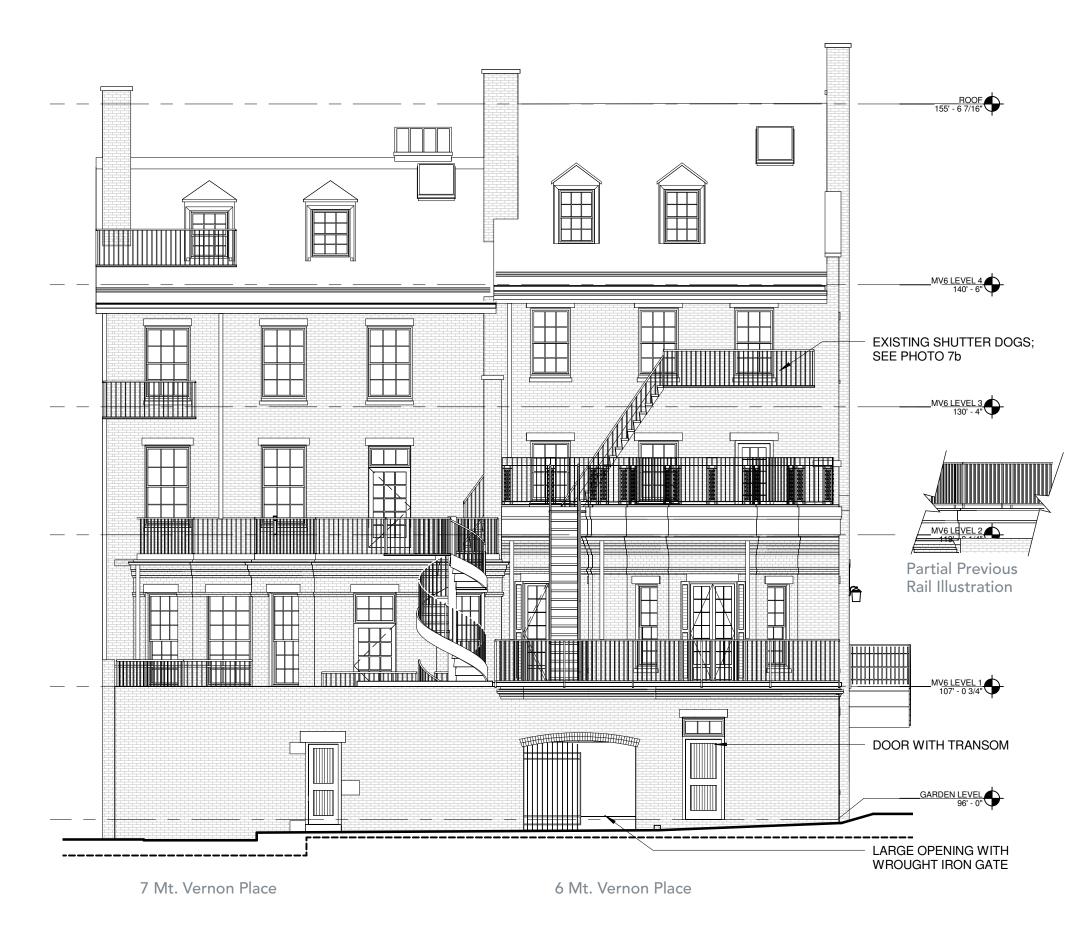




Illustration 7a: View of Joy Place from Joy Street Illustrating Elevations as Approved July 2014



6 Mt.Vernon Place


Proposed Adjustments 06.16.2017

Previously Approved South Elevation



Picture 7b: Existing Shutter Dogs



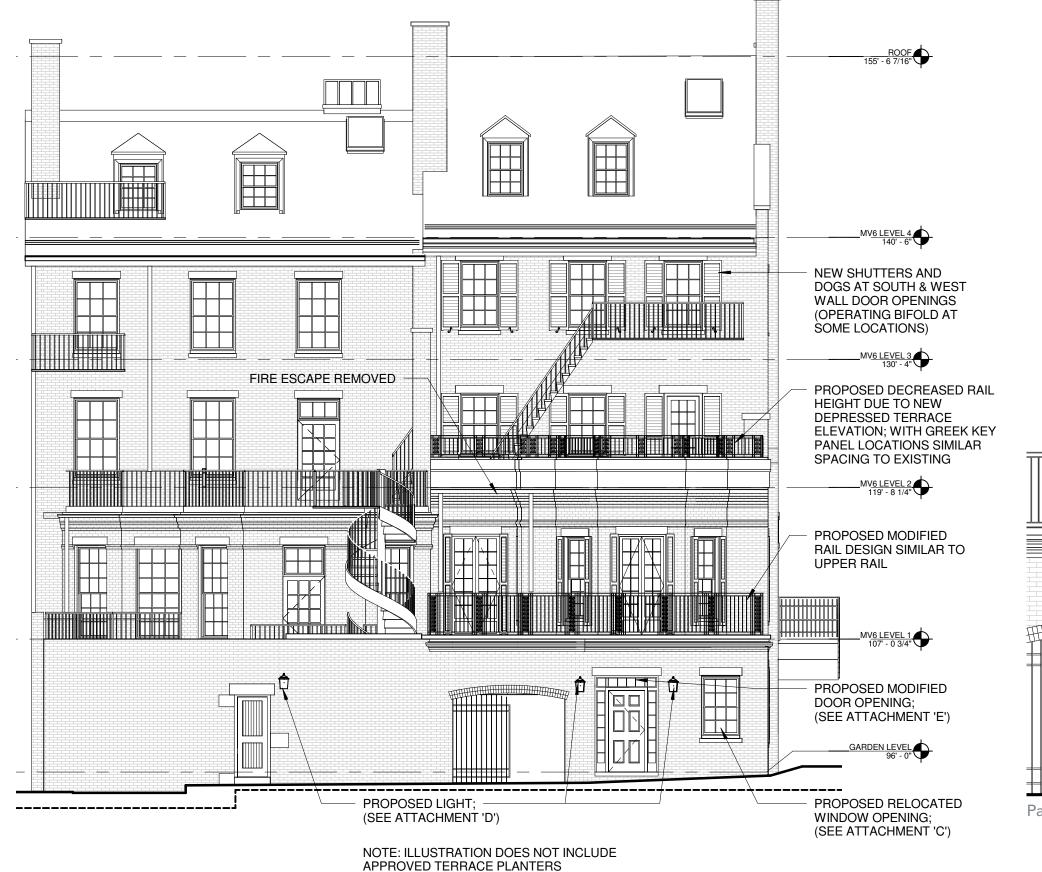

6 Mt. Vernon Place

7 Mt. Vernon Place

6 Mt.Vernon Place Proposed Adjustments 06.16.2017

Proposed South Elevation



Partial Enlarged Elevation

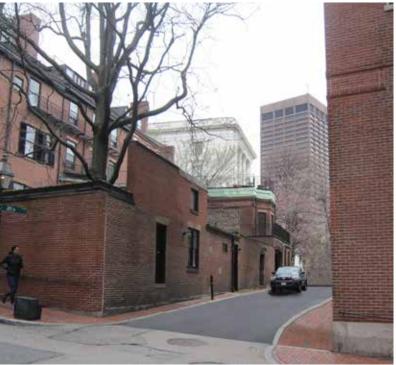


Illustration 8: Proposed View of Joy Place from Joy Street (Fire Escape Removed, Window Added





Overall View of Joy Place North Side

Joy Place North Side - 8 Mt. Vernon Pl.

Prior to Construction

Existing Window at 6 Mt. Vernon Pl.

Overall View of Joy Place South Side

Joy Place South Side - 34 Beacon St.

Joy Place South Side - 25 Beacon St.

Joy Place South Side - 33 Beacon St.

Existing Photos of Joy Place



6 Mt.Vernon Place Proposed Adjustments 06.16.2017













Acorn Street



Rollins Place

Champney Place

Existing Photos of Private Ways

6 Mt.Vernon Place Proposed Adjustments 06.16.2017









SUBMITTAL 085200-13


ATTACHMENT E - SOUTH DOOR


Revision # 1


TITLE:	Door 118		SENT DATE:	9/7/2016
PROJECT:	25 Beacon/6-7 Mt Vernon		JOB:	14-110
PACKAGE:	Wood Window and Doors		DUE DATE:	
SENT TO: CBT Archited	ts	Reviewed	Make Correctio	


Chris Pitman

-	Reviewed		Make Corrections As Noted	
	Rejected		Revise & Resubmit	
			n this submittal during this re mpliance with the requir ef nen	
			check is only for review of ger	
			in the contract documents. irming and correlating all qua	
			cesses and techniques of	in the s
	truction; coordinati orming his work in a		th that of all other trades; and factory manner	
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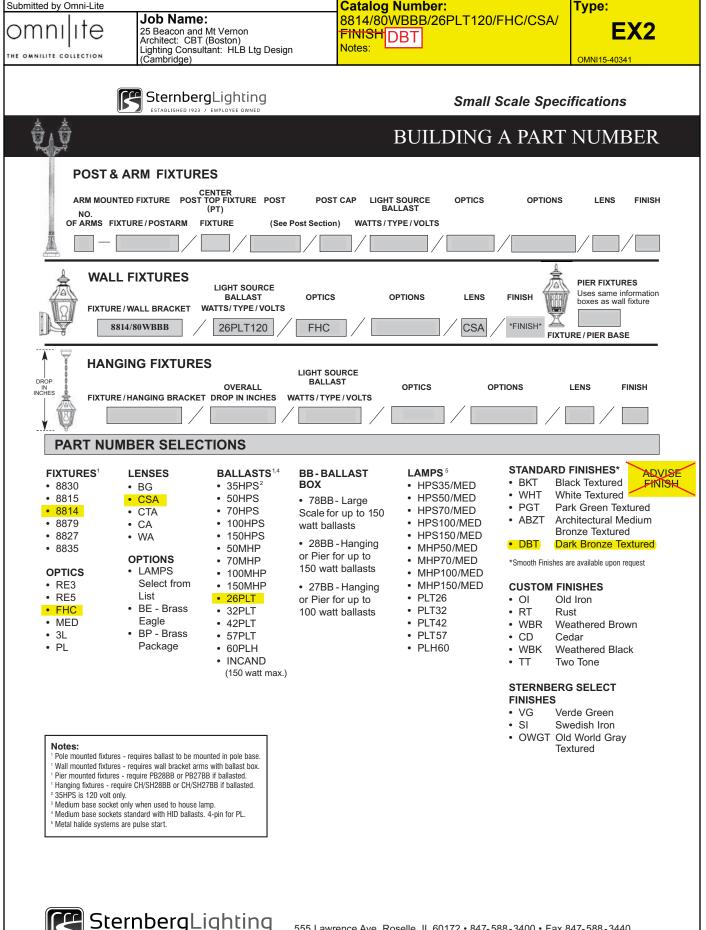


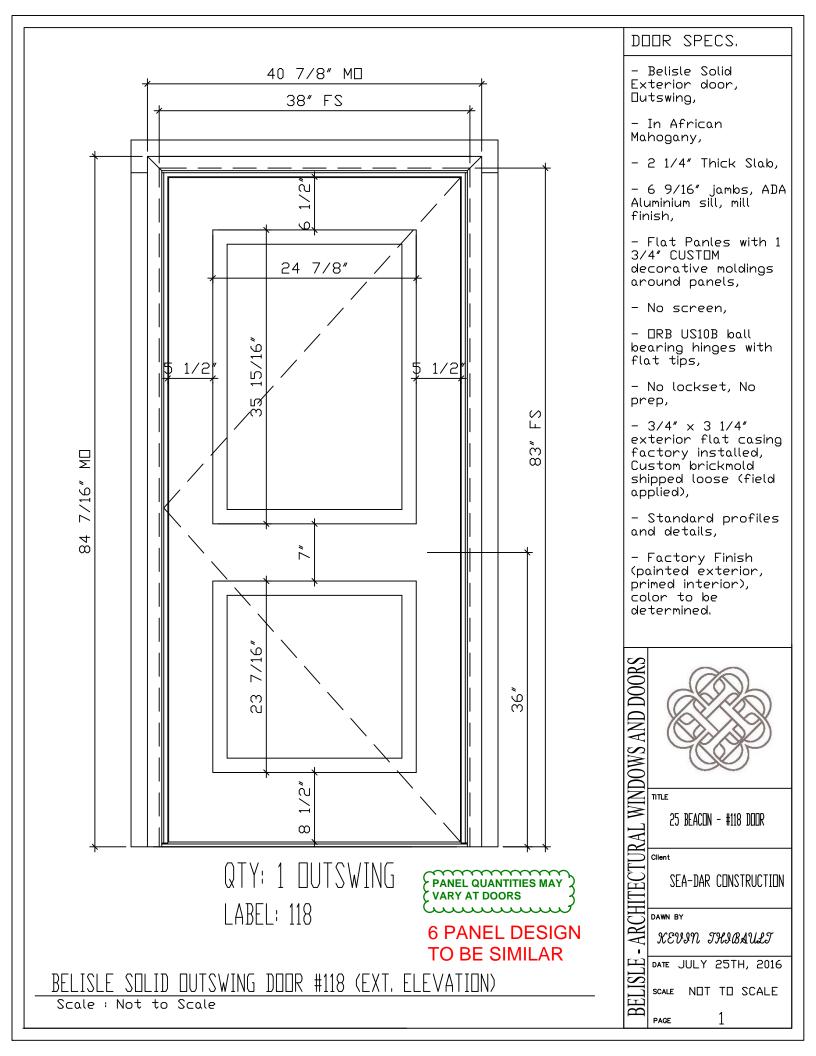

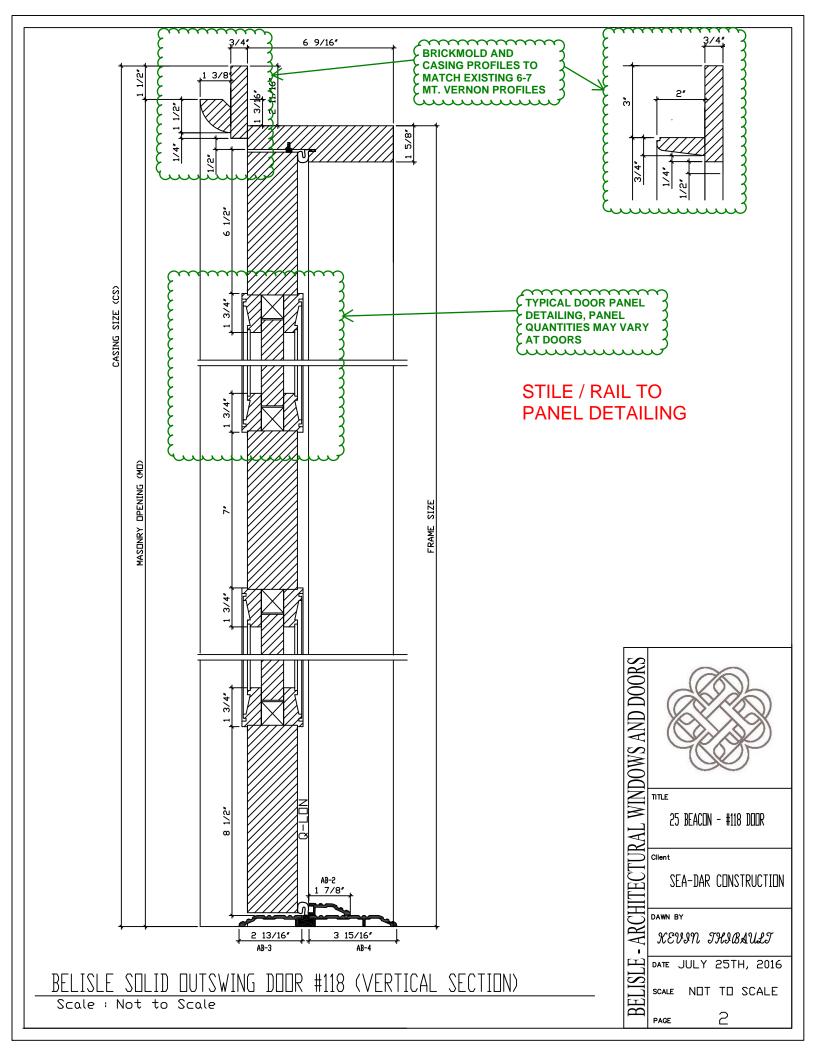

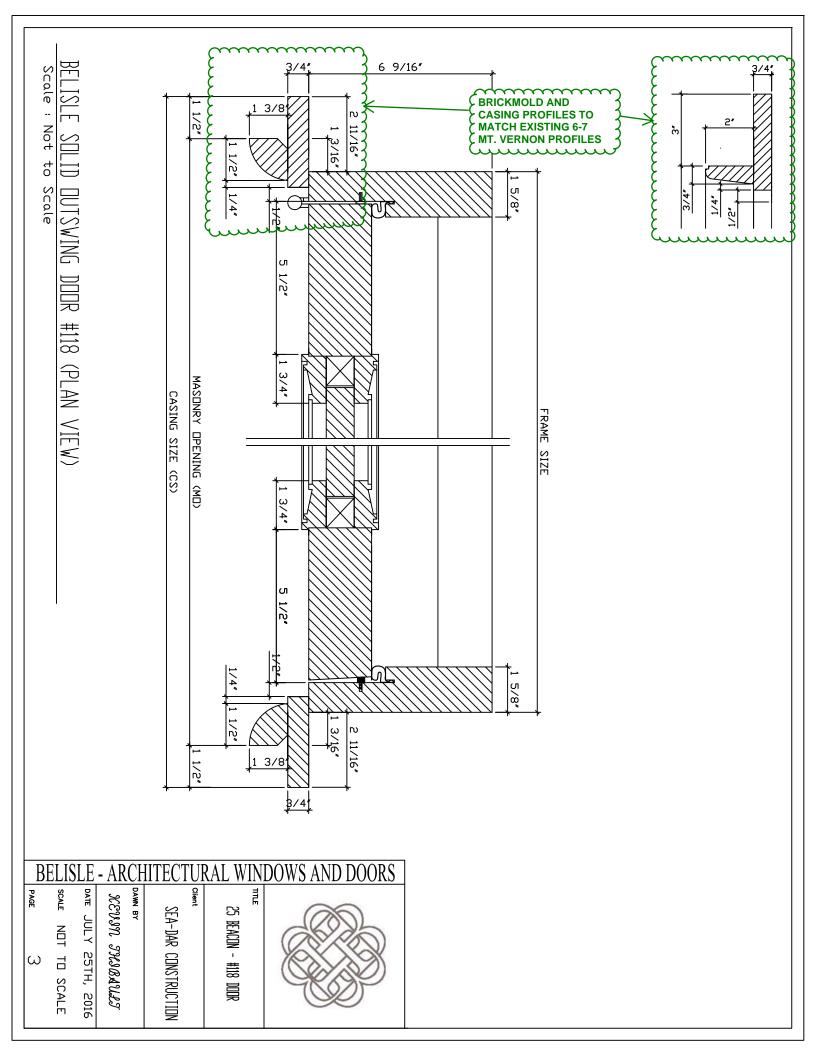
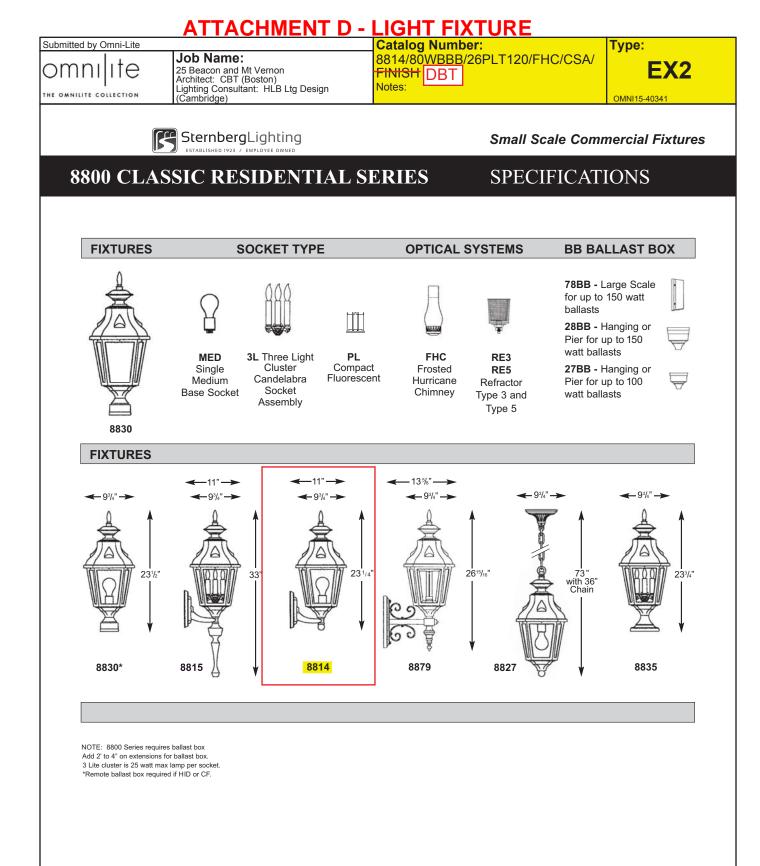
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ESTABLISHED 1923 / EMPLOYEE OWNED


555 Lawrence Ave. Roselle, IL 60172 • 847-588-3400 • Fax 847-588-3440 www.sternberglighting.com Email: info@sternberglighting.com 1-14

Submitted by Omni-Lite

OMNILITE COLLECTION

Job Name: 25 Beacon and Mt Vernon Architect: CBT (Boston) Lighting Consultant: HLB Ltg Design (Cambridge) Catalog Number: 8814/80WBBB/26PLT120/FHC/CSA/ FINISH DBT Notes:



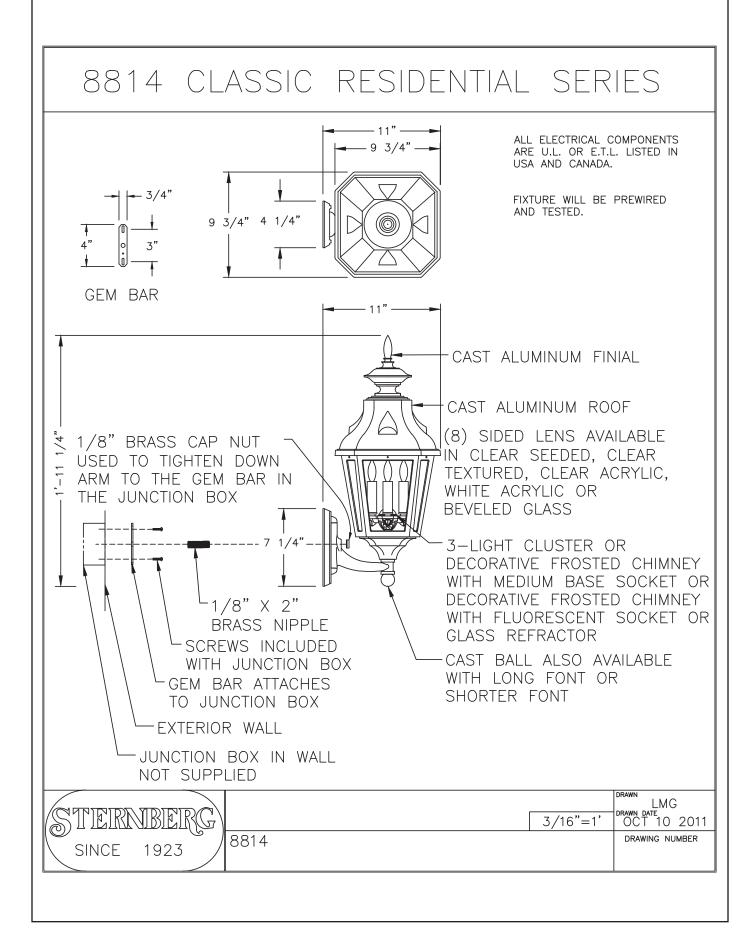



TITLE:

PROJECT:

ATTACHMENT C - WINDOWS

SUBMITTAL 085200-10

Revision #1

SEA-DAR CONSTRUCTION

MVP Windows & Doors Shops

25 Beacon/6-7 Mt Vernon

PACKAGE: Wood Window and Doors

Building trust one project at a time


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JOB:	14-110

DUE DATE:


SENT TO:	Reviewed Make Corrections As Noted
CBT Architects	Rejected Revise & Resubmit
Chris Pitman	
	Corrections and/or comments made on this submittal during this reliew do not relieve subcontractor from compliance with the requirements
	the drawings and specifications. This check is only for review of general
	compliance with the information given in the contract documents. The subcontractor is responsible for: confirming and correlating all quantities
	and dimensions; selecting fabailtion processes and techniques of
	construction; coordinating his work with that of all other trades; and performing his work in a safe and satisfactory manner.
APPROVED FURNISH AS CORRECTED	
	By: J Burton Date: 2/4/16
REJECTED REVISE AND RESUBMIT	
SUBMIT SPECIFIED ITEM	Arcbitect's-Stame
	CONTRACTOR TO FIELD VERIFY ALL EXISTING M.O.'S
This review is only for general conformance with the design concept of the	
project and general compliance with the information given in the Contract	WINDOW INSTALL GUIDELINES SAME AS 25 BEACON ST.
Documents. Corrections or comments made during this review do not relieve the contractor from compliance with the requirements of the plans	E
and specifications. Approval of a specific item shall not include approval of	
the assembly of which the item is a component. Contractor is responsible	
for: dimensions to be confirmed and correlated at the jobsite; information that pertains solely to the fabrication process or to the means, methods,	
techniques, sequences and procedures of construction; coordination of the	
work of all trades; and for performing all work in a safe and satisfactory	
manner.	
manner.	Frationals Change
DATE 02/29/2016 BY CHRIS PITMAN	Engineer's Stamp
617 262 4354 cbtarchitects.com 110 canal street boston, ma 02114 JOB # 147021	
110 canal street boston, ma 02114 JOB #	




	€ ROOF 155' - 6 7/16"	
		METAL RAILING, DESIGN TO MATCH EXISTING, PTD
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		AND DOWNSPOUTS
	JOY PLA COURTYARD 95' - 0"	EXIST. BROWNSTONE SILLS, LINTELS TO BE PATCHED AND RECOATED
		3 East Elevation 1/4" = 1'-0"
REVISIONS # DATE DESCRIPTION	25 BEACON 25 BEACON STREET/	6-7 MT VERNON STREET BOSTON, MA 02108
		2 4354 cbtarchitects.com al street boston, ma 02114

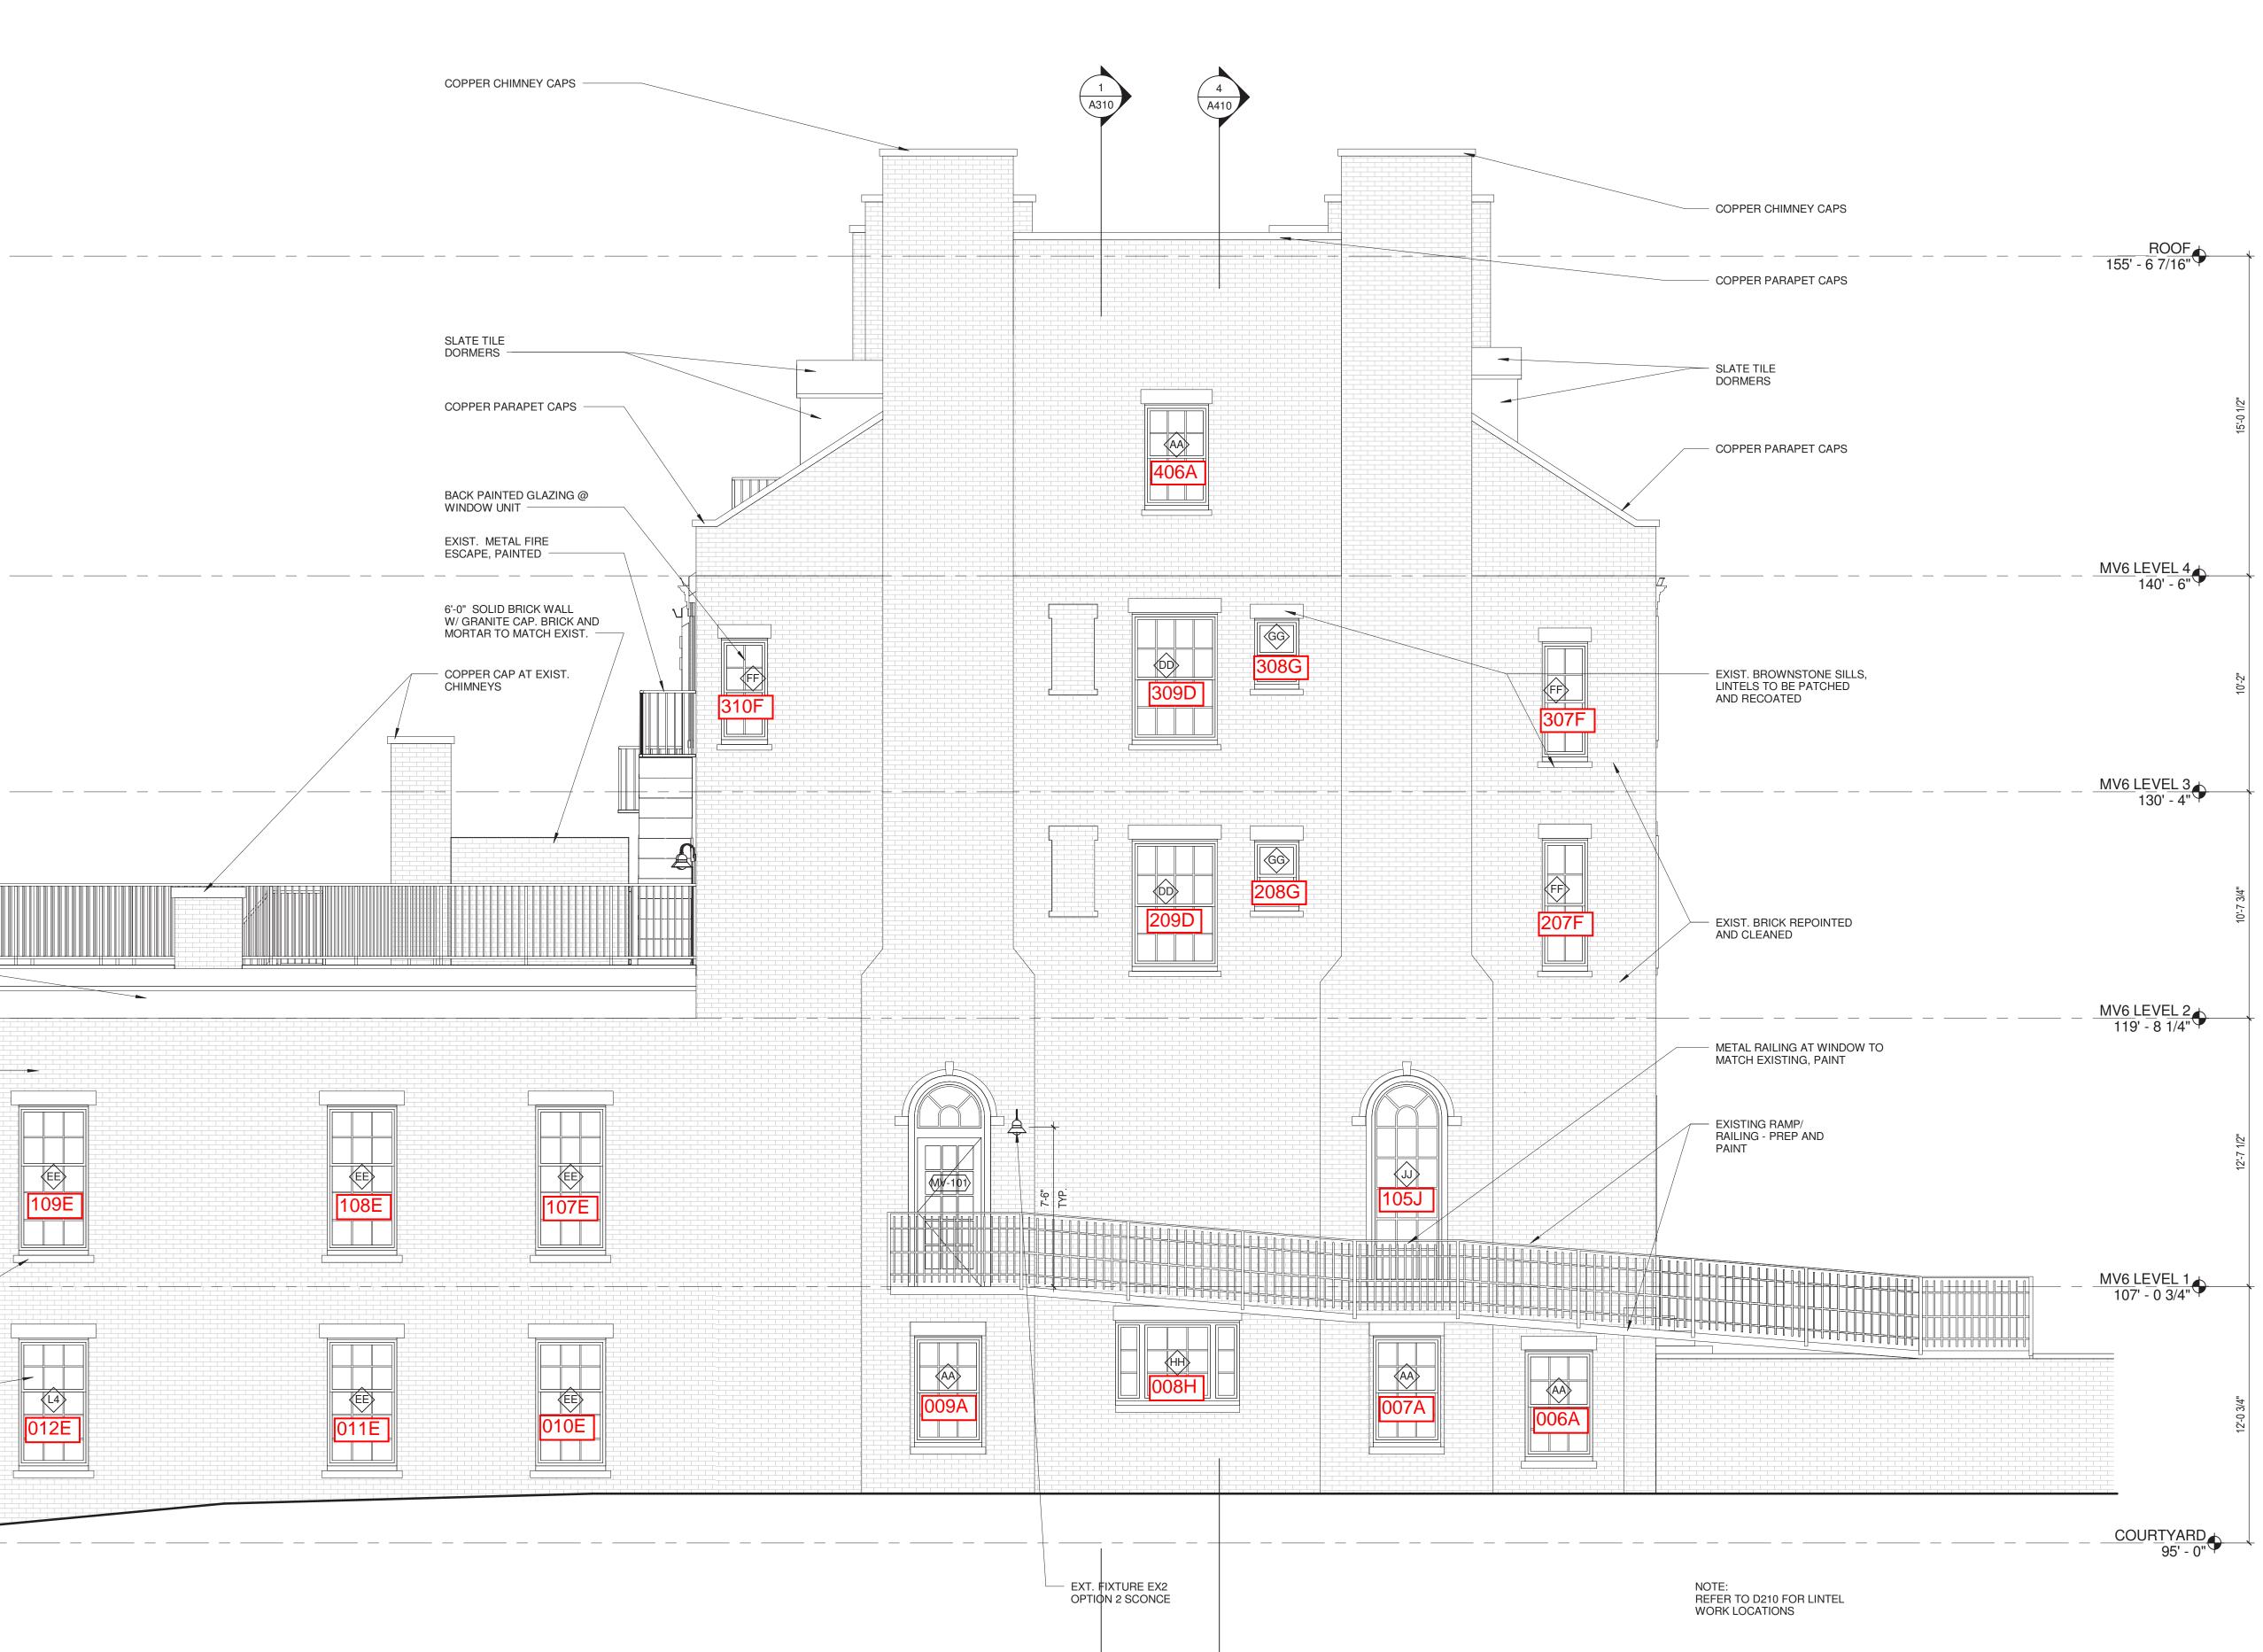


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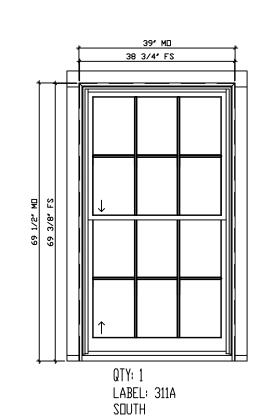


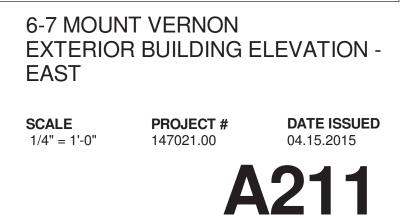


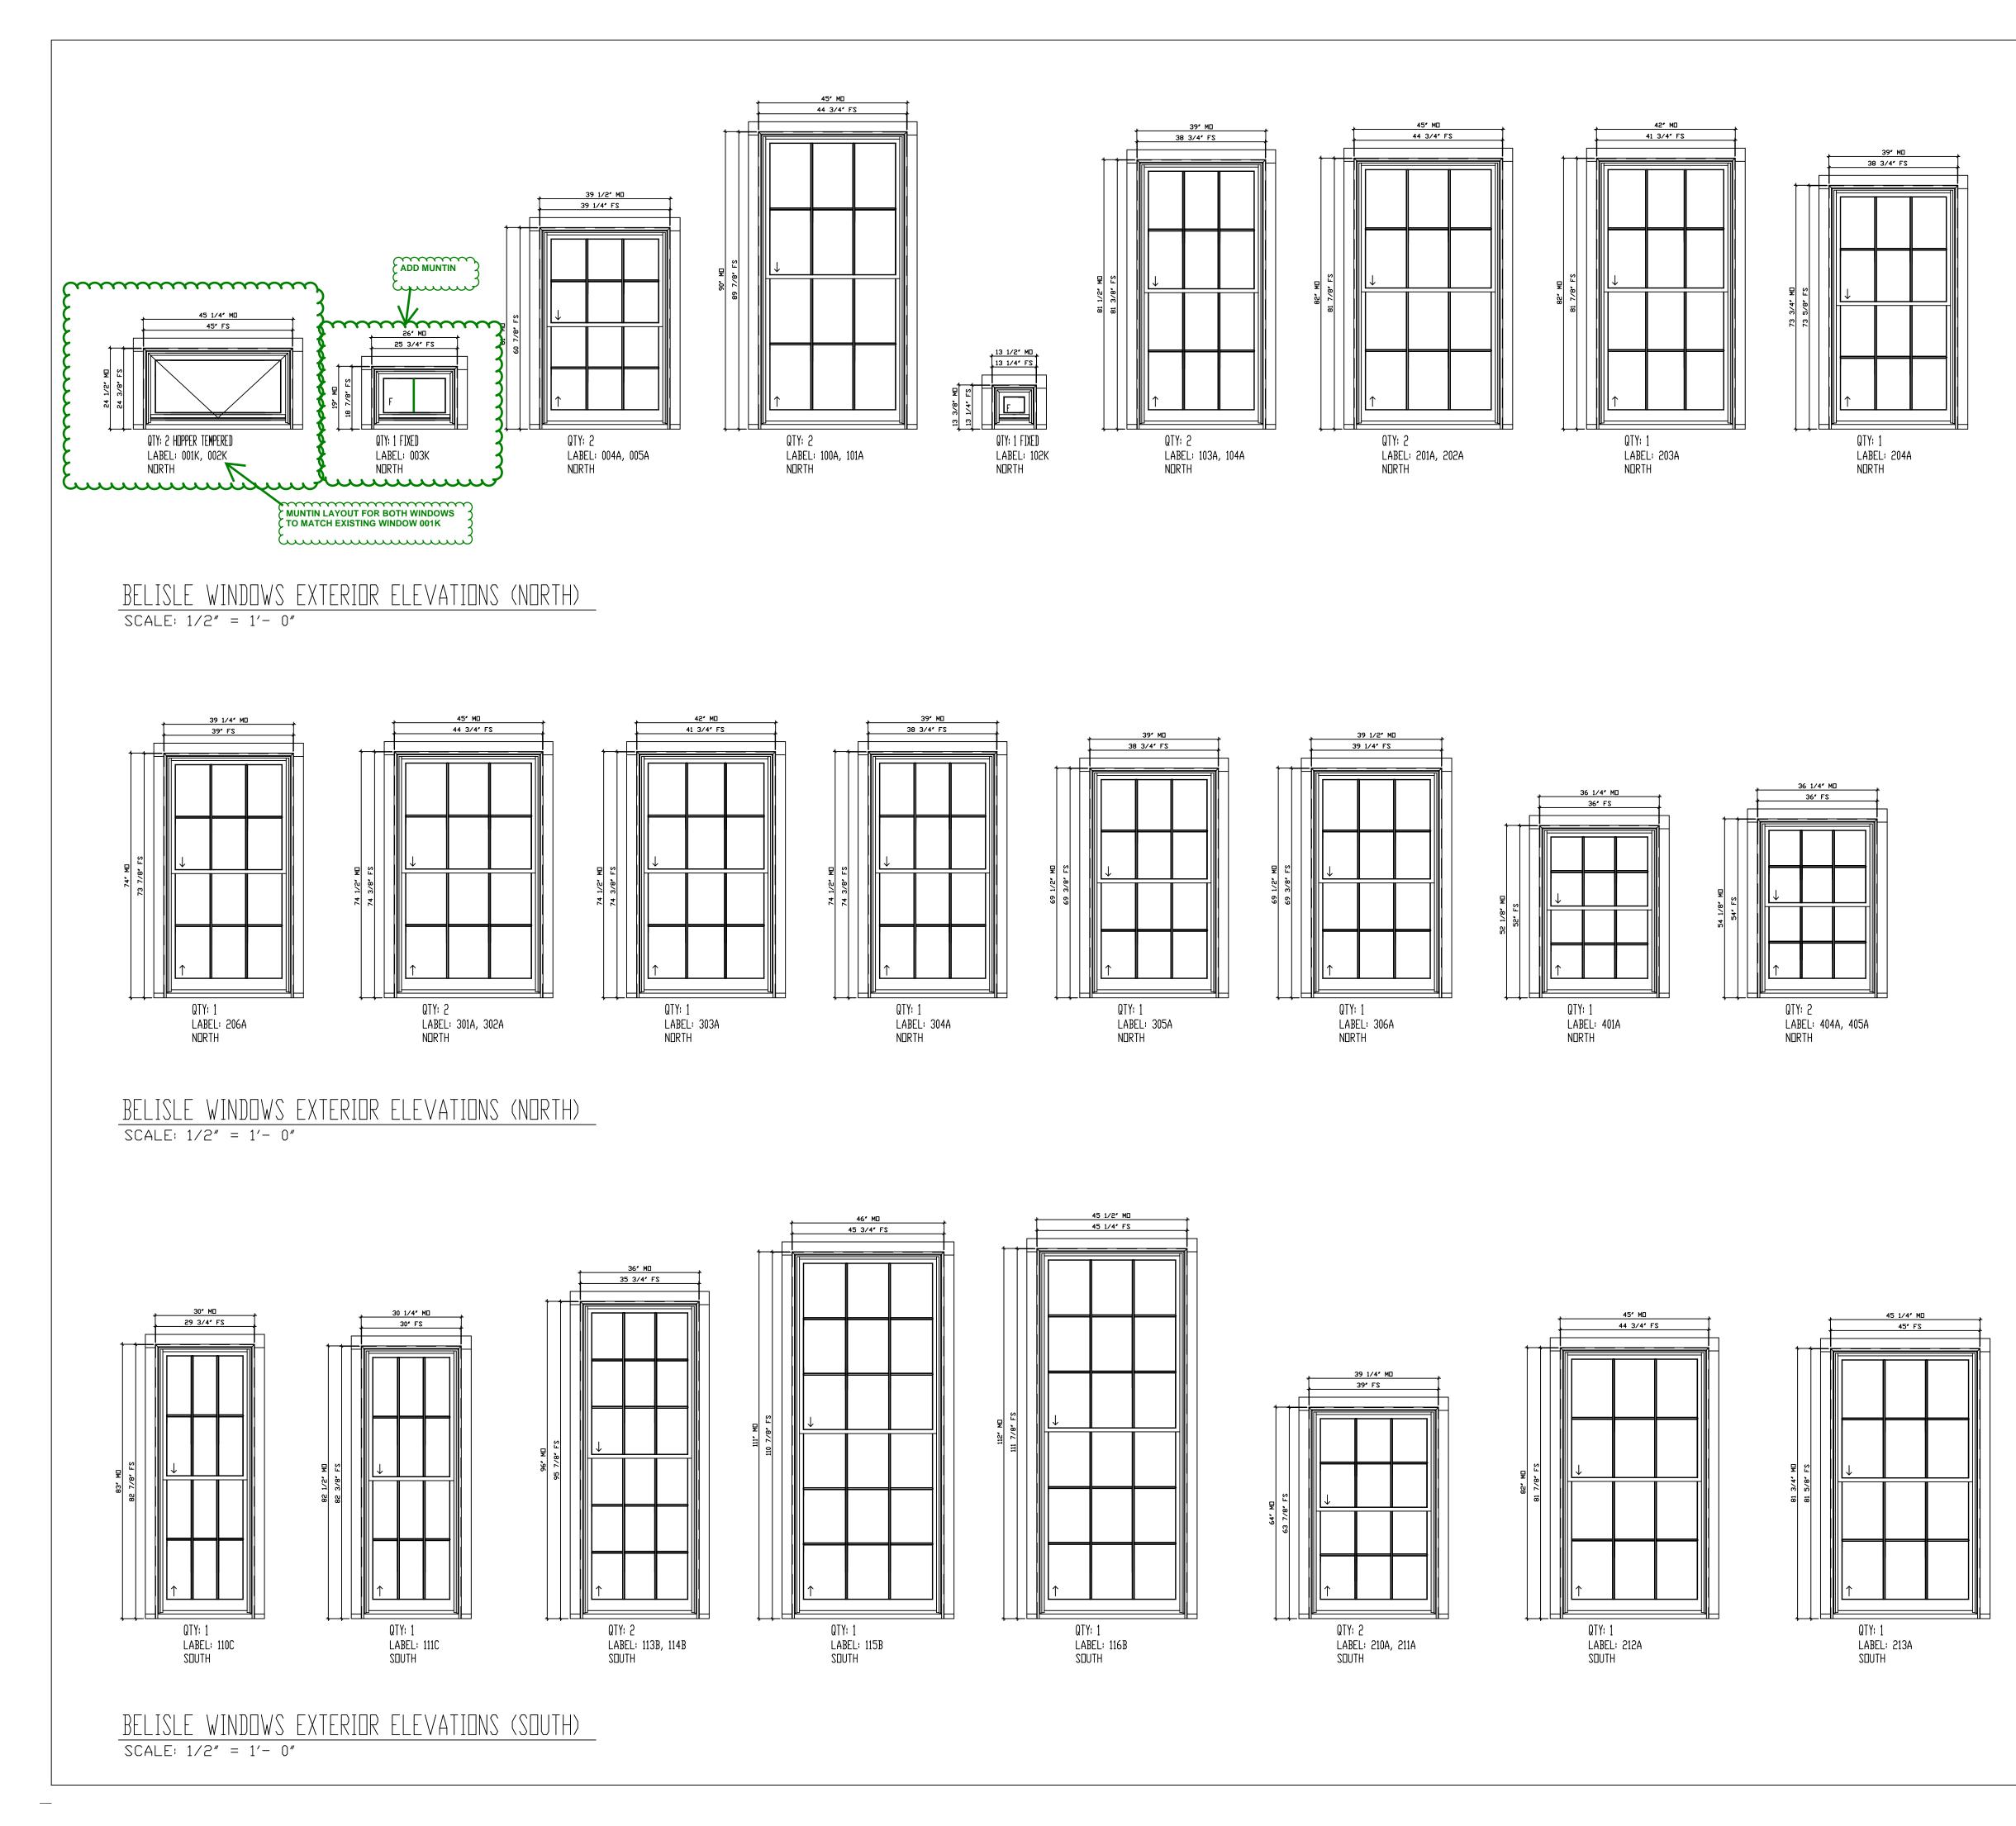WINDOW HARDWARE: - US10B #4217 ARC SASH LOCK (1) DOOR HARDWARE: - US10B mass ball bearing hinges with flat tips - US10B #301 ARC SASH LIFTS (2) - US10B mass ball bearing hinges - US10B mass ball bearing hinges - US10B #6 ARC GROMMETS - US10B mass ball bearing hinges - US10B mass ball bearing hinges - US10B #6 ARC GROMMETS - US10B mass ball bearing hinges - US10B mass ball bearing hinges - US10B #6 ARC GROMMETS - UUNTINS: - US10M 5/8" SDL MUNTINS WITH BLACK SPACER BARS - US10B #6 ARC GROMMETS MUNTINS: - CUSTOM 5/8" SDL MUNTINS WITH BLACK SPACER BARS - CUSTOM BrickMold TO MATCH EXISTING (SHIPPED LOOSE) - UNINEN - CUSTOM 5/8" SDL MUNTINS WITH BLACK SPACER BARS - CUSTOM BRICKMOLD TO MATCH EXISTING (SHIPPED LOOSE) - PRIMED INTERIOR, PAINTED EXTERIOR - PRIMED INTERIOR, PAINTED EXTERIOR - CUSTOM BRICKMOLD TO MATCH EXISTING (SHIPPED LOOSE) - PRIMED INTERIOR, PAINTED EXTERIOR - PRIMED SUBMITED	MANUFACTURER: Beliste Architectural Doors and Windows Ist Submital: 56 East Gauvin St. St-Jean-De-Dieu, QC, Canada, GOL 3MO AUGUST 17TH, 2015 7EL) 866-851-5113 (Toll Free) (Fax) 418-963-2200 JANUARY 12TH, 2016	RESENTATIVE: FREDDY MAGUIRE BUILDER: SEA-DAR CONSTRUCTION PAGE: 7
MATERIAL: INDOMS: WESTERN RED CEDAR, DOORS: AFRICAN WHOGANY (KIXN) CLASS 3/4" TOTAL IGU: LOWE (EPS) + ARGON IGU, STANDARD GLASS THICKNESS SCREEN: BLACK HALF ALUMINUM FRAME SCREEN WITH CLEARVIEW MESH AT INT. AND EXT. LITE, BLACK SPACER, TEMPERED AS INDICATED. JAMB: 6 9/16" AT WINDOWS AND DOORS AT DOORS AT DOORS SASH: 1 3/4" THICK AT WINDOWS, 2 1/4" AT DOORS 2 1/4" AT DOORS	PROJECT: 6-7 MOUNT VERNON MANU PROJECT: PROPOSAL #11187	DELIVERY ADDRESS: BOSTON, MA, USA DRAWN BY: <i>Xeuin Shibault</i>

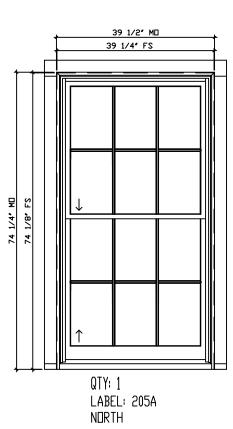



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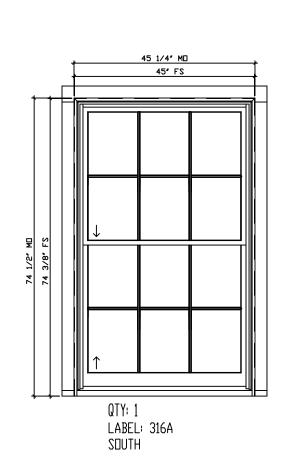


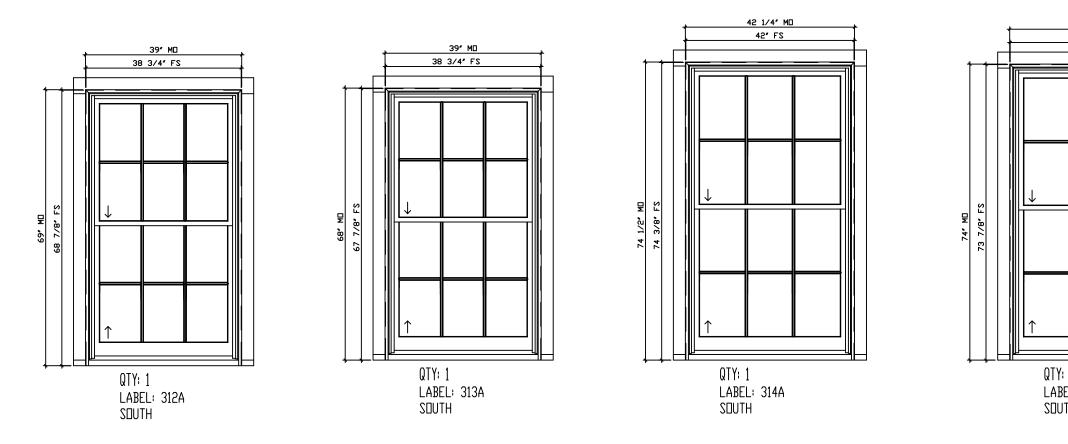



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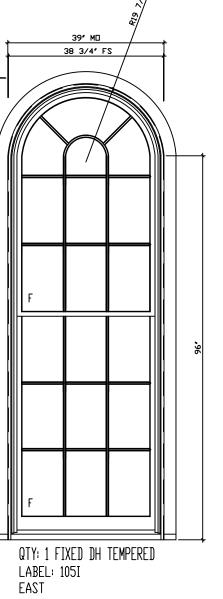





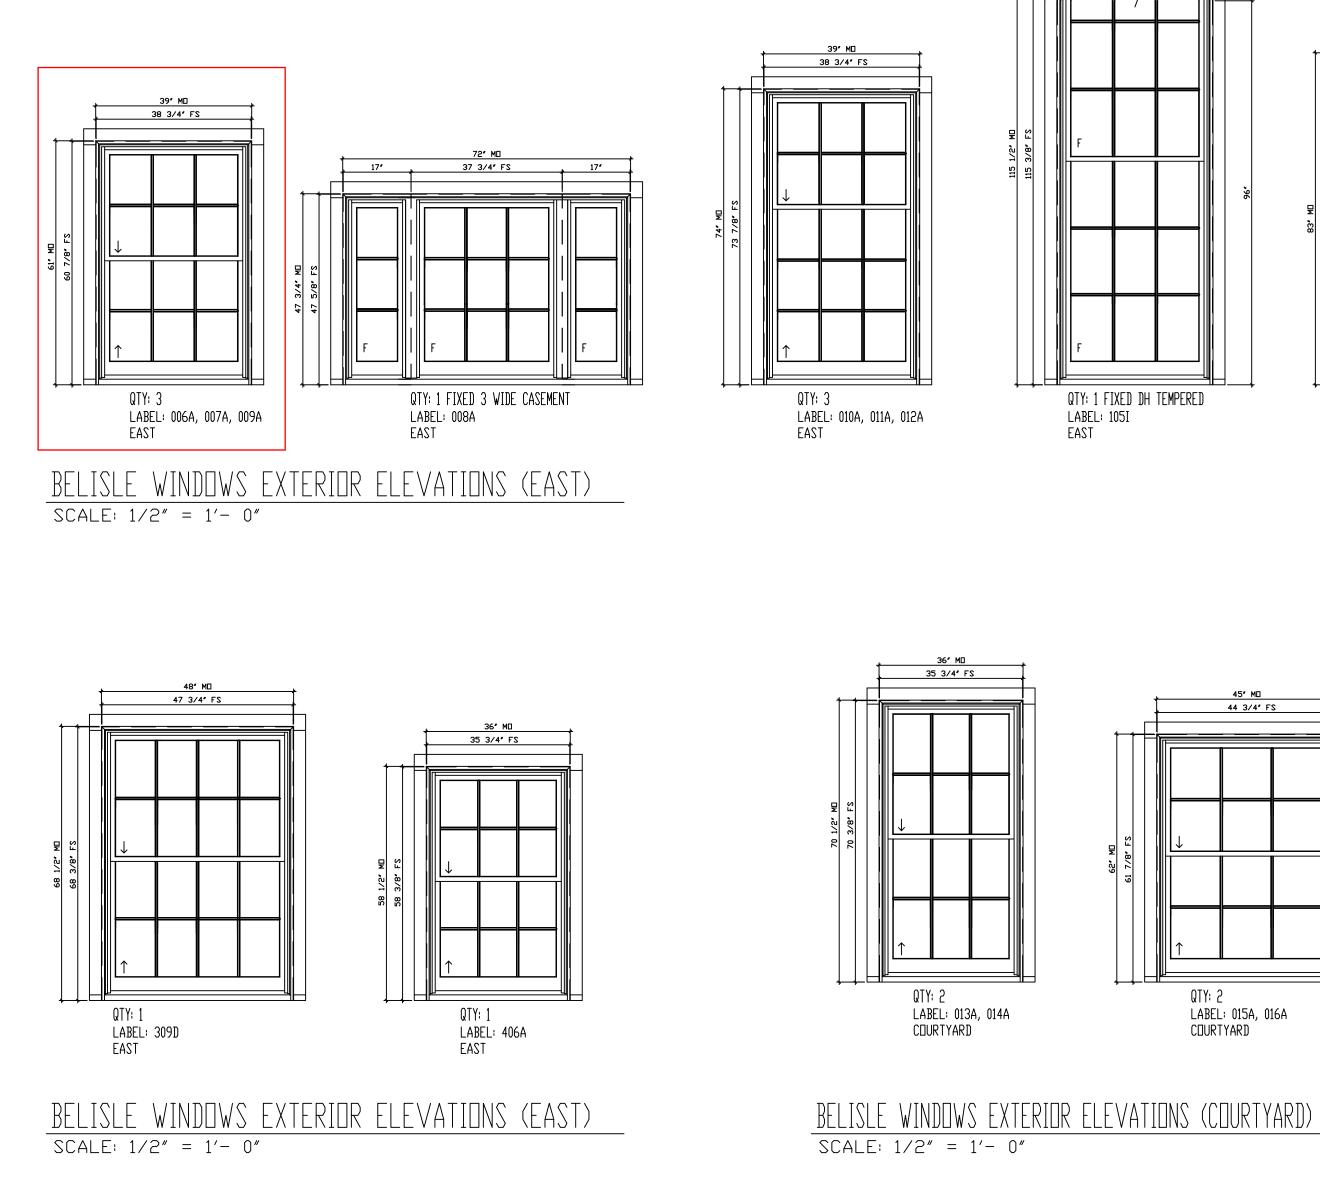


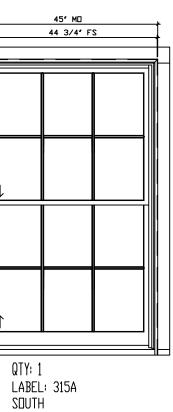


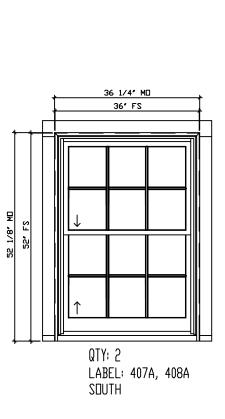


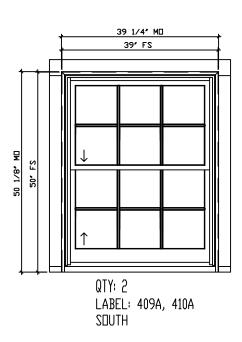


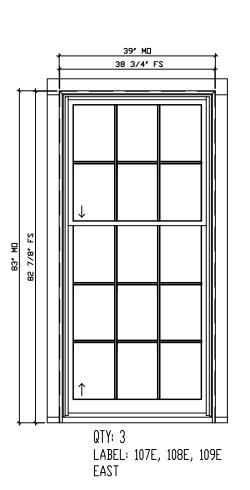

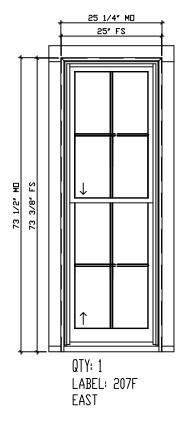


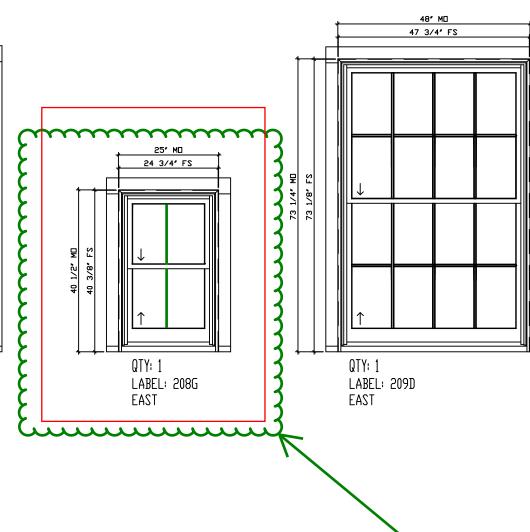


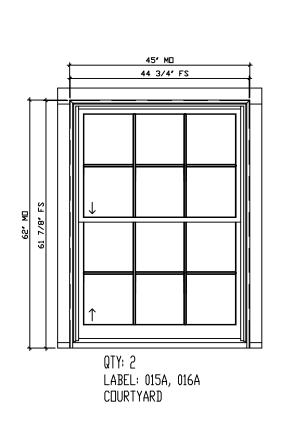

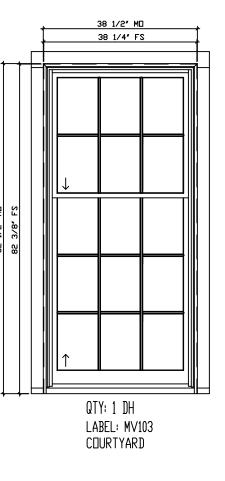



		ASS THICKNESS <u>WINDOW HARDWARE:</u> - US10B #4217 ARC SASH LOCK (1) <u>DOOR HARDWARE:</u> - US10B SOLID BRASS BALL BEARING HINGES WITH FLAT TIPS - US10B #301 ARC SASH LIFTS (2) - MULTI-POINT LOCK MECHANISM ONLY (TRIM BY OTHERS) - US10B #6 ARC GROMMETS <u>MUNTINS:</u> - US10B SOLID BRASS BALL BEARING HINGES WITH FLAT TIPS - US10B #6 ARC GROMMETS <u>MUNTINS:</u> - US10B SOLID BRASS BALL BEARING HINGES WITH FLAT TIPS - US10B #6 ARC GROMMETS <u>MUNTINS:</u> - US10B SOLID BRASS BALL BEARING HINGES WITH FLAT TIPS - US10B #6 ARC GROMMETS <u>MUNTINS:</u> - US10D 5/8" SDL MUNTINS WITH BLACK SPACER BARS - USTOM BROKMOLD TO MATCH EXISTING (SHIPPED LOOSE) <u>FINISH:</u> - PRIMED INTERIOR, PAINTED EXTERIOR (BLACK - GENTEK 525 TO MATCH SCREIN CAURDED FOR SAMPLEED EXTERIORED	MANUFACTURER: Belisle Architectural Doors and Windows Ist Submital: 56 East Gauvin St. St-Jean-De-Dieu, QC, Canada, GOL 3M0 AUGUST 17TH, 2015 56 East Gauvin St. St-Jean-De-Dieu, QC, Canada, GOL 3M0 AUGUST 17TH, 2016 7eL) 866-851-5113 (Toll Free) (Fax) 418-963-2200 JANUARY 12TH, 2016	REPRESENTATIVE: FREDDY MAGUIRE BUILDER: SEA-DAR CONSTRUCTION PAGE: 2
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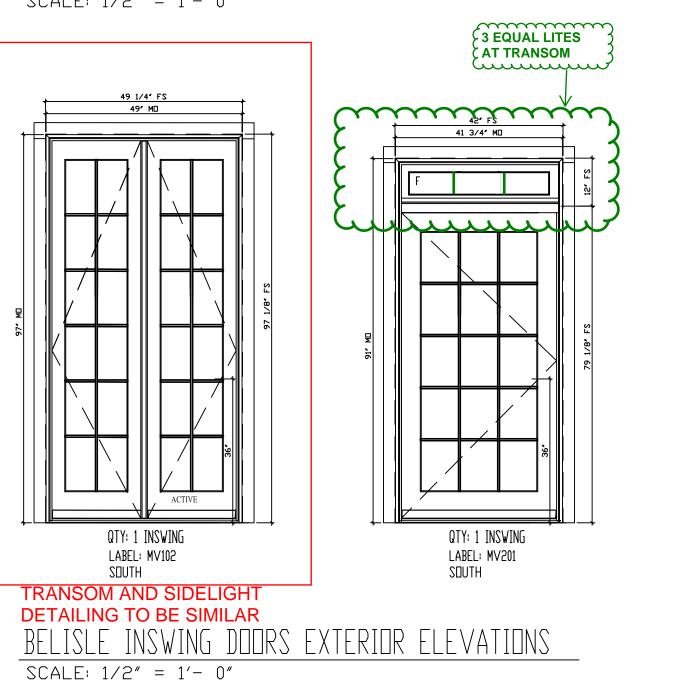


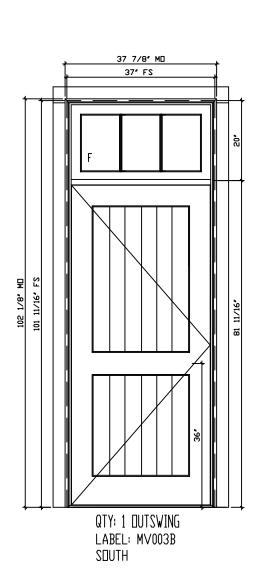
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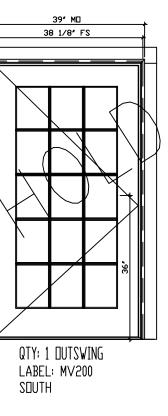


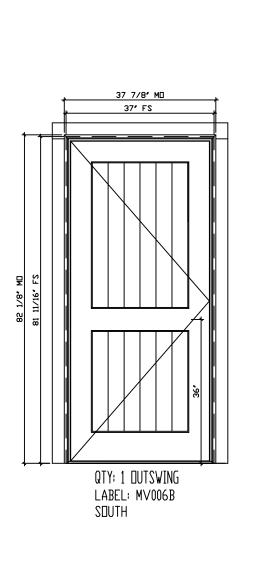



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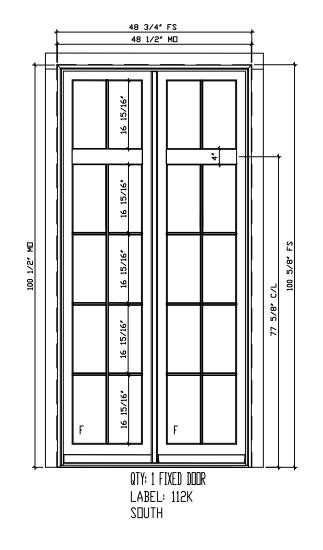


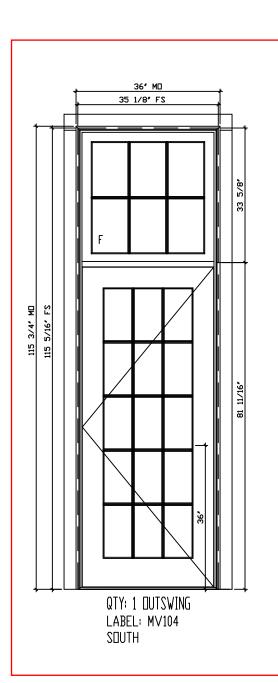

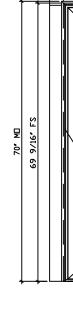


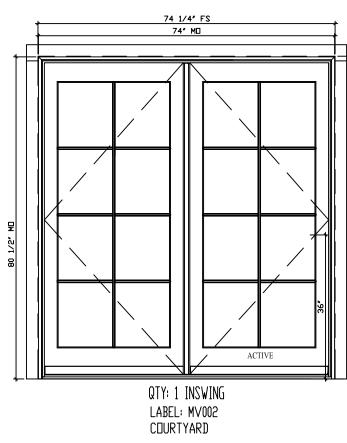


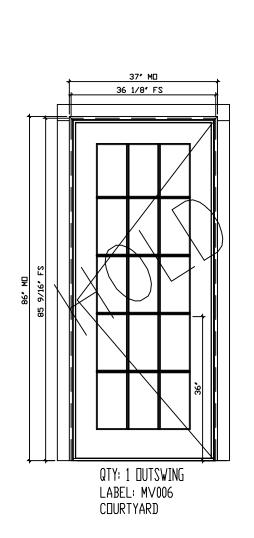


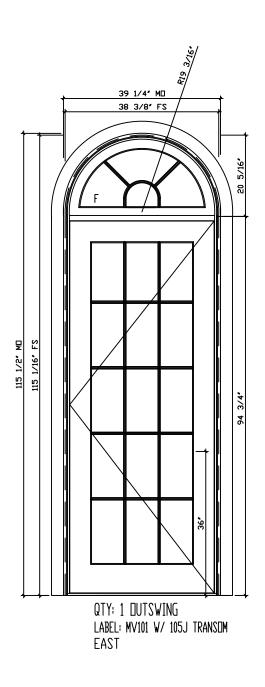

MATERIAL: WIDOWS: WESTERN RED CEDNR, DOORS: AFRICAN WHOGANY (KMA) GLASS 3/4" TOTAL IGU: LOWE (EPS) + ARGON IGU, STANDARD GLASS THICKNESS SCREEN: BLACK HALF ALUMINUM FRAME SCREEN WITH CLEARVIEW MESH AT INT. AND EXT. LITE, BLACK SPACER, TEMPERED AS INDICATED. JAMB: 6 9/16" AT WINDOWS AND DOORS SASH: 1 3/4" THICK AT WINDOWS, 2 1/4" AT DOORS	GLASS THICKNESS WINDOW HARDWARE: - US10B #4217 ARC SASH LOCK (1) DOOR HARDWARE: - US10B BRASS BALL BEARING HINGES WITH FLAT TIPS ED. - US10B #301 ARC SASH LIFTS (2) - UUTI-POINT LOCK MECHANISM ONLY (TRIM BY OTHERS) - US10B #6 ARC GROMMETS - UUTI-POINT LOCK MECHANISM ONLY (TRIM BY OTHERS) - US10B #6 ARC GROMMETS - UUTI-POINT LOCK MECHANISM ONLY (TRIM BY OTHERS) - US10B #6 ARC GROMMETS - UUTI-POINT LOCK MECHANISM ONLY (TRIM BY OTHERS) - US10B #6 ARC GROMMETS - UUTINS: - CUSTOM 5/8" SDL MUNTINS WITH BLACK SPACER BARS - OUSTOM BRICKMOLD TO MATCH EXISTING (SHIPPED LOOSE) - PRIMED INTERIOR, PAINTED EXTERIOR - PRIMED INTERIOR, PAINTED EXTERIOR - CUSTOM BRICKMOLD TO MATCH EXISTING (SHIPPED LOOSE) - PRIMED INTERIOR, PAINTED EXTERIOR - PRIMED INTERIOR, PAINTED EXTERIOR
PROJECT: 6-7 MOUNT VERNON	
PROJECT: PROPOSAL #11187	(TeL) 866-851-5113 (Toll Free) (Fax) 418-963-2200 JANUARY 12TH, 2016
DELIVERY ADDRESS: BOSTON, MA, USA	REPRESENTATIVE: FREDDY MAGUIRE
DRAWN BY: Kevin Thibault	BUILDER: SEA-DAR CONSTRUCTION PAGE: 3

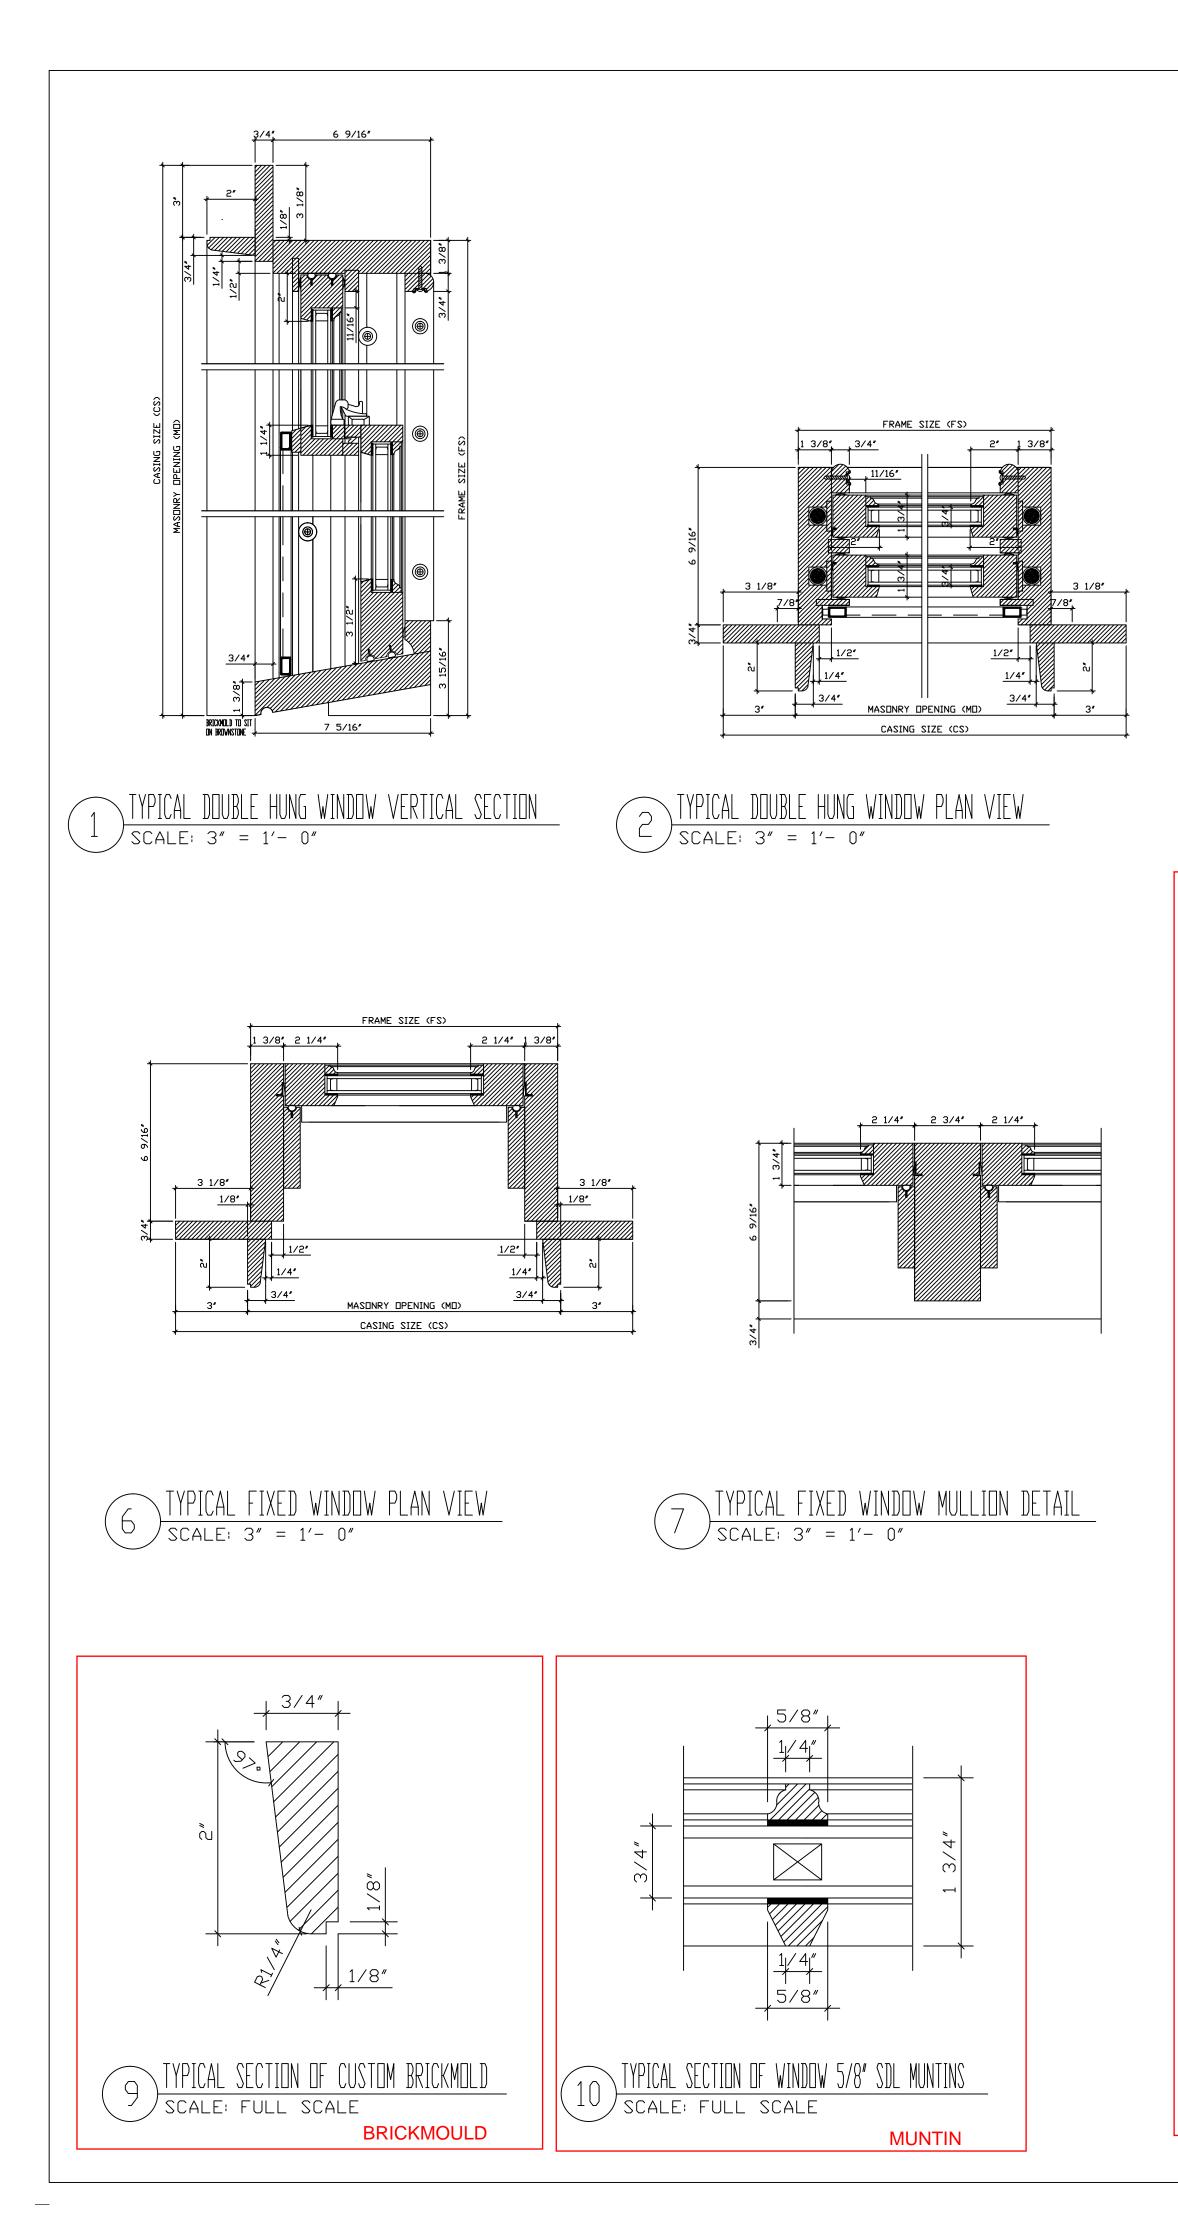


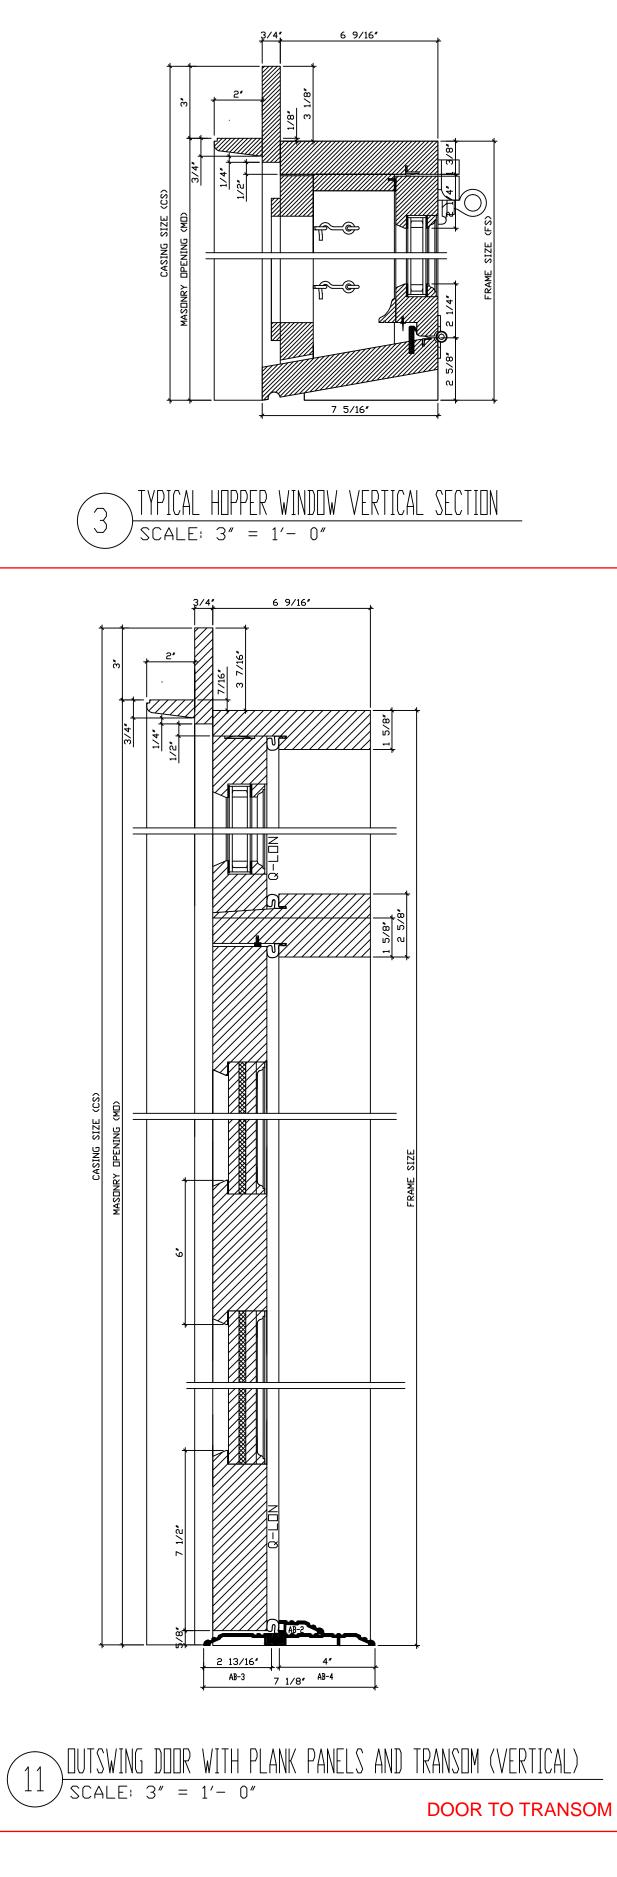

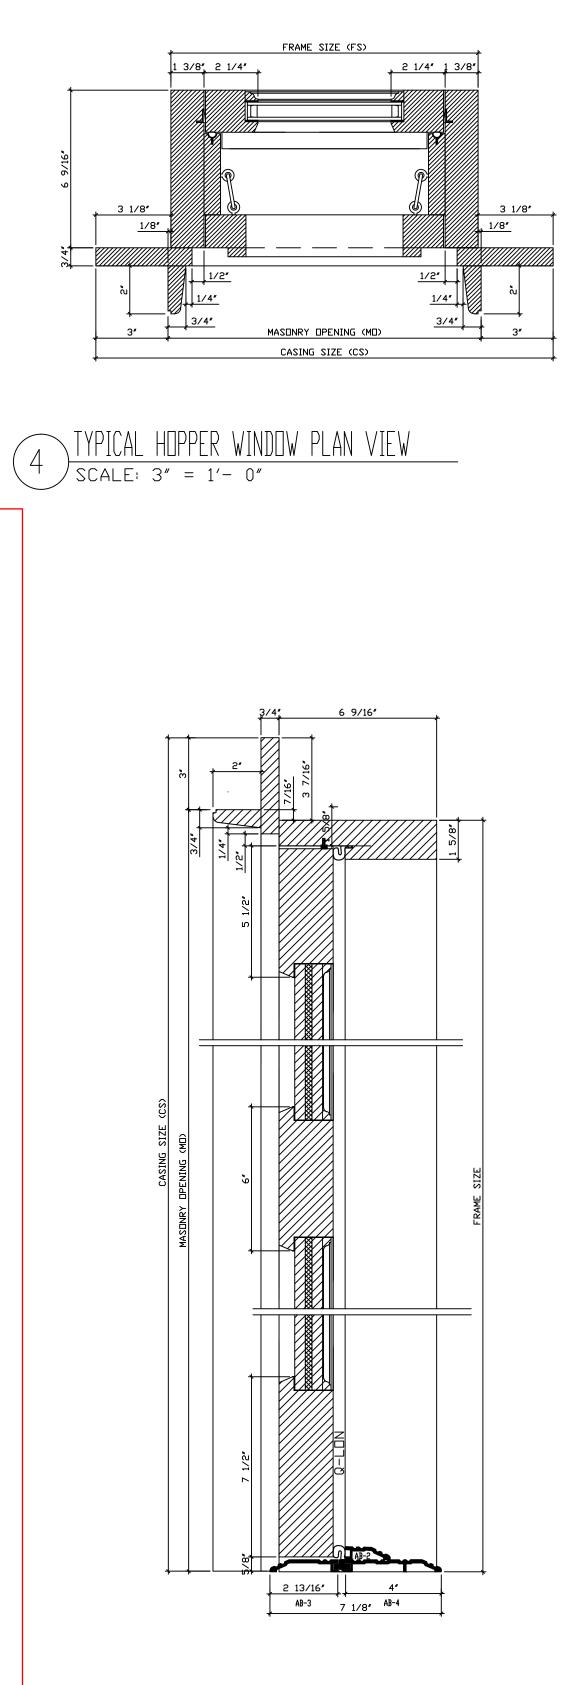


 $12 \xrightarrow{\text{DUTSWING DOOR WITH PLANK PANELS (VERTICAL)}}{\text{SCALE: } 3'' = 1' - 0''}$


6 9/16'	ASS THICKNESS WINDOW HARDWARE: - US10B #4217 ARC SASH LOCK (1) DOOR HARDWARE: - US10B SOLID BRASS BALL BEARING HINGES WITH FLAT TIPS - US10B #501 ARC SASH LIFTS (2) - MULTI-POINT LOCK MECHANISM ONLY (TRIM BY OTHERS) - US10B #6 ARC GROMMETS - MUNTINS: - CUSTOM 5/8" SDL MUNTINS WITH BLACK SPACER BARS - US10B #6 ARC GROMMETS - MUNTINS: - CUSTOM 5/8" SDL MUNTINS WITH BLACK SPACER BARS - USTOM BRICKMOLD TO MATCH EXISTING (SHIPPED LOOSE) - PRIMED INTERIOR, PAINTED EXTERIOR - CUSTOM BRICKMOLD TO MATCH EXISTING (SHIPPED LOOSE) - PRIMED INTERIOR, PAINTED EXTERIOR - CUSTOM BRICKMOLD TO MATCH EXISTING (SHIPPED LOOSE) - PRIMED INTERIOR, PAINTED EXTERIOR - CUSTOM BRICKMOLD TO MATCH EXISTING (SHIPPED LOOSE) - PRIMED INTERIOR, PAINTED EXTERIOR	MANUFACTURER: Beliste Architectural Doors and Windows Ist Submital: 56 East Gauvin St. St-Jean-De-Dieu, QC, Canada, GOL 3M0 REVISED: 7TH, 2015 JANUARY 12TH, 2016 7EL) 866-851-5113 (Toll Free) (Fax) 418-963-2200 JANUARY 12TH, 2016	REPRESENTATIVE: FREDDY MAGUIRE BUILDER: SEA-DAR CONSTRUCTION PAGE: 4
Image: constrained with the second withe second withe second with the second withe second with	MATERIAL: INDOMS: MERTEN RED CEDAR, DOORS: AFRCAN IMMOGNY (MNA) CLASS 3/4" TOTAL IGU: LOWE (EPS) + ARGON IGU, STANDARD GLASS THICKNESS SCREEN: BLACK HALF ALUMINUM FRAME SCREEN WITH CLEARVIEW MESH AT INT. AND EXT. LITE, BLACK SPACER, TEMPERED AS INDICATED. JAMB: 6 9/16" AT WINDOWS AND DOORS AT DOORS SASH: 1 3/4" THICK AT WINDOWS, 2 1/4" AT DOORS	PROJECT: 6-7 MOUNT VERNON PROJECT: PROPOSAL #11187	DELIVERY ADDRESS: BOSTON, MA, USA DRAWN BY: Xewin Shibault

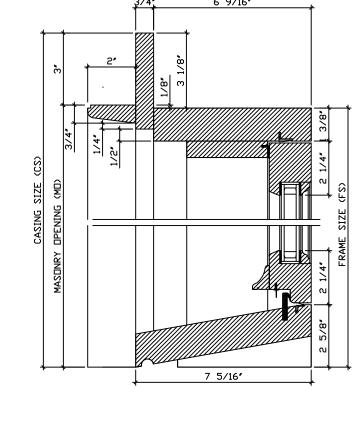





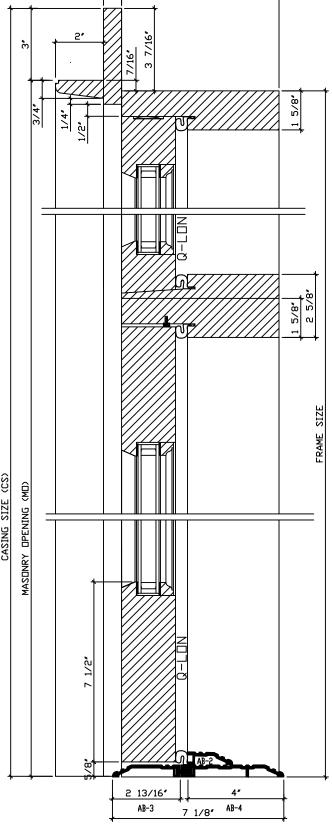


 $13 \frac{\text{DUTSWING GLASS DOD}}{\text{SCALE: } 3'' = 1' - 1'}$

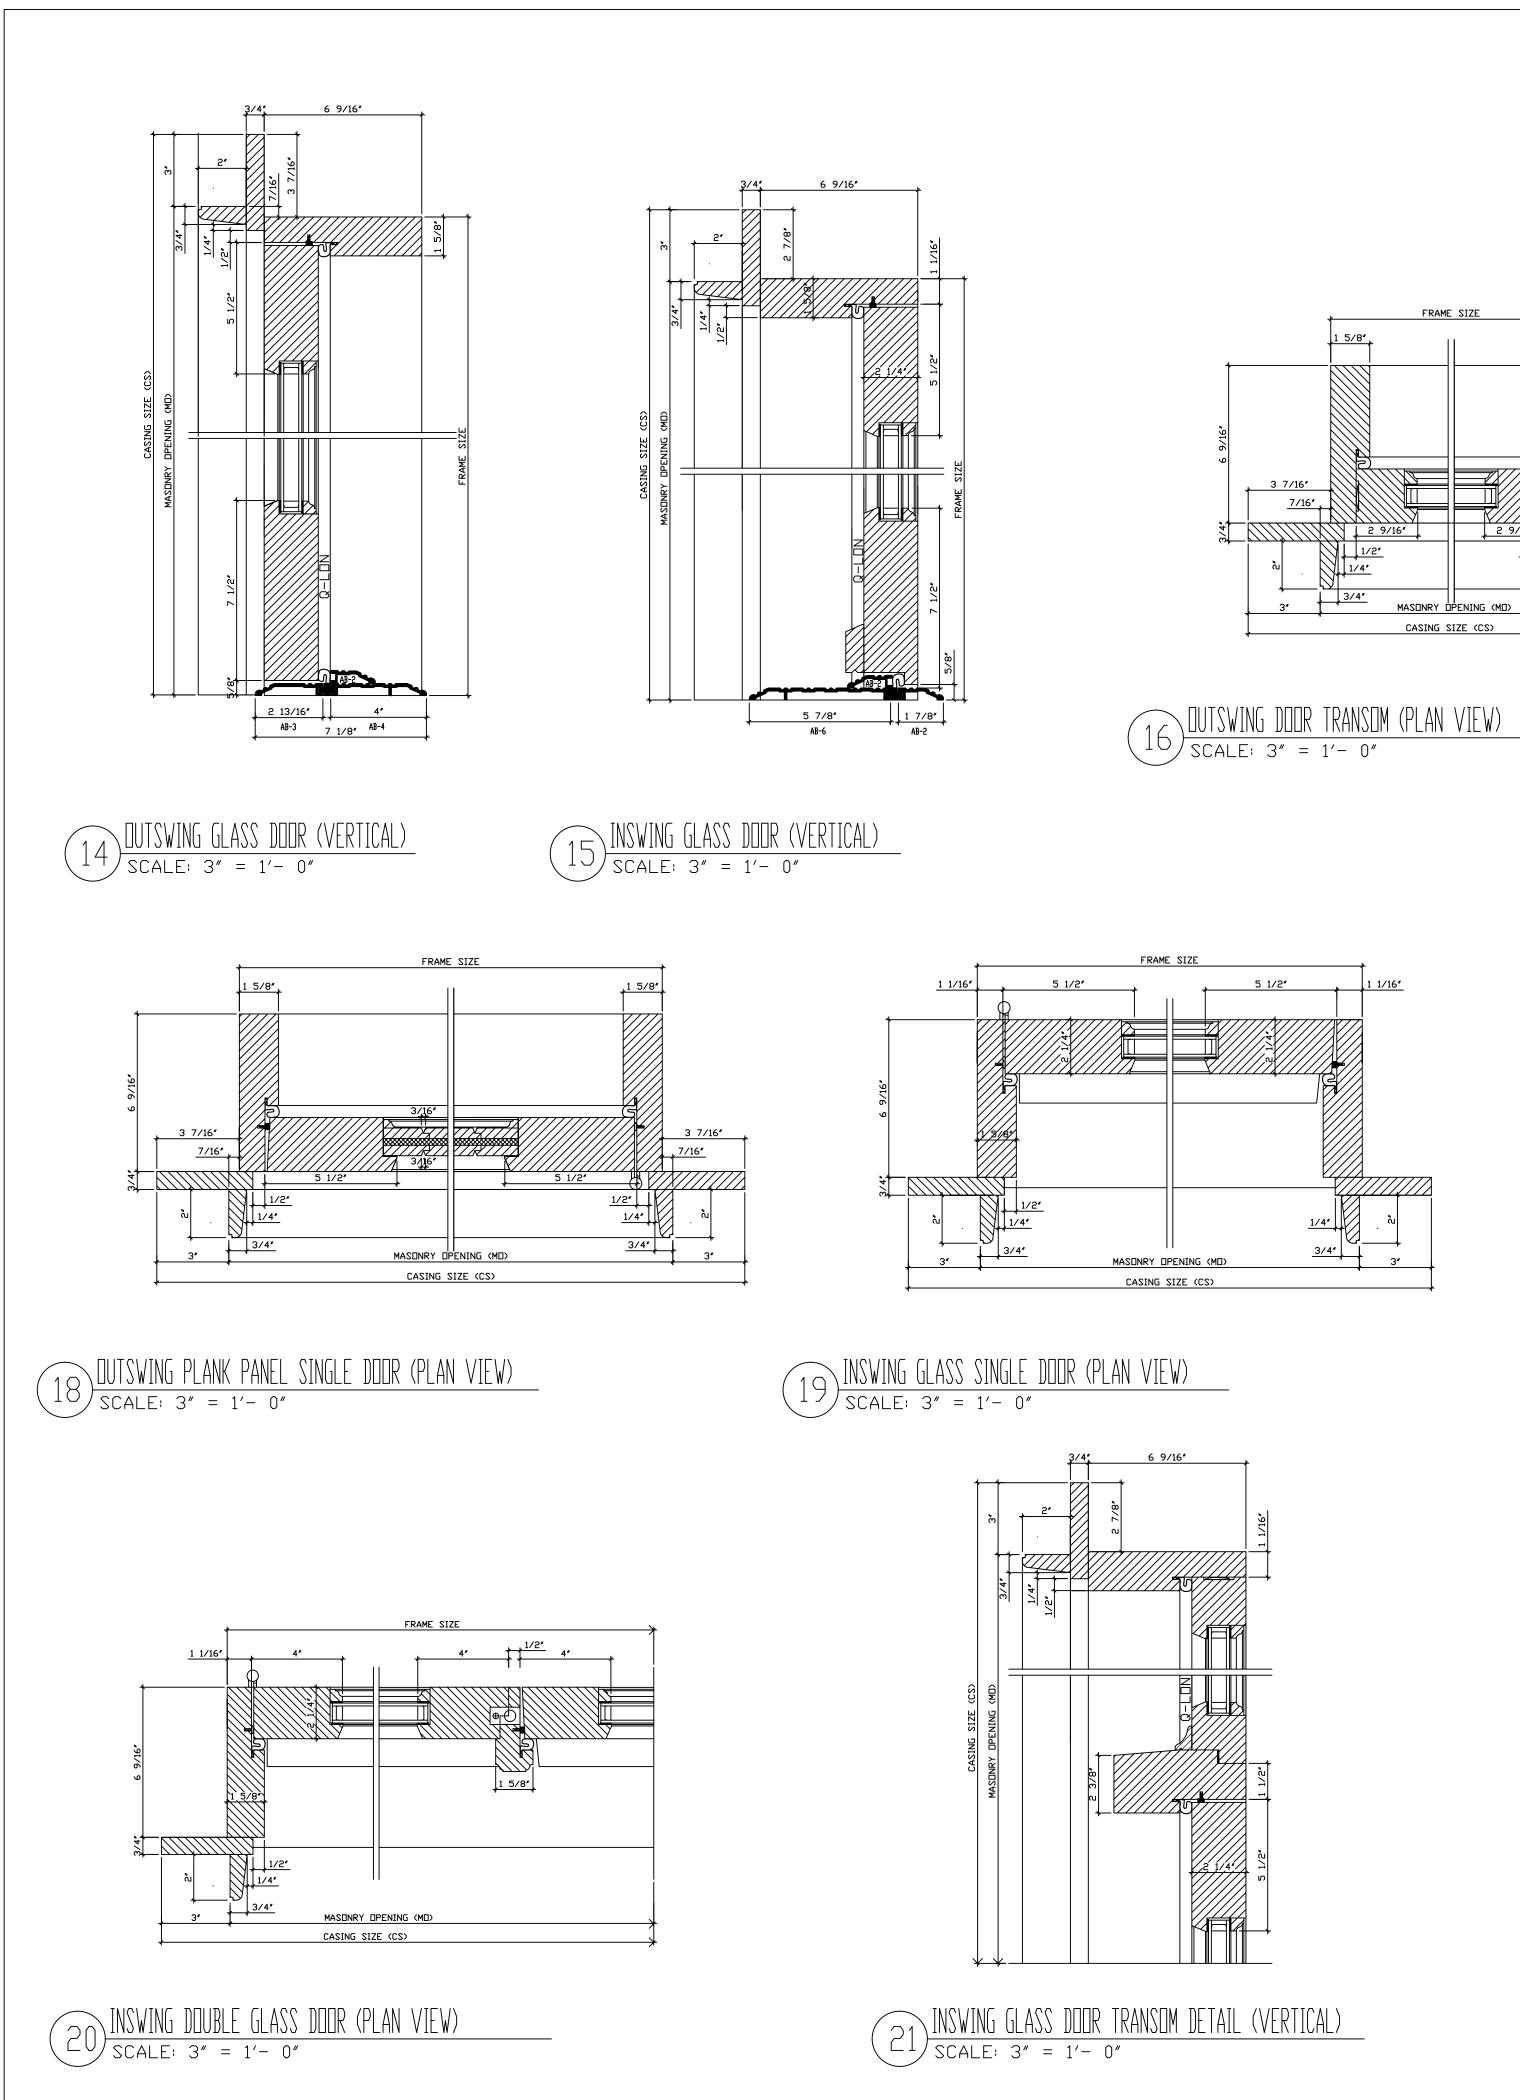

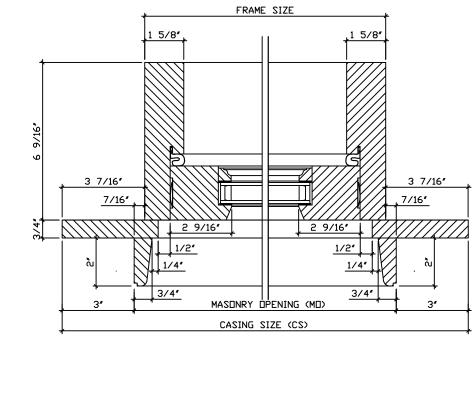


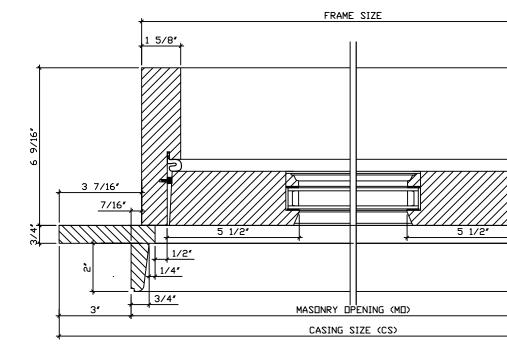




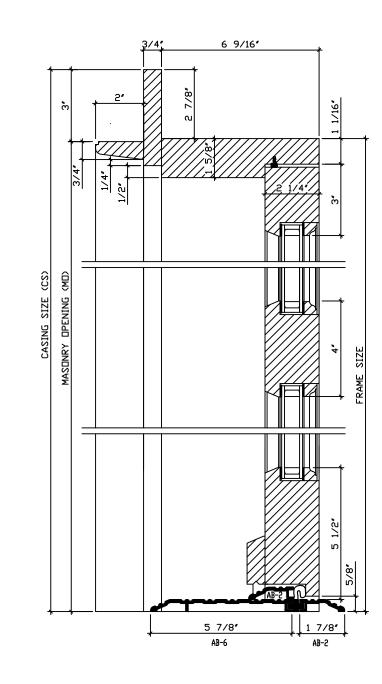


(22) FIXED GLASS DOOR (VERTICAL)Scale: 3" = 1'- 0"

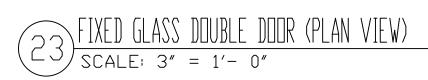


1 1/16"

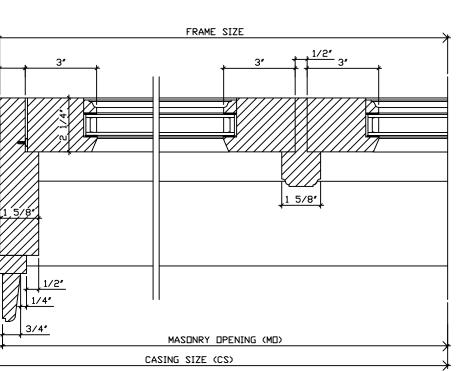

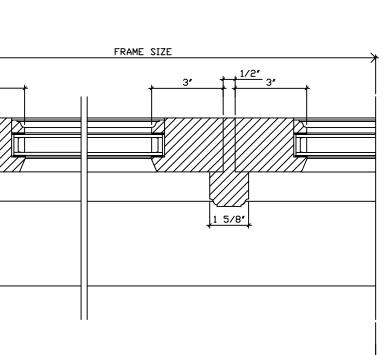

 US10B SOLID BRASS BALL BEARING HINGES WITH FLAT TIPS MULTI-POINT LOCK MECHANISM ONLY (TRIM BY OTHERS) CUSTOM 5/8" SDL MUNTINS WITH BLACK SPACER BARS PRIMED INTERIOR, PAINTED EXTERIOR (BLACK - GENTEK 525 TO MATCH SCREEN COLOR - PER SAMPLE SUBMITTED) 	<u>1st Submital:</u> AUGUST 17TH, 2015 <u>REVISED:</u> 10011002 10710 2016			PAGE: 5
DOOR HARDWARE:	Doors and Windows	(Fax) 418-963-2200		NSTRUCTION
WINDOW HARDWARE: - US10B #4217 ARC SASH LOCK (1) - US10B #301 ARC SASH LIFTS (2) - US10B #6 ARC GROMMETS - US10B #6 ARC GROMMETS CASING: - 3/4" X 4" FACTORY INSTALLED EXTERIOR FLAT CASING - CUSTOM BRICKMOLD TO MATCH EXISTING (SHIPPED LOOSE)	MANUFACTURER: Belisle Architectural Doors and Windows 56 East Gauvin St., St-Jean-De-Dieu, QC, Canada, GOL 3MD	(TeL) 866-851-5113 (Toll Free) (Fax) 418-963-2200	REPRESENTATIVE: FREDDY MAGUIRE	BUILDER: SEA-DAR CONST
3/4" Total Igu: Lowe (EPS) + Argon Igu, standard glass Thickness At Int. And ext. Lite, Black Spacer, tempered as indicated.	AOUNT VERZOZ MANUF		REPRE	
MATERIAL:WNDOWS: WESTERN RED CEDAR, DOORS: AFRICAN WHOCANY (KNA)GLASS :SCREEN:BLACK HALF ALUMINUM FRAME SCREEN WITH CLEARVIEW MESHJAMB:6 9/16" AT WINDOWS AND DOORSSASH:1 3/4" THICK AT WINDOWS, 2 1/4" AT DOORS	PROJECT: 6-7 MOUN	PROJECT: PROPOSAL #11187	DELIVERY ADDRESS: BOSTON, MA, USA	DRAWN BY: Revin Thibault

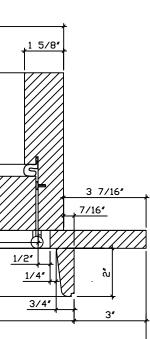

ATTACHMENT B - DOG AND PINTLE



PROJECT APPROVED PINTLE



INSTALLED 25 BEACON PINTLE

APPROVED SHUTTER DOG



6MV SHUTTERS





ATTACHMENT A - SHUTTERS

SUBMITTAL 062000-02

SEA-DAR CONSTRUCTION

Building trust one project at a time

Revision # 0

TITLE:	6/7 MVP - Shutters		SENT DATE:	10/15/2015
PROJECT:	25 Beacon/6-7 Mt Vernon		JOB:	14-110
PACKAGE:	Finish Carpentry		DUE DATE:	
SENT TO: CBT Architect Chris Pitman	ED V FURNISH AS CORRECTED	do not relie the drawing compliance subcontract and dimensio construction		bmit during this review her requirefnents r review of gereral t documents. The elating all quant ities iniques of her trades; and
This review is project and ge Documents. Correlieve the con and specification the assembly of for: dimensions that pertains so techniques, se	ED REVISE AND RESUBMIT SPECIFIED ITEM only for general conformance with the design concept of the neral compliance with the information given in the Contract orrections or comments made during this review do not stractor from compliance with the requirements of the plans ons. Approval of a specific item shall not include approval of of which the item is a component. Contractor is responsible is to be confirmed and correlated at the jobsite; information olely to the fabrication process or to the means, methods, equences and procedures of construction; coordination of the les; and for performing all work in a safe and satisfactory	Archited	Burton Date: 10/1	<u>5/1</u> 5
cht 6	AV20/2015 BY CHRIS PITMAN 17 262 4354 cbtarchitects.com 10 canal street boston, ma 02114 JOB # 147021	Enginee	er's Stamp	

