### **ABBREVIATIONS**

ACT ACOUSTICAL CEILING TILE A.F.F. ABOVE FINISHED FLOOR APPROX. **APPROXIMATE** ARCH. **ARCHITECTURAL** 

**BLOCKING** BLKG. **BUILDING** BLDG. **BOTTOM OF** B.O. C.H. **CEILING HEIGHT** C.J. **CONTROL JOINT** CENTERLINE CL

CLR. CLEAR

COL.

CMU **CONCRETE MASONRY UNIT** COLUMN

**CONTINUOUS** CONT. DOWN DN DIMENSION DIM. DIAMETER DIA. DWG. **DRAWING EXISTING** (E) ÈĹ. **ELEVATION ELECTRICAL** ELEC. **EQUAL** EQ

**FLOOR DRAIN** FD. F.O. FACE OF

F.O.C. **FACE OF CONCRETE** FACE OF FINISH F.O.F. F.O.S. FACE OF STUD

**GFIC GROUND FAULT INTERCEPTOR CIRCUIT** 

GWB GYPSUM WALL BOARD

HEATING, VENTILATION & AIR CONDITIONING H or HVAC HOSE BIB

H.B. **MAXIMUM** MAX. MIN. MINIMUM MECH. MECHANICAL

MECHANICAL ELECTRICAL PLUMBING MEP

M.O. MASONRY OPENING

**METAL** MTL.

**NOT IN CONTRACT** N.I.C. .T.S. NOT TO SCALE O.C. ON CENTER

O.D. **OUTSIDE DIAMETER** 

 $\Omega$ / **OVER OPPOSITE** OPP. P.G. **PAINT GRADE** PTD. **PAINTED ROOF DRAIN** R.D. REQ'D. REQUIRED **ROUGH OPENING** 

R.O. STAIN GRADE S.G. SIM. SIMILAR SQ. SQUARE SPEC. **SPECIFICATION** 

STAINLESS STEEL SSTL. STEEL STL.

SYM.

SYMMETRICAL T.O. TOP OF

T&G TONGUE AND GROOVE

**TYPICAL** TYP.

U.O.N

**UNLESS OTHERWISE NOTED** VCT VINYL CEILING TILE VERIFY IN FIELD V.I.F. W/O

WITHOUT WITH W/ WOOD WD.

WPM. WATERPROOFING MEMBRANE


### **Symbol Legend**



### **BUILDING SECTION**

Reference Number **Drawing Sheet** 

### **DETAIL**

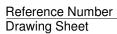



A101

A101

### **DETAIL**

Reference Number **Drawing Sheet** 



### INTERIOR ELEVATION

Reference Number **Drawing Sheet** 



### **EXTERIOR ELEVATION**

Reference Number **Drawing Sheet** 



### **ELEVATION**



**WINDOW TAG** 



**DOOR TAG** 



**WALL TAG** 



**REVISION TAG** 



### **CENTERLINE**

### **General Requirements**

- 1. All work shall be in compliance with all applicable local building codes and regulations. Contractors shall be responsible for permits applicable to specific trades or subcontractors.
- 2. Contractor shall examine the premises and site so as to compare them to the contract drawings and will be familiar with the existing conditions of the building prior to submission of bid number. Allowances are to be made to include items of work including both labor or materials for all noted, details or implied items required to attain the completed conditions proposed in the drawings and specifications.
- 3. Contractor shall coordinate the work of all trades and subcontractors and shall be responsible for any acts, omissions, or errors of the subcontractors and/or person directly or indirectly employed by them.
- 4. Contractor shall assume the sole responsibility for job site conditions including the safety of persons and property for the duration of the project.
- 5. Contractor shall conform to all neighborhood association rule and guidelines.
- 6. All construction materials and supplies are to be stored, handled and installed according to manufacturers'
- 7. If errors or omissions are found in the contract documents, they should be brought to the attention of the architect before proceeding with the work.
- 8. Drawings schematically indicate new construction. The contractor shall anticipate, based on experience, a reasonable number of adjustments to be necessary to meet the design objectives and should consider such adjustments as included in the scope of work.
- 9 When specific features of construction are not fully shown on the drawings or called for in the general notes, their construction shall be of the same character as similar conditions.
- 10. All dimensions are to be taken from numeric designations only; dimensions are not to be scaled off of the drawings.

DESIGN IS BASED ON THE INTERNATIONAL BUILDING CODE (IBC) 2015 AND THE MASSACHUSETTS BUILDING CODE 2015 AMENDMENTS. CONSTRUCTION SHALL CONFORM WITH ALL APPLICABLE SECTIONS.

NO CHANGE

### **Project Summary**

Depth (Feet)

(Percent)

Rear Yard Maximum


Occupancy by Accessory Buildings

ADDRESS: NEIGHBORHOOD DISTRICT: ZONING DISTRICT: EXISTING USE: PROPOSED USE:

51 GRAY STREET, BOSTON SOUTH END NEIGHBORHOOD SINGLE FAMILY RESIDENTIAL SINGLE FAMILY RESIDENTIAL

LOT AREA:	720 SF	
Item	Required	Proposed
Lot Area, Minimum for Dwell. Unit(s) Specified (Sq.Ft.)	NONE	NO CHANGE
Additional Lot Area For Each Addit'l Dwell. Unit (Sq. Ft.)	NONE	NO CHANGE
Lot Width Minimum (Feet)	NONE	NO CHANGE
Lot Frontage Minimum (Feet)	NONE	NO CHANGE
Floor Area Ratio Maximum	2.0	NO CHANGE
Building Height Maximum	70'	NO CHANGE
Usable Open Space Minimum Sq. Ft. Per Dwelling Unit (a)	200 sq.ft.	NO CHANGE
Front Yard Minimum Depth (Feet)	Conformity with existing building alignment	NO CHANGE
Side Yard Minimum Width (Feet)	NONE	NO CHANGE
Rear Yard Minimum	20'	NO CHANGE

	Sheet List
Sheet Number	Sheet Name
G0.01	Cover
G0.02	Structural Notes
V1.01	Plot Plan
V1.02	Proposed - Plot Plan
A1.00	Demolition Plans
A1.01	Site Plan
A1.02	Level 3 and Roof Deck Plan
A1.04	Roof Deck Framing Plan
A3.01	Building Section
A4.01	Details I
A4.02	Details II
A4.03	Details III

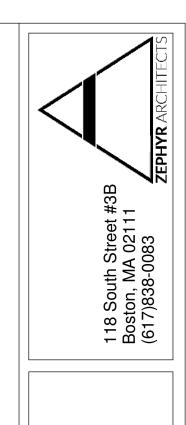

51 Gray Street Boston, MA Roof Deck

G0.01 Cover

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### **General Structural Notes**

### 1.1 Elevations & Dimensions

A. All dimensions, elevations and conditions shall be verified in the field by the contractors and any discrepancies shall be brought to the attention of the Engineer for clarification before proceeding with the affected part of the work. Dimensions and elevations noted in the contract documents as (+/-) and all field conditions shall be verified in the field by the contractor prior to submissions of shop drawings

### 1.2 Building Code and Reference Standard

- A. Massachusetts State Building Code 780 CMR Ninth Edition
- B. International Building Code 2015 w/ Mass. Amendments
- C. ASCE/SEI 7-05, Minimum Design Loads for Buildings and Structures

### 1.3 Design Loads

- A. Dead Loads: All permanent Stationary Construction.
- B. Floor Live Load (uniform)

1. Residential	40 ps
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2. Roof Snow Load Parameters: Where appropriate drifting snow loads have been considered in accordance with Section 7.7 of ASCE/SEI 7-05.

a) Ground Snow Load, Pg	45 psf
b)Flat Roof Snow Load, Pf	30 psf

C. Wind Load Parameters

Basic Wind Speed (3 Sec Gust)	V=105 mph
2. Wind Importance Factor, I	1.0
3 Exposure	В

### **Wood Framing**

### 2.1 Sawn Lumber

- A. All lumber to be Spruce-Pine-Fir (NLGA) #2 or better and Kiln Dried.
- B. All lumber noted as PT to be Pressure Treated
- C. All PT Lumber must be redried after treatment to a maximum moisture content of 19% and bear a stamp indicating KDAT or ADAT.

### 2.2 Laminated Veneer Lumber - LVL

- A. LVL shall be approved equal or better grade as follows:
  - 1. Doulgas fir or southern pine veneers
  - 2.  $E \ge 2,000,000 \text{ psi}$
  - 3. Fb >= 2,600 psi
  - 4. Fv >= 285 psi
- B. Only LVL products with the above minimum properties will be approved. Do not use LVL products that have been stored outdoors prior to delivery to the job site. LVL must be stored flat and level off the ground, covered and protected from weather.

### 2.3 Parallel Strand Lumber - PSL

- A. PSL Shall be approved equal or better grade as follows:
  - 1. E >= 1,800,000 psi
  - 2. Fcll >= 2,500 psi
- B. Only PSL products with the above minimum properties will be approved. Do not use PSL products that have been stored outdoors prior to delivery to the job site. PSL must be stored flat and level off the ground, covered and protected from weather.

### 2.4 Veneer Plywood

A. Roof Sheathing: 3/4" APA rated Sturd-I-Floor Sheathing, Exposure 1.

### 2.5 Fasteners


- A. Nails Common Wire, hot-dipped galvanized per ASTM A153
- B. Bolts: ASTM A307
- C. Self Driving Screws: SDS Wood Screws by Simpson Strong tie or approved equal .
- D. Connectors: Simpson Strong-toe pr approved equal. Provide nailing specified by manufacturer to achieve full capacity of all connections and hangers.E. Construction Adhesive: Conform to APA AFG-01

### 2.6 Framing Notes

- A. Comply with all the relevant prescriptive requirements of 780 CMR 9th edition of the Massachusetts State Building Code (UON) and the International Building Code.
- B. Lag Screw Installation: Drill clearance holes for lag screws to depth equal to length of unthreaded shank. Lead holes for threaded portion shall be 60% the diameter of the unthreaded shank (clearance hole). Always drill clearance hole to proper depth before drilling lead hole. Turn lag screws in place; do not drive with a hammer.
- $\mbox{C.}$  Set carpentry to required levels and lines, with members plumb , true to line, cut and fitted.
- D. Produce joints which are tight, square and true with members assembled in accordance with the drawings.
- E. Do not use defective or damaged materials, such as cracked, split, warped, kinked, twisted, gouged or dented framing. Do not use bent, cracked or rusted connectors or fasteners.
  - F. Install horizontally-oriented members with high side "crown" up.
- G. Clearance holes for bolts shall be a maximum of 1/16" greater than bolt diameter.
- H. Fasten roof sheathing to framing with 10d nails @ 4 in. OC at edges and 16 in OC in field.

### 2.7 Standard Spec

A. AF&PA NDS-05 Nation Design Specification for Wood Construction with 2005 Supplement.

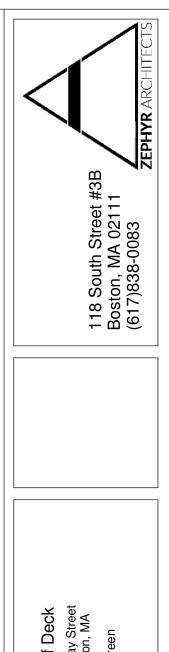

Roof Deck 51 Gray Street Boston, MA Breen


G0.02 Structural Notes

2019 1.22.59 DM

# INSPECTION MORTGAGE





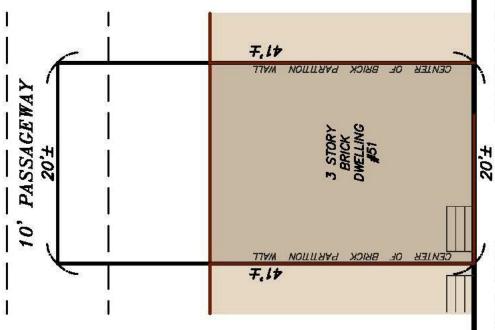

MORTGAGE INSPECTION OF PROPERTY

STREET

GRAY

In Boston, Suffolk County, Massachusetts Prepared for: Guaranteed Rate, Inc. Owned by: Jeffrey Kahan Scale: 1" = 10' Date: 03-11-17 Book No. 22850 Page No. 47 Land Court Cert. No. (Not Applicable)

shown on this plan is (are on the ground as shown of my knowledge and bell dimensional Zoning Law Boston at the time be exempt from violation 6 G.L. Chap. 40A, Sec. 7, un

SURVEYING

684, Winchester, MA 01890 phone 781-721-1944

V1.01 Plot Plan

51 Gray Street Boston, MA Roof Deck

Breen


118 South Street #3B Boston, MA 02111 (617)838-0083



## INSPECTION MORTGAGE





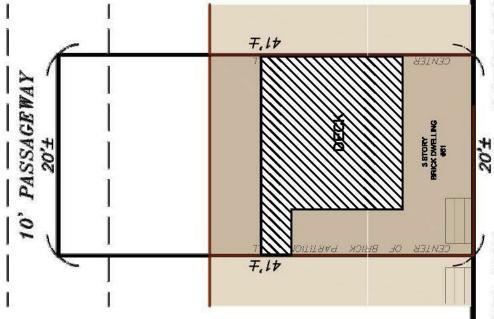

STREET

MORTGAGE INSPECTION OF PROPERTY

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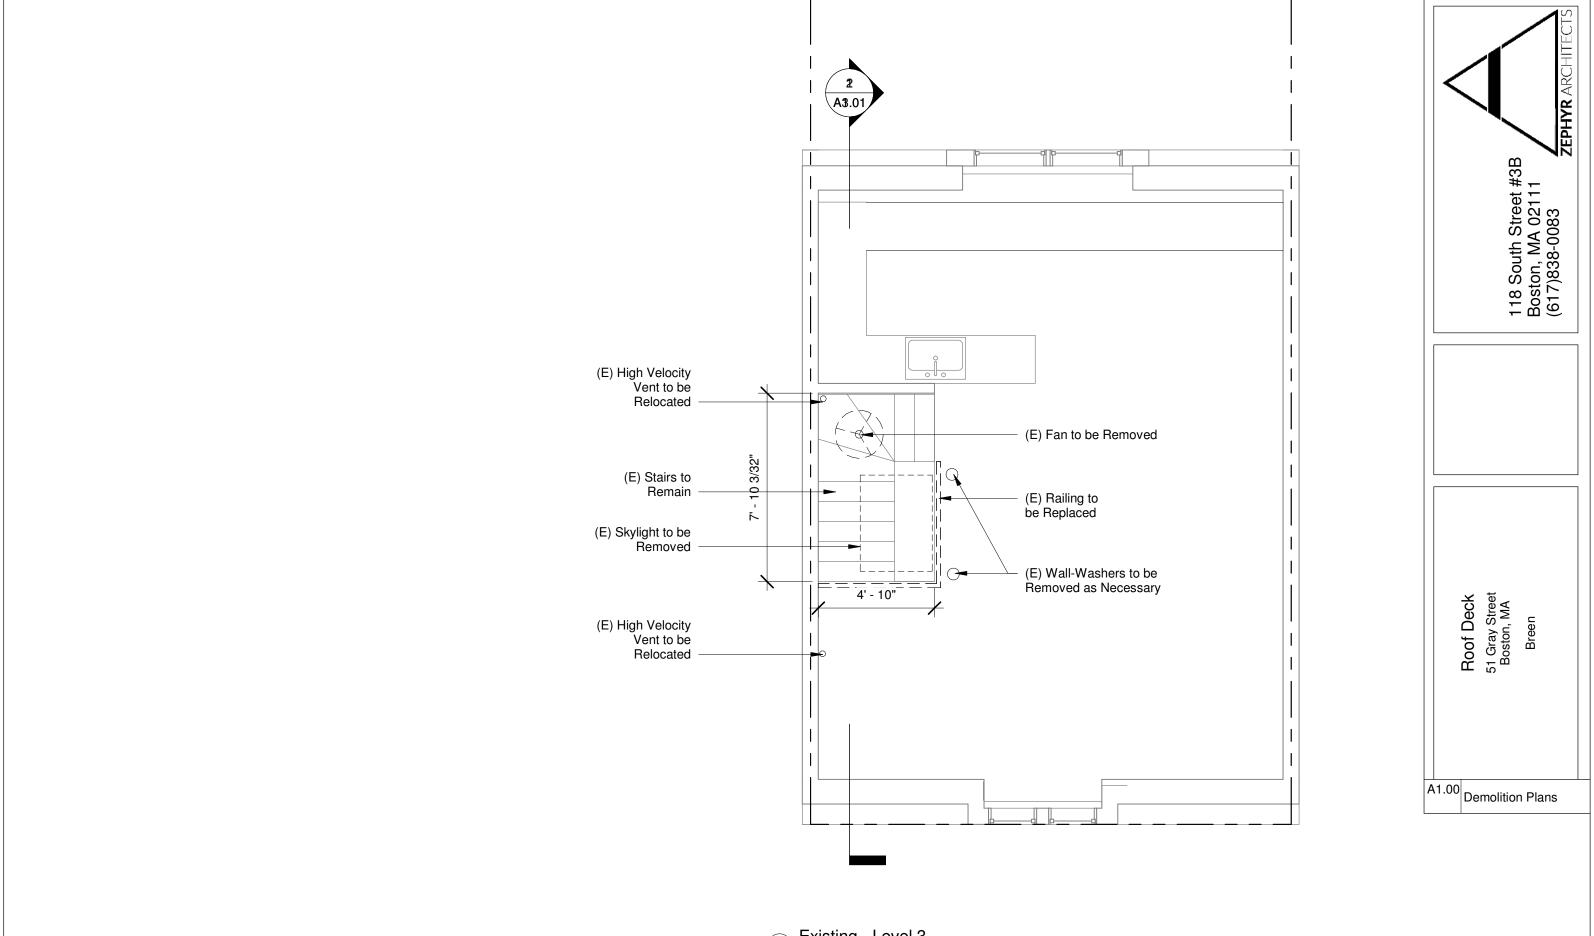
Winchester, MA 01890 SURVEYING 684,


V1.02 Proposed - Plot Plan


Roof Deck


51 Gray Street Boston, MA


ZEPHYR ARCHITI 118 South Street #3B Boston, MA 02111 (617)838-0083




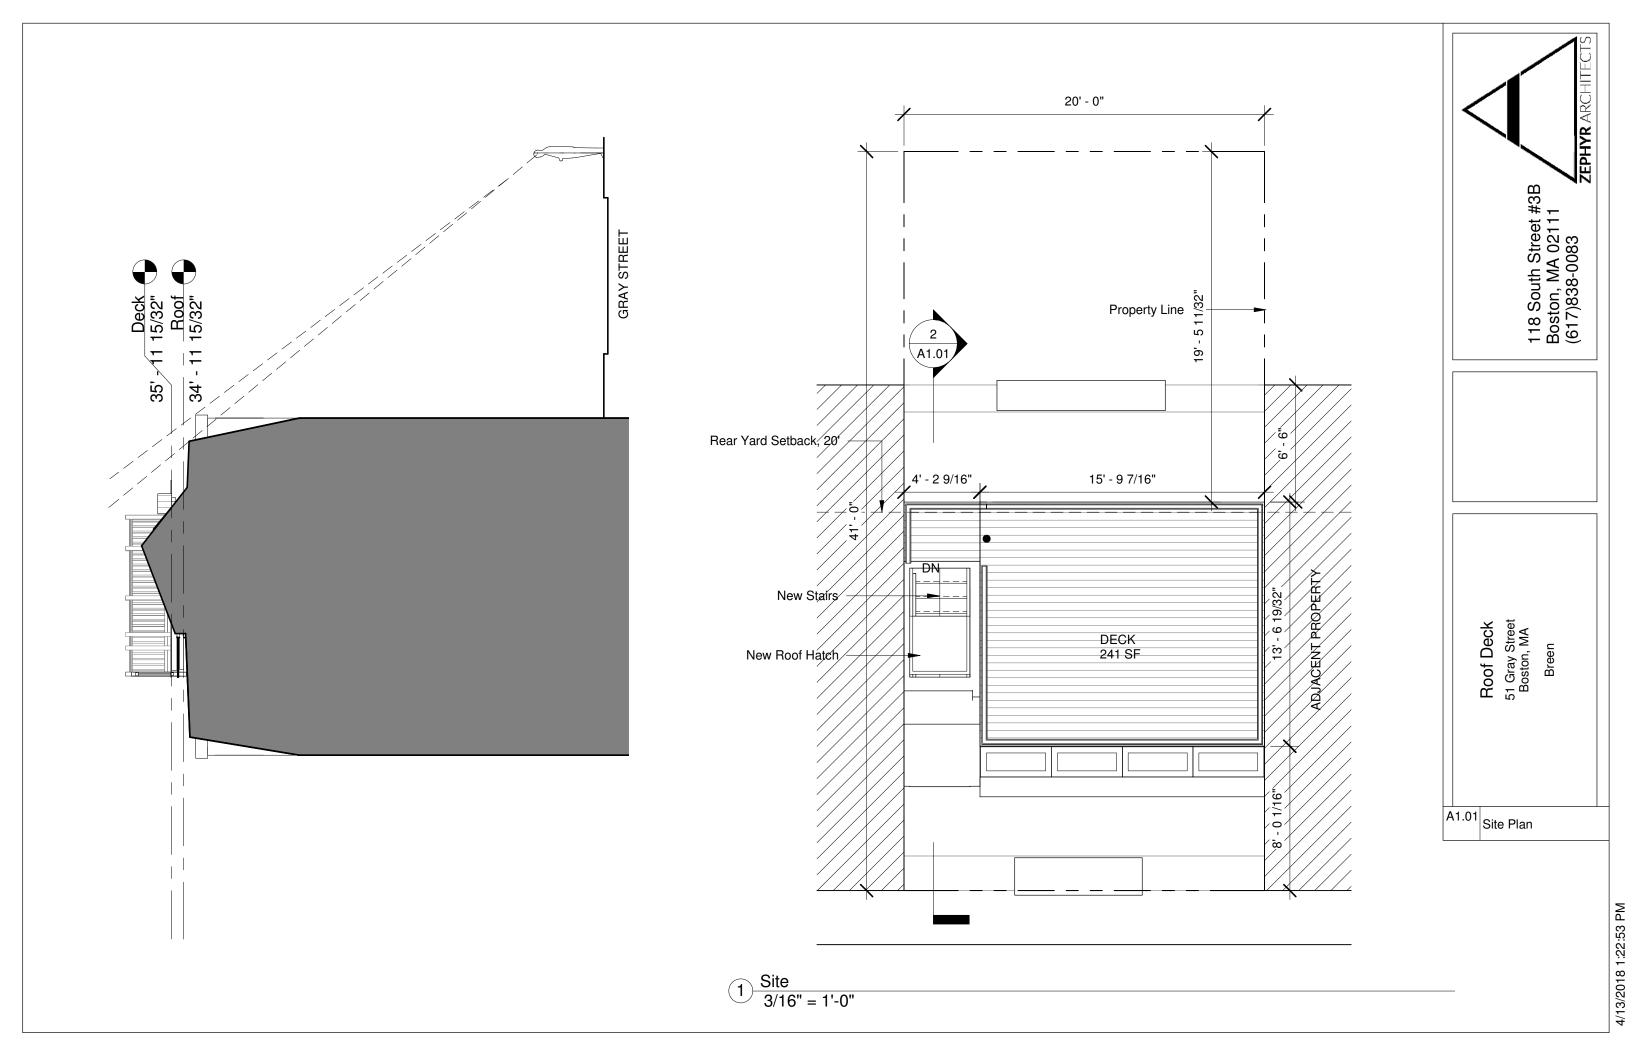

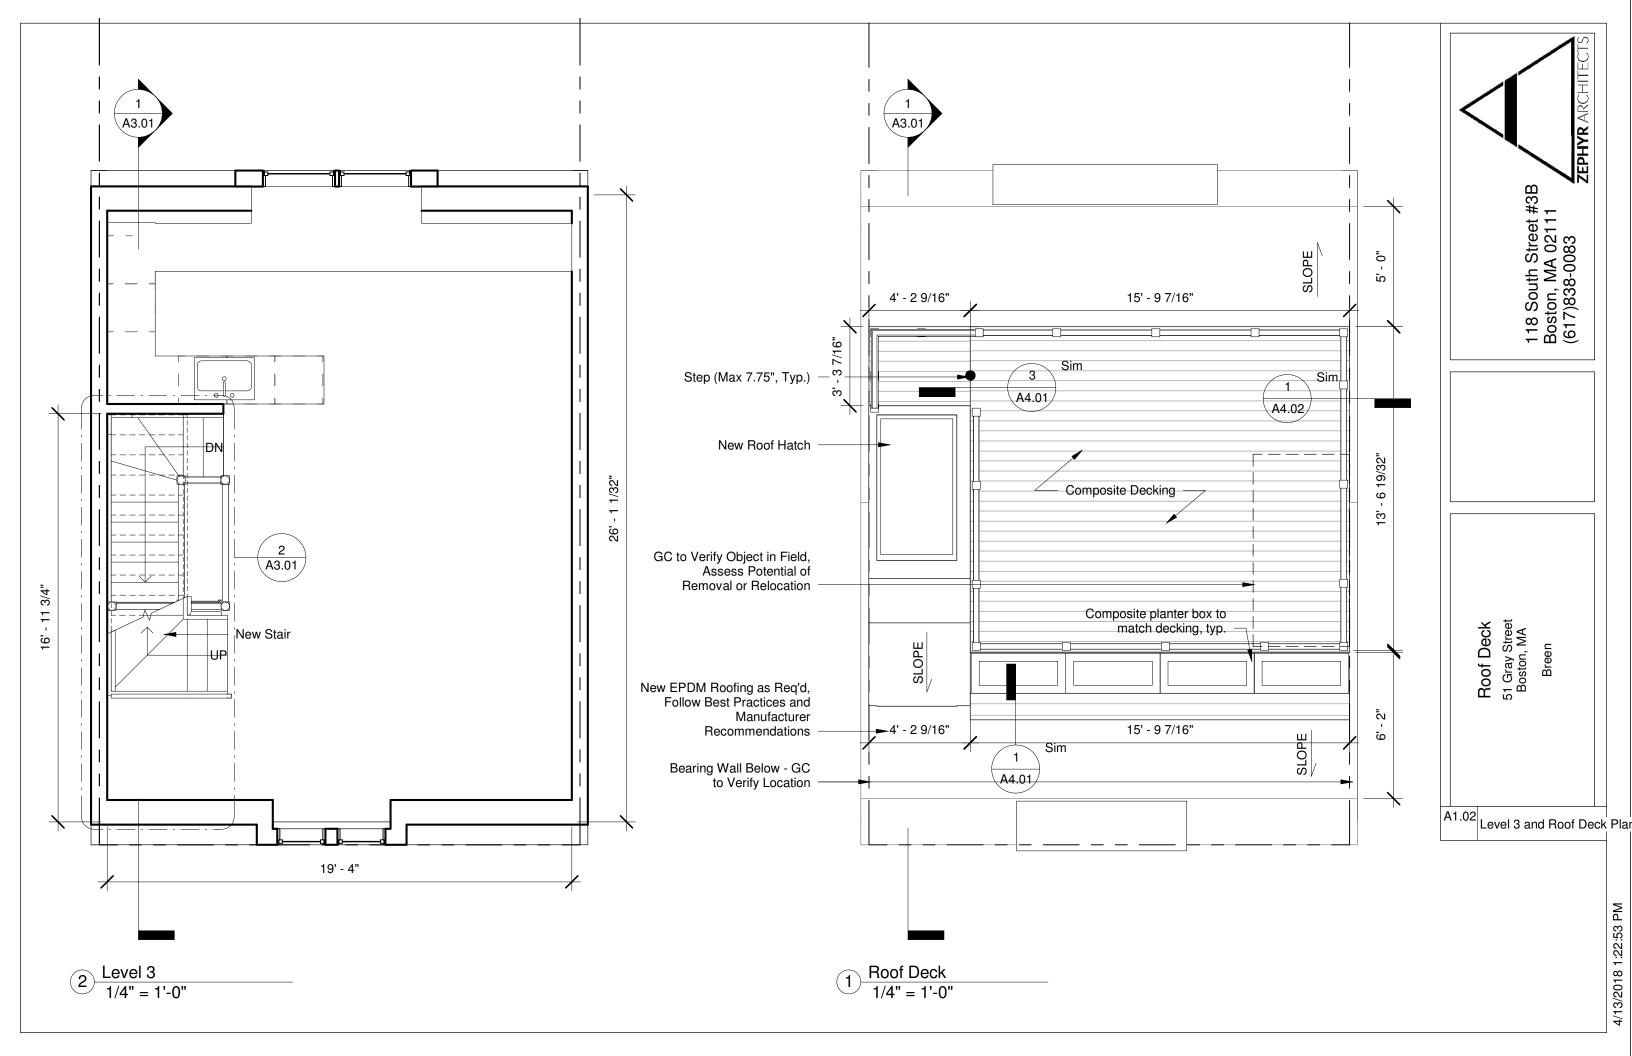


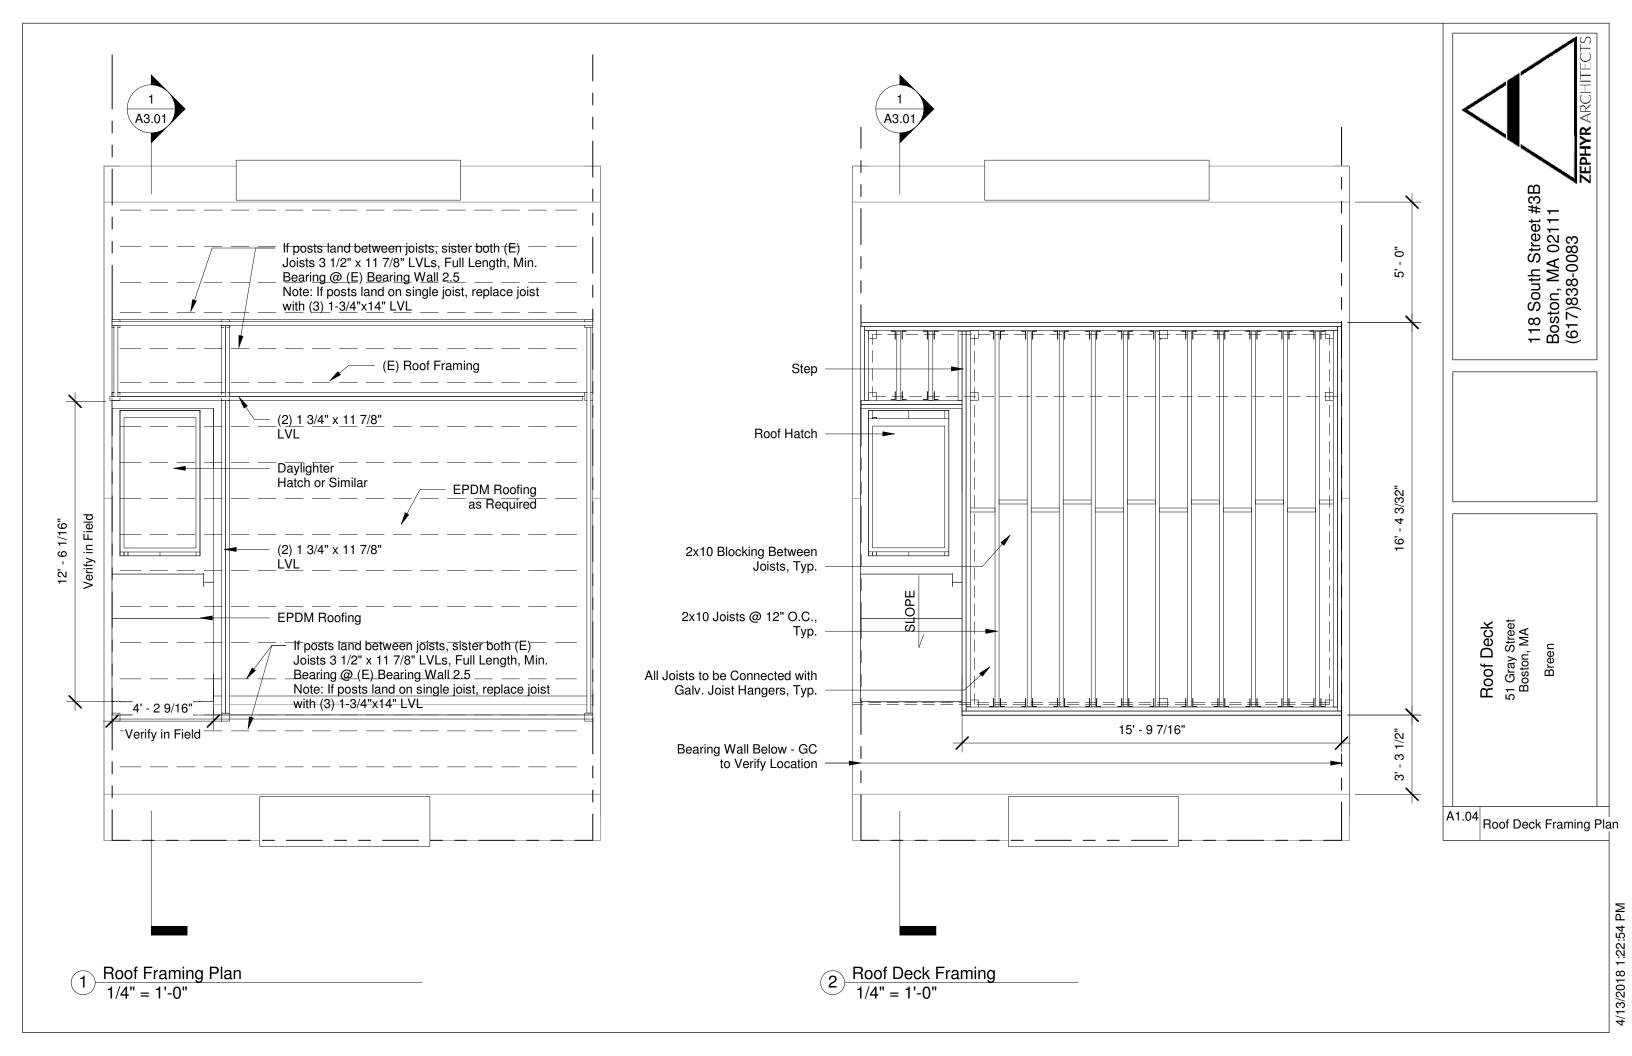

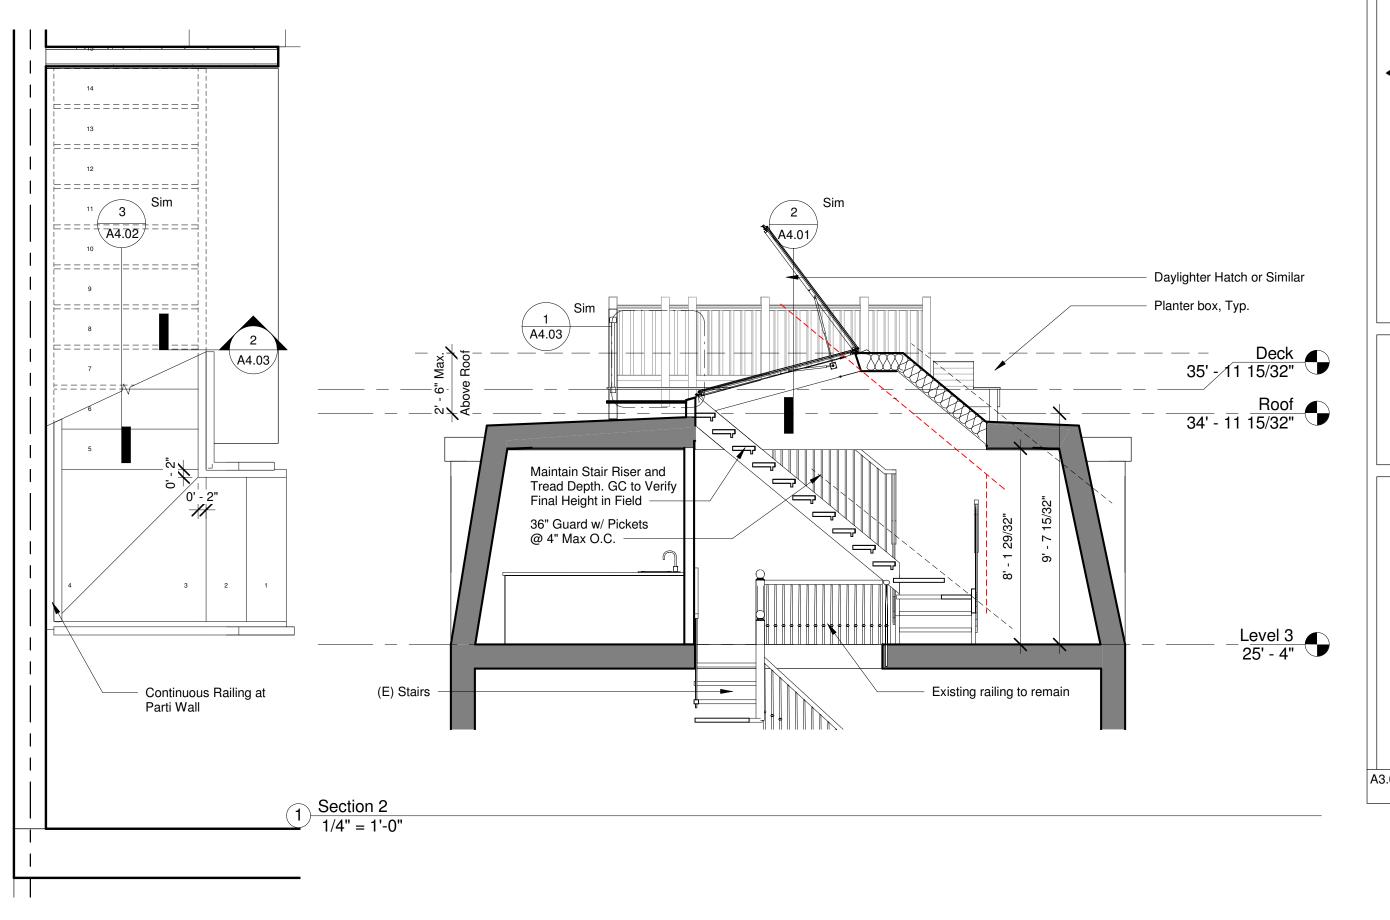


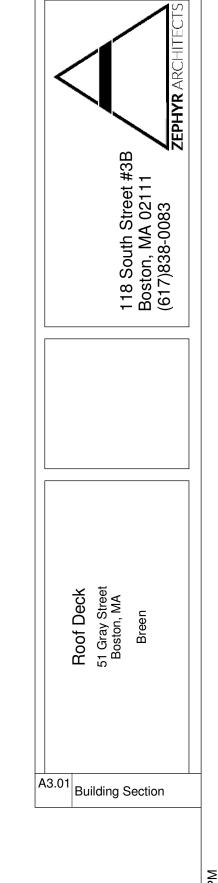

2 Level 3 - Stair 1/2" = 1'-0" 4/13/2018 1:22:55 PM

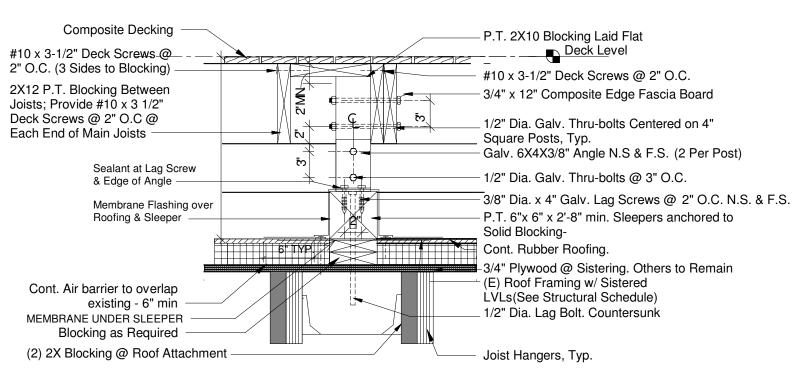


## Section @ Structural Railing Post - Capped

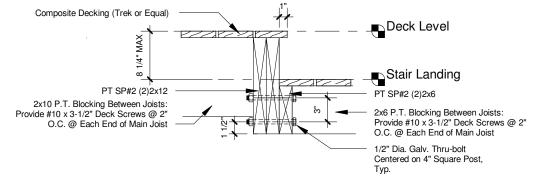


### Section @ Deck to Stair Landing

## Connection 3

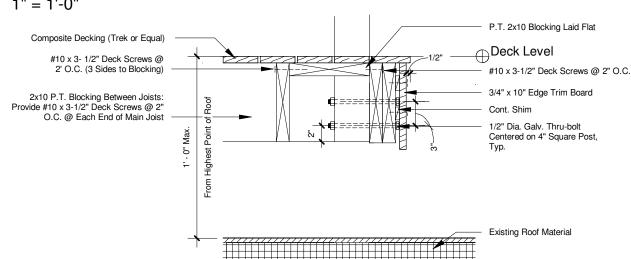


Section @ Non-Structral Railing Post

1" = 1'-0"

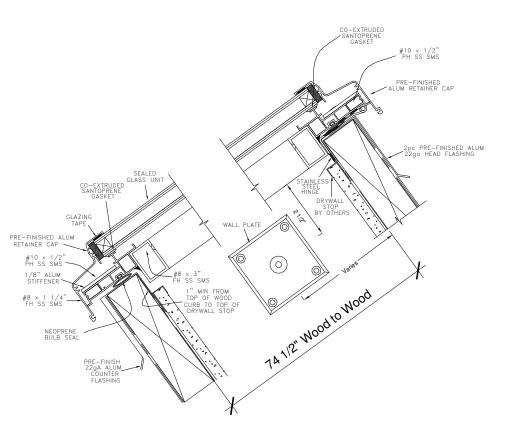

5 Roof Hatch Section @ Head & Sill 3" = 1'-0"

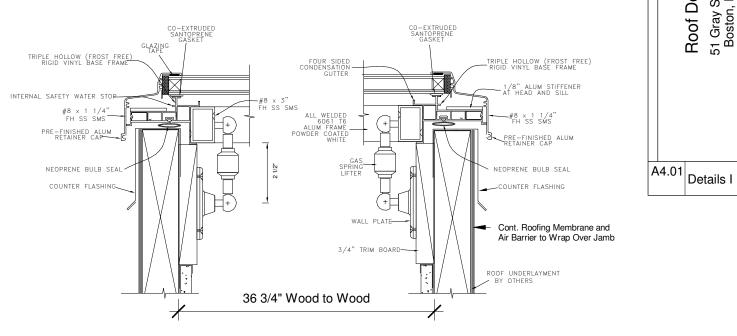


Poof Hatch Section @ Jamb

118 South Street #3B Boston, MA 02111 (617)838-0083 51 Gray Street Boston, MA Roof Deck


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ZEPHYR ARC

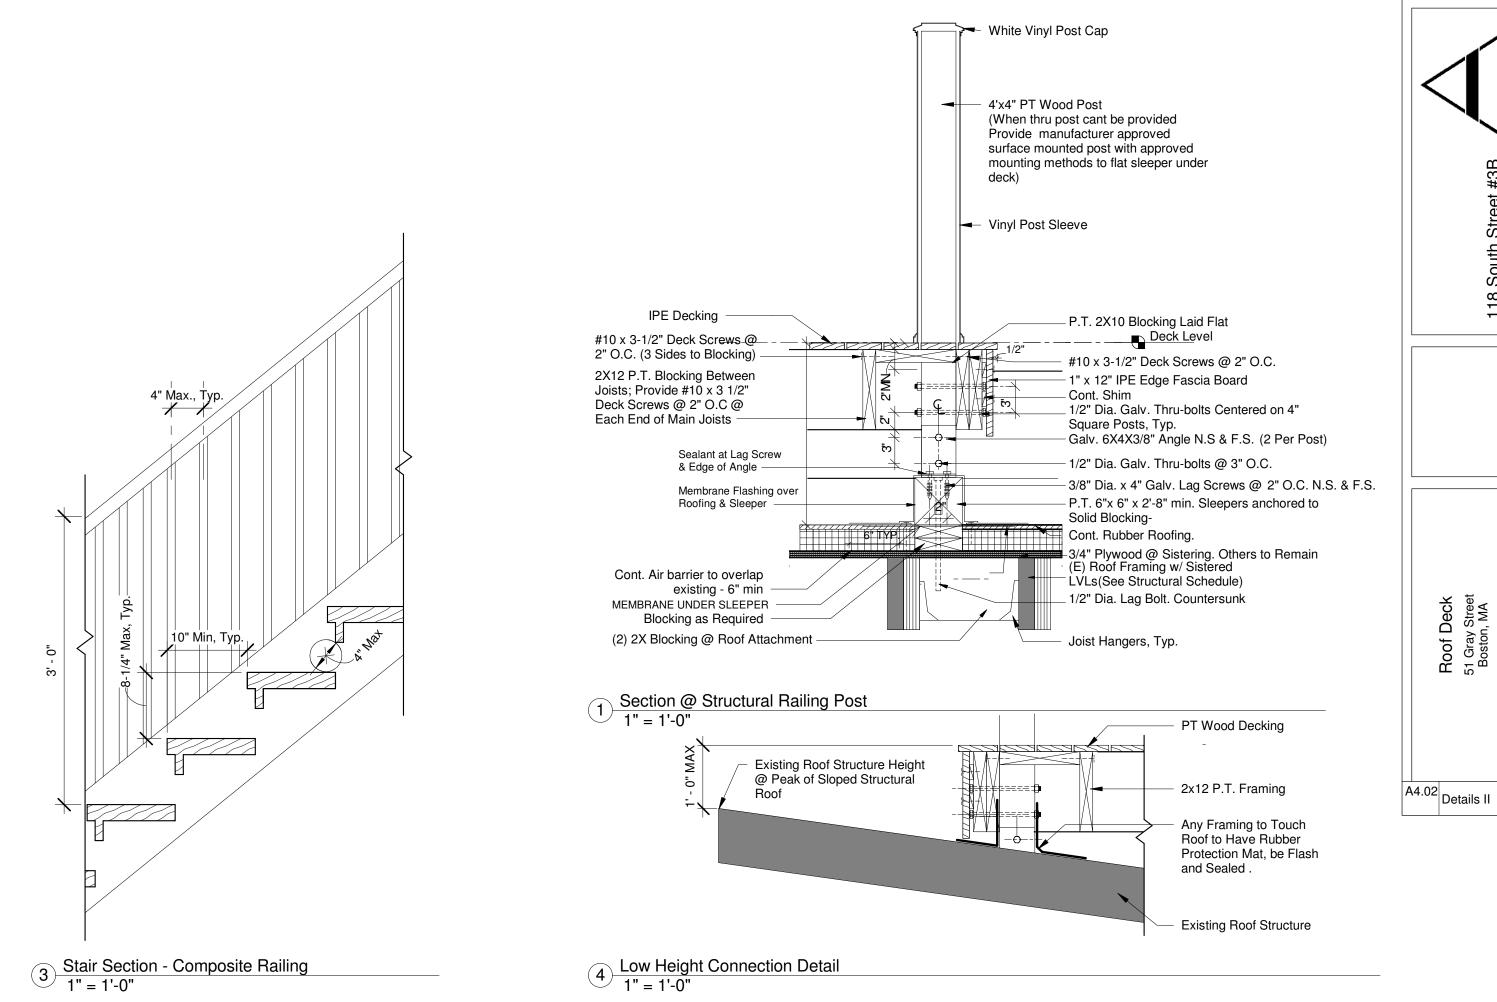


ZEPHYR ARC 118 South Street #3B Boston, MA 02111 (617)838-0083 51 Gray Street Boston, MA Roof Deck


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Railing Elevation - Composite

1" = 1'-0"

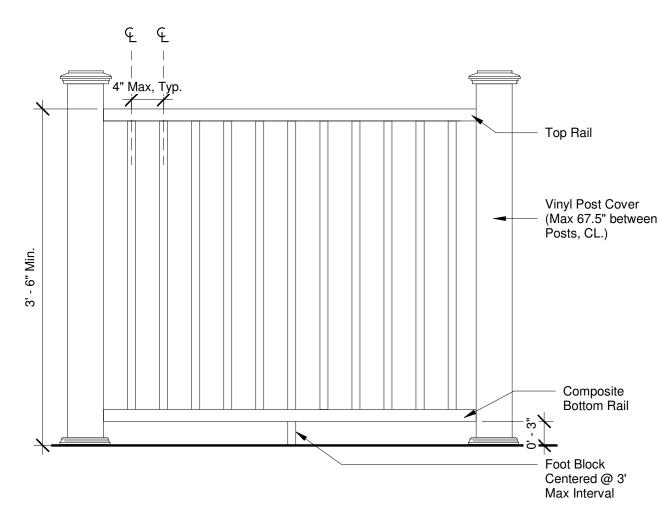

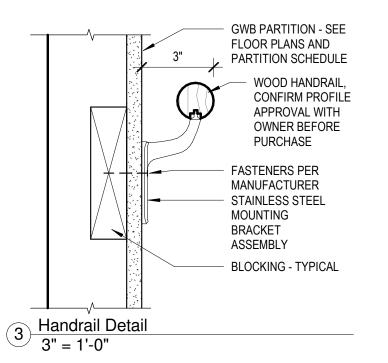


ZEPHYR ARC 118 South Street #3B Boston, MA 02111 (617)838-0083 Roof Deck 51 Gray Street Boston, MA

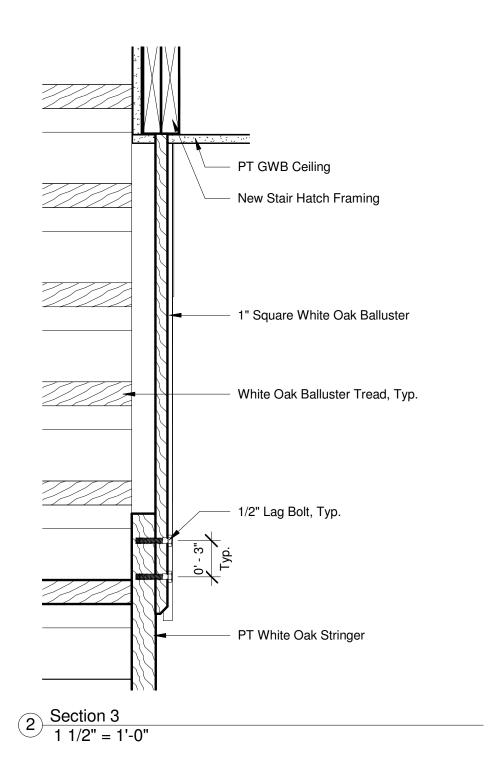A4.03 Details III

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# 51 Gray Street Layout Concept



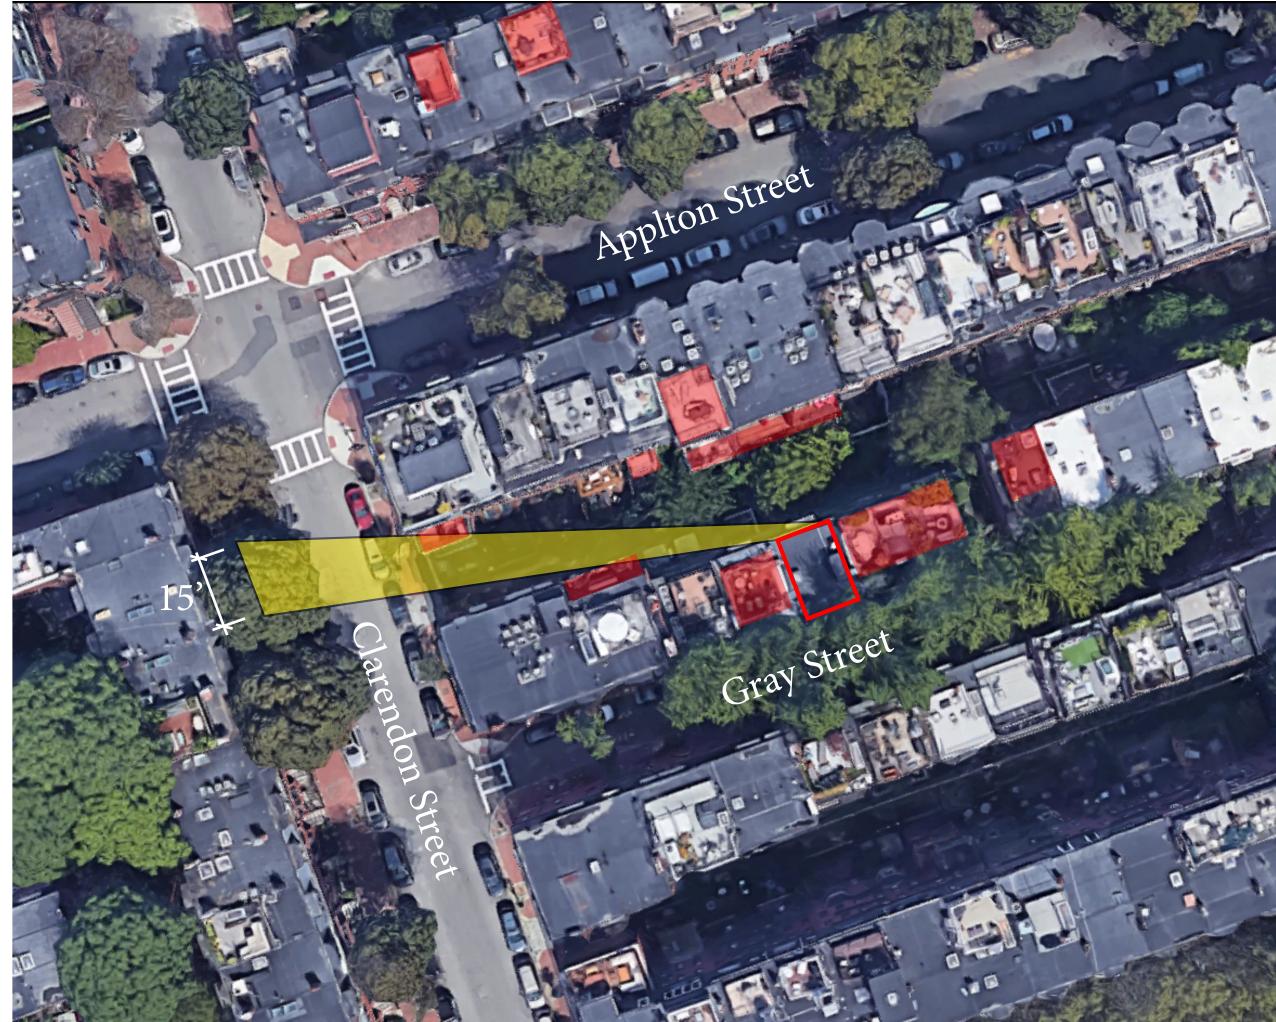

51 Gray Street

Visible Decks through private alley



Gray Street
Layout Concept

