South End Landmark District Commission 3 BOND STREET





DRAWING LIST			
G000	COVER SHEET		
A000	SITE PLAN		
A001	EXISTING & PROPOSED - VIOLATION RECTIFICATION		
A002	EXISTING CONDITIONS & PRECEDENT IMAGERY		
-	BWSC-APPROVED GROUNDWATER RECHARGE SYSTEM DOCUMENTATION		

Violation: Addressing the groundwater recharge system downspout & overflow penetrations at the front facade.



58 WINTER STREET BOSTON, MA 617.542.1080

JULY 22, 2021

3 BOND STREET BOSTON, MA

STAME

DRAWING NAM


COVER SHEET

SCALE

N/A

SHEET NUMBER:

G000

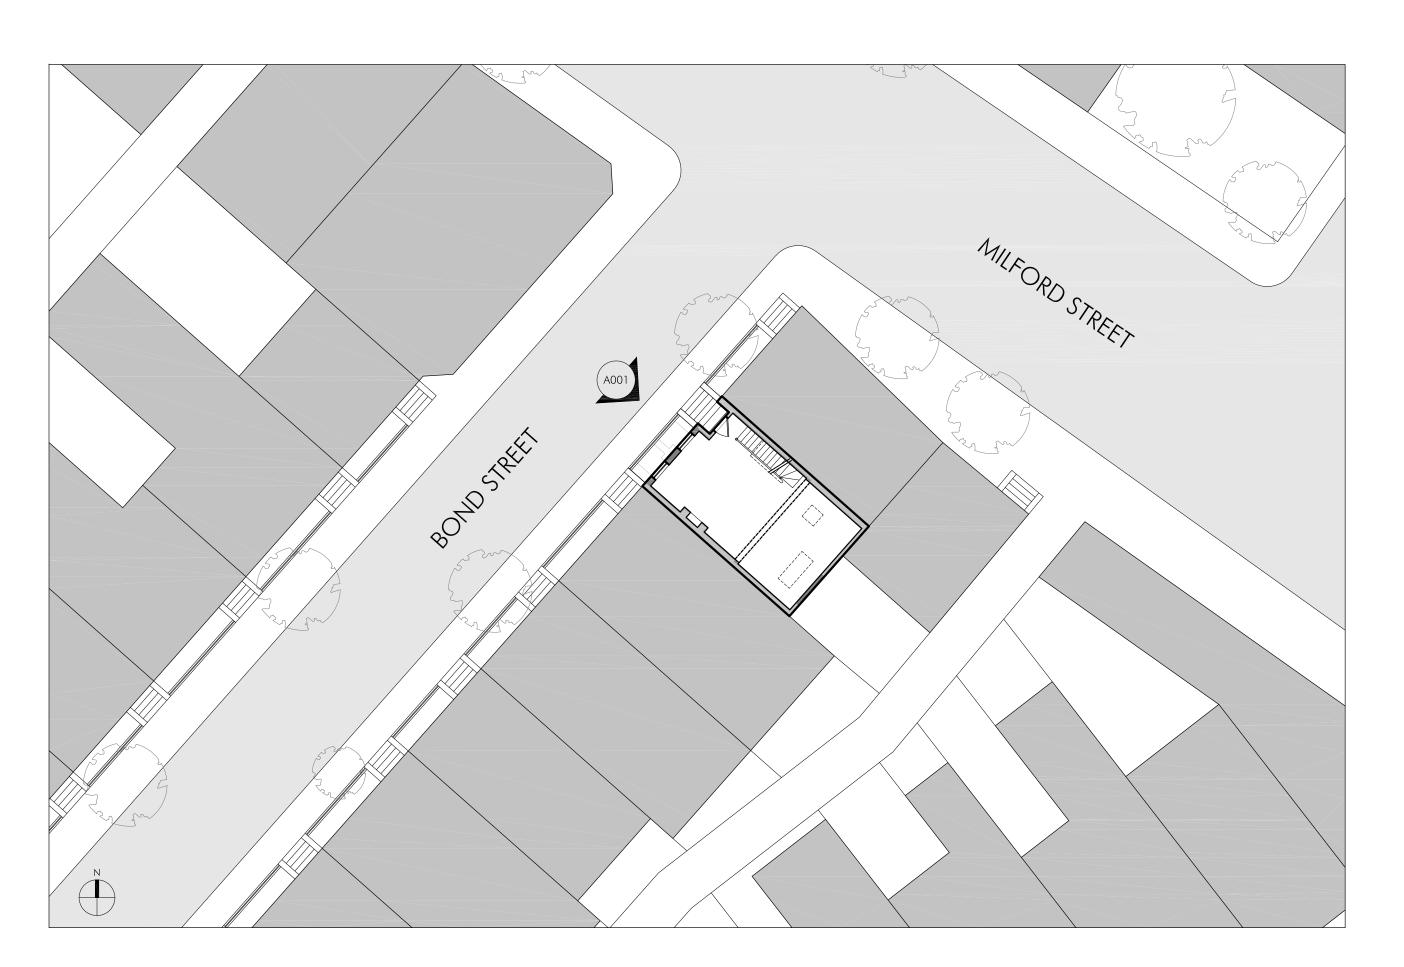



58 WINTER STREET BOSTON, MA $6\,1\,7$. $5\,4\,2$. $1\,0\,8\,0$

JULY 22, 2021

3 BOND STREET BOSTON, MA

STAA

DRAWING NAME:

SITE PLAN


SCALE

1/16" = 1'-0"


SHEET NUMBER:

A000

NOTE: REFER TO A002 FOR "EXISTING CONDITIONS IMAGERY"

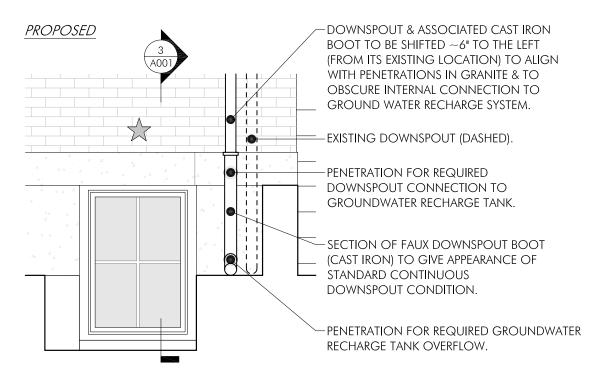

2 ENLARGED FRONT ELEVATION AT WINDOW WELL / DOWNSPOUT & OVERFLOW SCALE: 3/8" = 1'-0"

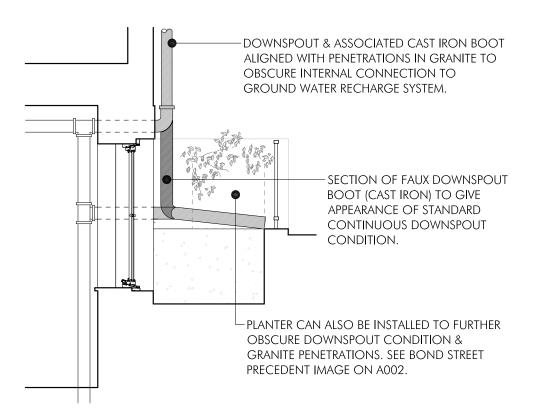

SECTION / SIDE ELEVATION AT WINDOW WELL / DOWNSPOUT & OVERFLOW SCALE: 3/8" = 1'-0"



58 WINTER STREET BOSTON, MA $6\,1\,7\,.\,5\,4\,2\,.\,1\,0\,8\,0$

JULY 22, 2021

3 BOND STREET
BOSTON, MA

STAA

DRAWING NAME:

EXISTING & PROPOSED VIOLATION RECTIFICATION

SCALE:

AS INDICATED

SHEET NUMBER:

A001



1)-

EXISTING EXTERIOR ELEVATION - FRONT

SCALE: 3/16" = 1'-0"

58 WINTER STREET BOSTON, MA $6\,1\,7$. $5\,4\,2$. $1\,0\,8\,0$

JULY 22, 2021

A002










3 BOND VIEWED FROM OPPOSITE SIDE OF STREET

VIOLATION AREA - ZOOMED IN

PRECEDENT - (5 BOND) VEGETATION AS VISUAL BUFFER

FITTINGS SIZE VERIFICATION

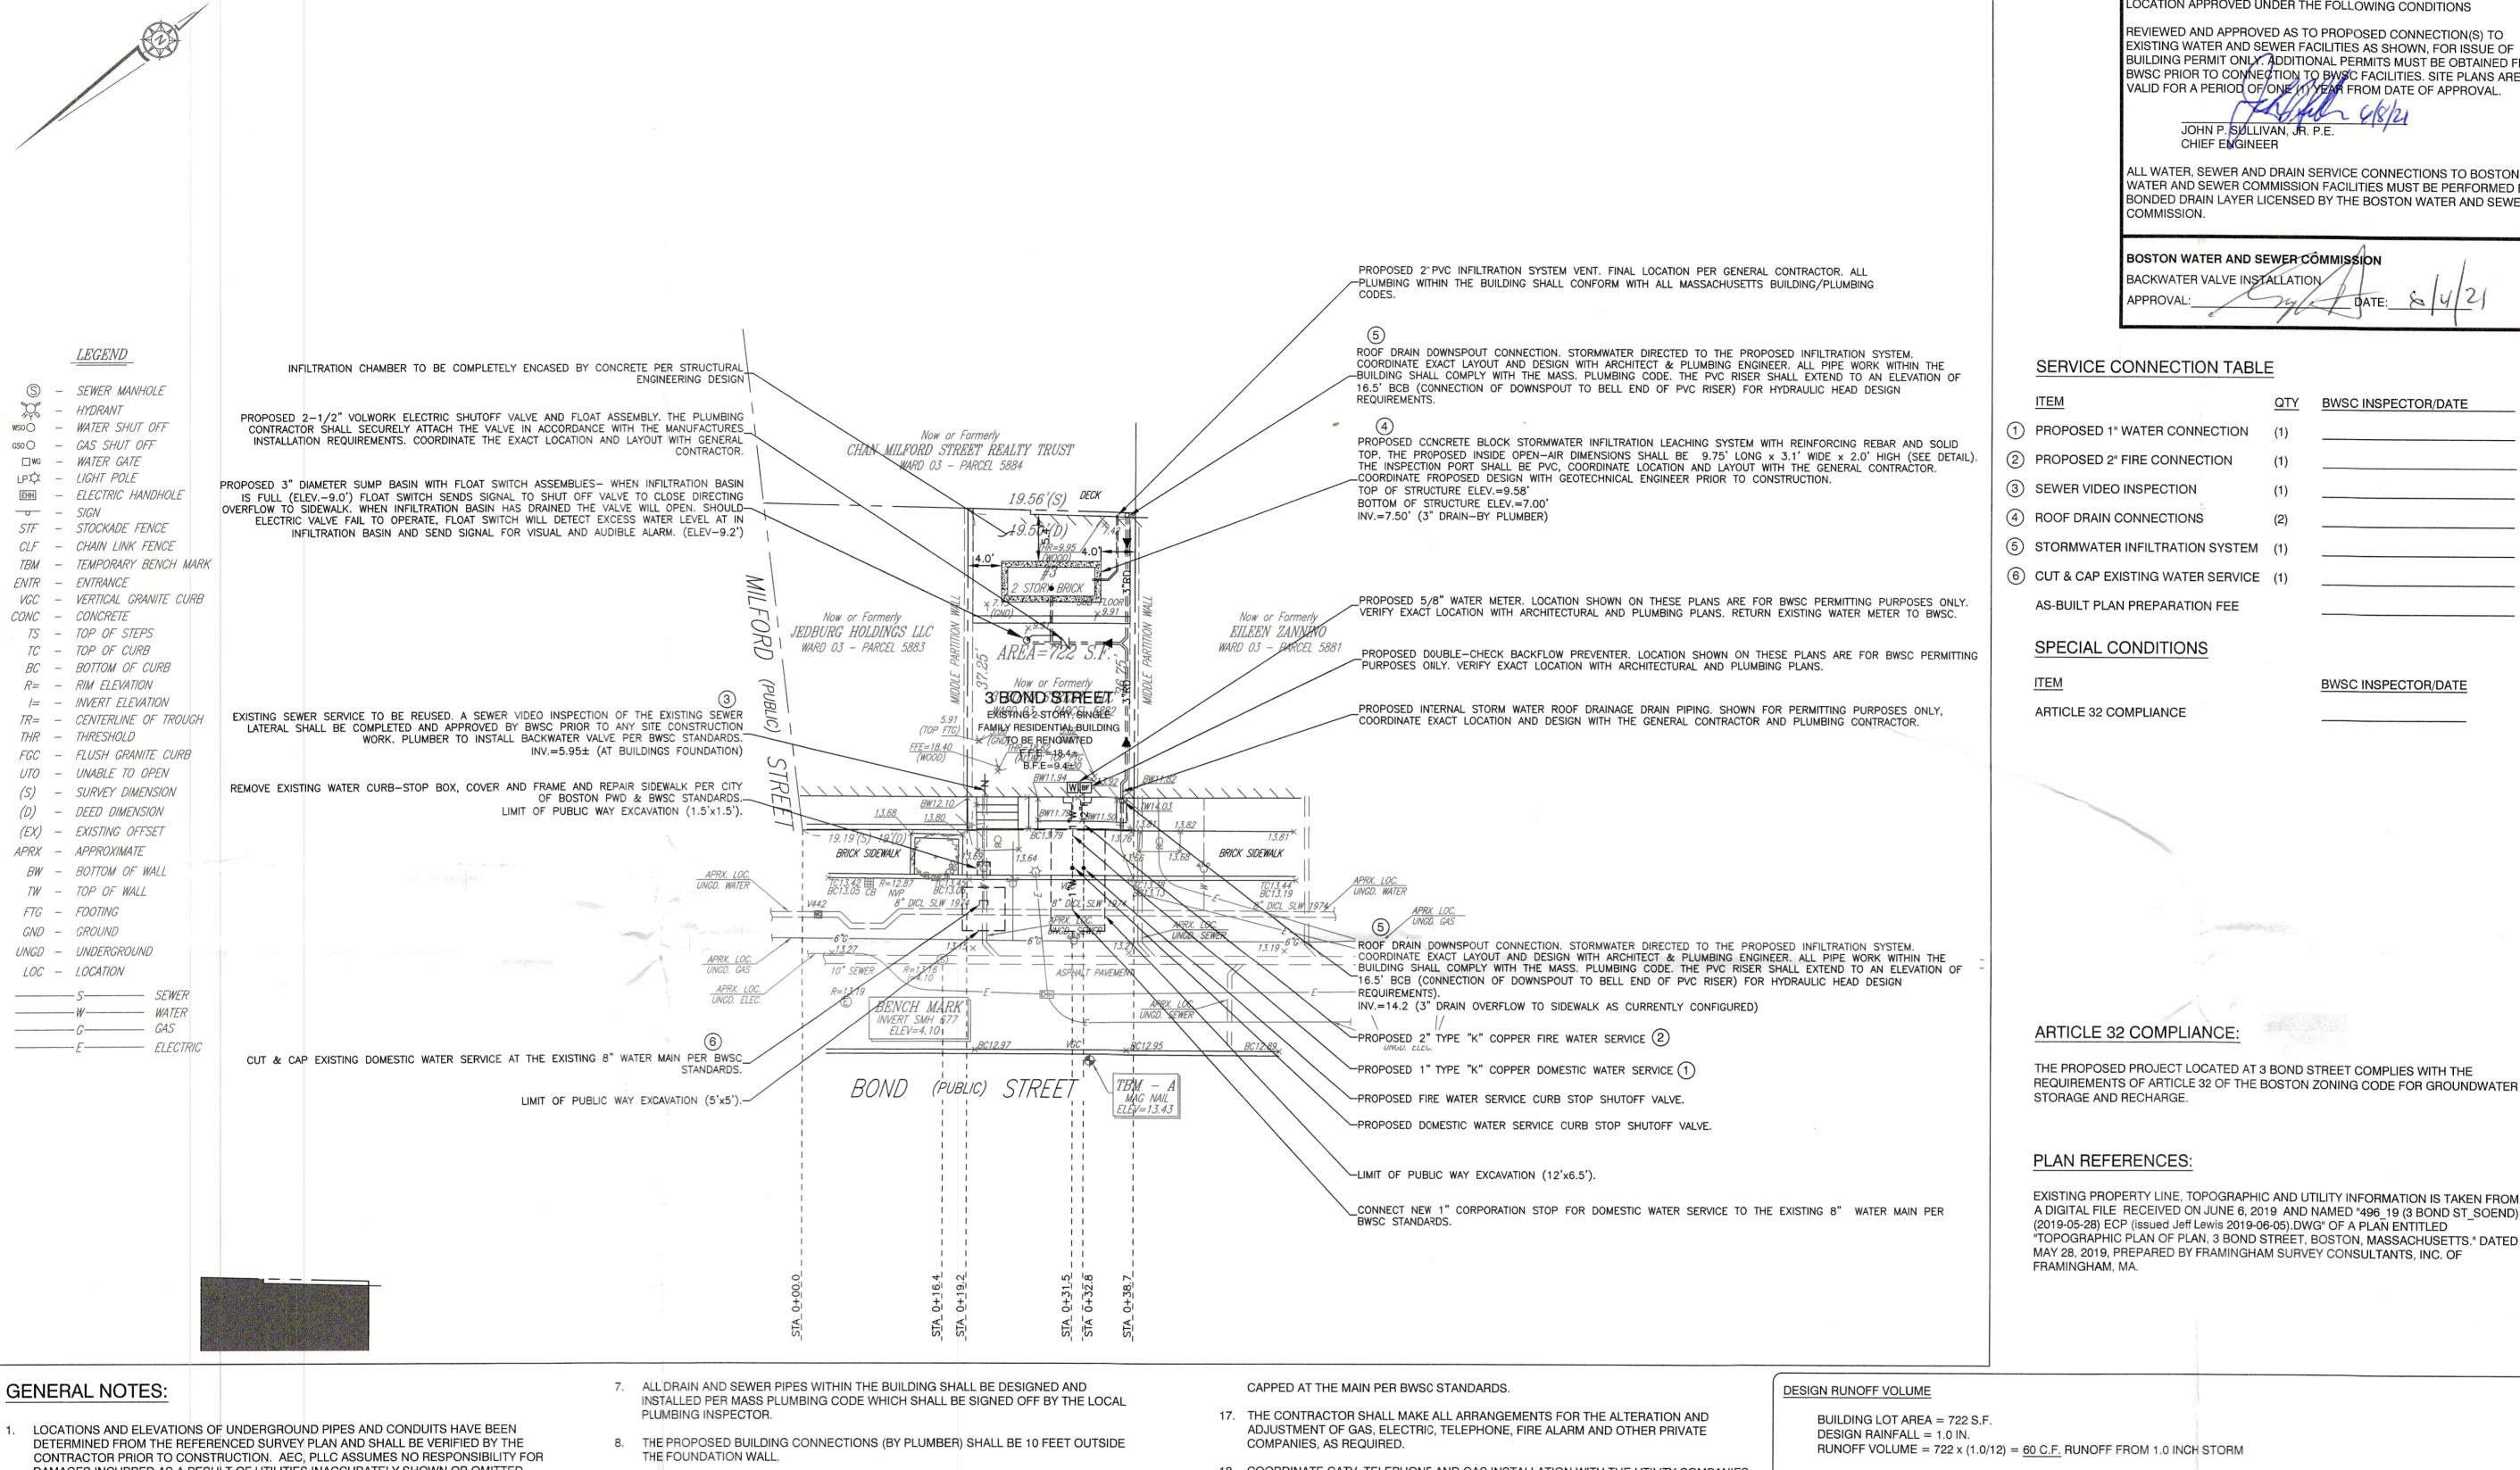

BOSTON WATER AND SEWER COMMISSION LOCATION APPROVED UNDER THE FOLLOWING CONDITIONS

REVIEWED AND APPROVED AS TO PROPOSED CONNECTION(S) TO EXISTING WATER AND SEWER FACILITIES AS SHOWN, FOR ISSUE OF BUILDING PERMIT ONLY. ADDITIONAL PERMITS MUST BE OBTAINED FROM BWSC PRIOR TO CONNECTION TO BWSC FACILITIES. SITE PLANS ARE VALID FOR A PERIOD OF ONE (1) YEAR FROM DATE OF APPROVAL.

CHIEF ENGINEER

ALL WATER, SEWER AND DRAIN SERVICE CONNECTIONS TO BOSTON WATER AND SEWER COMMISSION FACILITIES MUST BE PERFORMED BY A BONDED DRAIN LAYER LICENSED BY THE BOSTON WATER AND SEWER

BOSTON WATER AND SEWER COMMISSION BACKWATER VALVE INSTALLATION

SERVICE CONNECTION TABLE

26

BWSC INSPECTOR/DATE (1) PROPOSED 1" WATER CONNECTION (2) PROPOSED 2" FIRE CONNECTION (3) SEWER VIDEO INSPECTION (4) ROOF DRAIN CONNECTIONS (5) STORMWATER INFILTRATION SYSTEM (6) CUT & CAP EXISTING WATER SERVICE (1) AS-BUILT PLAN PREPARATION FEE

SPECIAL CONDITIONS

OWNER/APPLICANT

3 BOND STREET, LLC. 1 ADAMS STREET LEXINGTON, MA 02420

PROPERTY INFORMATION PARCEL IDS: 0305882000

> LAND-USE CODE R-1 - RESIDENTIAL

WATER METER INFORMATION

EXISTING WATER ACCOUNT NO.: 311709000

PROPOSED WATER METER SIZE: 5/8-INCH* *EXISTING 5/8" WATER METER BE RETURNED TO BWSC

ESTIMATED SEWAGE FLOW

RESIDENTIAL

3 BEDROOMS x 110 GPD/BEDROOM = 330 GPD

TOTAL = 330 GPD

PARCELS: 5882


CONTACT: ALISON RYAN

PROJECT ADDRESS

3 BOND STREET BOSTON, MA 02118-3605

GRAPHIC SCALE IN FEET REVISIONS 12 | 5/23/21 | RAISE INFIL. SYS. / ADD SHUT OFF VALVE INCREASE. INFIL. SYS. VOLUME

10 | 3/31/21 MODIFY INFIL. SYSTEM 9 | 3/12/21 | MODIFY INFIL. SYSTEM/ ADD FIRE SERVICE 8 8/31/20 BWSC PERMIT SET 7 8/12/20 REVISE PER GC'S COMMENTS 6 8/4/20 REVISE PER GC'S COMMENTS 5 | 2/4/20 | FINALIZE DRAINAGE DESIGN REVISIONS 4 | 1/11/20 | MODIFY DRAIN DESIGN PER GC CONVOS REDESIGN STORMWATER CHAMBER 3 |12/29/19| 2 |11/29/19| DRAINAGE DESIGN REVISIONS 6/21/19 GENERAL PLAN REVISIONS

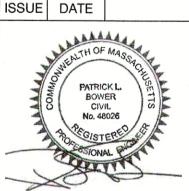

DATE: MAY 22, 2019

SCALE: 1" = 10'

SHEET 1 OF 4

DESCRIPTION

3 BOND STREET

BOSTON (SOUTH END), MASSACHUSETTS

C1.1 - UTILITY SITE PLAN BWSC PLAN #19355

AMOSKEAG ENGINEERING

CONSULTANTS, PLLC

P.O. BOX 563 SANDOWN, NH 03873 tel.: 603.493.2797

PLAN REFERENCES EXISTING PROPERTY LINE, TOPOGRAPHIC AND UTILITY INFORMATION IS TAKEN FROM A DIGITAL FILE RECEIVED ON JUNE 6, 2019 AND NAMED "496 19 (3 BOND ST SOEND) (2019-05-28) ECP (issued Jeff Lewis 2019-06-05). DWG" OF A PLAN ENTITLED "TOPOGRAPHIC PLAN OF PLAN, 3 BOND STREET, BOSTON, MASSACHUSETTS." DATED

- DAMAGES INCURRED AS A RESULT OF UTILITIES INACCURATELY SHOWN OR OMITTED. BEFORE PLANNING FUTURE CONNECTIONS, THE PROPER UTILITY DEPARTMENT SHALL BE NOTIFIED AND THE ACTUAL LOCATIONS OF SUBSURFACE STRUCTURES SHALL BE VERIFIED IN THE FIELD. CALL THE DIG-SAFE CALL CENTER, (888)344-7233, 72 HOURS (3 WORKING DAYS) PRIOR TO ANY EXCAVATION WORK.
- 2. ALL CONSTRUCTION METHODS AND MATERIALS SHALL CONFORM TO BWSC REQUIREMENTS AND ALL OTHER APPLICABLE MUNICIPAL REGULATIONS.
- 3. ALL DISTURBANCES WITHIN THE PUBLIC WAY SHALL CONFORM TO CITY AND BWSC
- THIS PLAN HAS BEEN PREPARED FOR APPROVAL OF THE WATER, SEWER AND DRAIN CONNECTIONS TO THE BWSC FACILITIES. IT IS UNDERSTOOD THAT THE RESPONSIBILITY OF OWNERSHIP AND MAINTENANCE OF THE SEWER CONNECTIONS ON PRIVATE PROPERTY AND/OR PRIVATE AND PUBLIC WAYS SHALL BE THE RESPONSIBILITY OF THE DEVELOPER AND/OR OWNERS. IT IS ALSO UNDERSTOOD THAT THE WATER CONNECTIONS ON PRIVATE PROPERTY INCLUDING PRIVATE WAYS ARE ALSO THE RESPONSIBILITY OF THE DEVELOPER AND/OR OWNERS. IF THE CONNECTIONS CROSS, OR ARE NEAR INDIVIDUAL PROPERTY LINES. PROVISIONS MUST BE MADE TO ALLOW EACH OWNER TO MAINTAIN OR RECONSTRUCT THEIR RESPECTIVE CONNECTIONS. THIS FACT MUST BE INCORPORATED INTO ANY PURCHASE AND SALES AGREEMENT AND DEEDS RELATED TO THE TRANSFER OF OWNERSHIP OF THE PROPERTIES.
- THE GRAVITY DRAIN AND SEWER PIPES SHALL BE POLYVINYL CHLORIDE (PVC) PIPE SDR 35 CONFORMING TO ASTM STANDARD SPECIFICATIONS D3034 FOR SEWER AND DRAIN PIPES OUTSIDE THE BUILDING FOUNDATION ENVELOPE.
- 6. DOMESTIC WATER SERVICE SHALL BE TYPE "K" COPPER TUBING IN ACCORDANCE WITH BWSC STANDARDS.

- 9. THE CONTRACTOR SHALL OBTAIN THE ROUGH CONSTRUCTION SIGN OFF DOCUMENT FROM THE CITY OF BOSTON INSPECTIONAL SERVICES DEPARTMENT PRIOR TO FILING A GENERAL SERVICES APPLICATION WITH BWSC.
- 10. THE CONTRACTOR WILL BE RESPONSIBLE FOR PREPARING AS-BUILT PLANS IN ACCORDANCE WITH BWSC REQUIREMENTS. THIS INFORMATION SHALL BE SUBMITTED TO THE CIVIL ENGINEER FOR THEIR USE.
- 11. THE CONTRACTOR SHALL CONFIRM THE LOCATIONS AND INVERTS OF THE EXISTING UTILITIES IN THE STREET PRIOR TO THE INSTALLATION OF NEW SERVICE CONNECTIONS PRIOR TO ANY UTILITY SITE WORK. THE EXISTING UTILITY SERVICES SHOWN ON THESE PLANS ARE SHOWN FOR PERMITTING PURPOSES ONLY AND SHALL NOT BE CONSTRUED AS ACCURATE.
- 12. ANY CONSTRUCTION DEWATERING SHALL EMPLOY MEASURES TO FILTER OUT SEDIMENT PRIOR TO ITS DISCHARGE AND SHALL CONFORM WITH BWSC REQUIREMENTS. CONTRACTOR TO SUBMIT A SKETCH OF THESE TO THE CIVIL ENGINEER FOR APPROVAL.
- 13. CONTRACTOR TO EMPLOY MEASURES TO CONTROL DUST DURING CONSTRUCTION.
- THE PROPOSED FINISH GRADE ELEVATIONS OF THE UTILITY STRUCTURES ARE APPROXIMATE ONLY. FINAL ELEVATIONS ARE TO BE SET FLUSH. ADJUST ALL OTHER RIM ELEVATIONS OF EXISTING MANHOLES, WATER GATES, GAS GATES AND OTHER UTILITIES TO FINISHED GRADE WITHIN LIMITS OF SITE WORK.
- 15. THE SITE CONTRACTOR SHALL PROVIDE ALL EXCAVATION, INSTALLATION, BACK FILLING. PAVEMENT PATCHING, ETC. FOR THE INSTALLATION OF UNDERGROUND GAS, ELECTRIC. TELEPHONE, FIRE ALARM, WATER, SEWER, DRAIN AND SIMILAR SERVICES.
- 16. IF EXISTING ABANDONED BWSC SERVICES ARE ENCOUNTERED THEY SHALL BE CUT AND

- COORDINATE CATV, TELEPHONE AND GAS INSTALLATION WITH THE UTILITY COMPANIES. THE PROPOSED LOCATIONS OF THESE SERVICES ON THESE PLANS ARE FOR PERMITTING PURPOSES ONLY.
- 19. THE EXISTING SEWER, DRAIN AND WATER SERVICES SHOWN ON THESE PLANS ARE SHOWN STRICTLY FOR PERMITTING PURPOSES ONLY. EXACT LOCATIONS AND ELEVATIONS SHALL BE FIELD VERIFIED PRIOR TO CONSTRUCTION.
- 20. COORDINATE EXACT SITE LAYOUT, DRAINAGE GRATE MATERIALS, AND PAVING DESIGN/MATERIALS WITH ARCHITECT PRIOR TO CONSTRUCTION. THESE PLANS ARE FOR THE PROPOSED UTILITY DESIGN TO BE USED FOR BWSC PERMITTING PURPOSES ONLY.
- 21. SEE ARCHITECTURAL PLANS FCR PROPOSED BUILDING AND SITE LAYOUT. THESE PLANS ARE FOR BWSC PERMITTING PURPOSES ONLY.
- 22. ALL WORK COMPLETED SHALL BE CONSTRUCTED SO THERE IS NO DISTURBANCE TO ANY EXISTING LAND OR ANY EXISTING STRUCTURES ON THE ADJACENT LOTS.
- 23. A GEOTECHNICAL ENGINEER SHALL BE CONSULTED ON THE HYDRAULIC WATERPROOFING OF THE PROPOSED AND EXISTING FOUNDATION WALLS AND SLABS PRIOR TO CONSTRUCTION OF THE PROPOSED INFILTRATION SYSTEM. THE GENERAL CONTRACTOR SHALL COORDINATE WITH THE GEOTECHNICAL ENGINEER ON ALL WATERPROOFING THAT MAY BE REQUIRED WITHIN THE SUB-BASEMENT AREA TO PROTECT EXISTING ABUTTERS PROPERTIES DUE TO THE PROPOSED STORMWATER INFILTRATION SYSTEM.

RUNOFF VOLUME = 722 x (1.0/12) = 60 C.F. RUNOFF FROM 1.0 INCH STORM

LEACHING STRUCTURE

CUSTOM CONCRETE MASONRY BLOCK WITH REBAR STORM WATER LEACHING CHAMBER UNIT DIMENSIONS = 9.75 FT. (LENGTH), 3.1 FT. (WIDTH), AND 2.0 FT. (INTERIOR HEIGHT)

STORM WATER VOLUME CALCULATIONS

LEACHING CHAMBER VOLUME

CHAMBER STORAGE = L x W x H = 9.75 FT. x 3.1 FT. x 2.0 FT. = 60.45 C.F.


TOTAL STORAGE VOLUME


TOTAL STORAGE VOLUME = 60.45 C.F. (LEACHING CHAMBER)

STORM WATER STORAGE VOLUME = 60.45 C.F. > 60 C.F. RUNOFF FROM 1.0 INCH STORM

THE PROPOSED LEACHING SYSTEM WILL PROVIDE THE REQUIRED STORAGE TO MITIGATE THE RUNOFF VOLUME FROM THE 1.0 INCH STORM EVENT.

STORMWATER INFILTRATION SYSTEM STORAGE CALCULATIONS

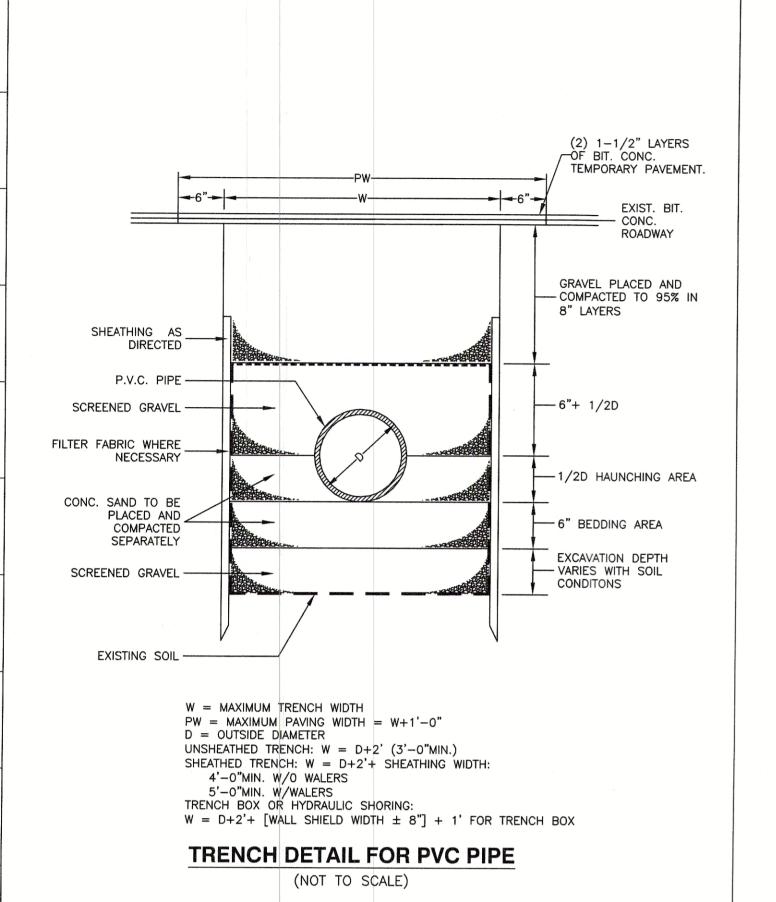


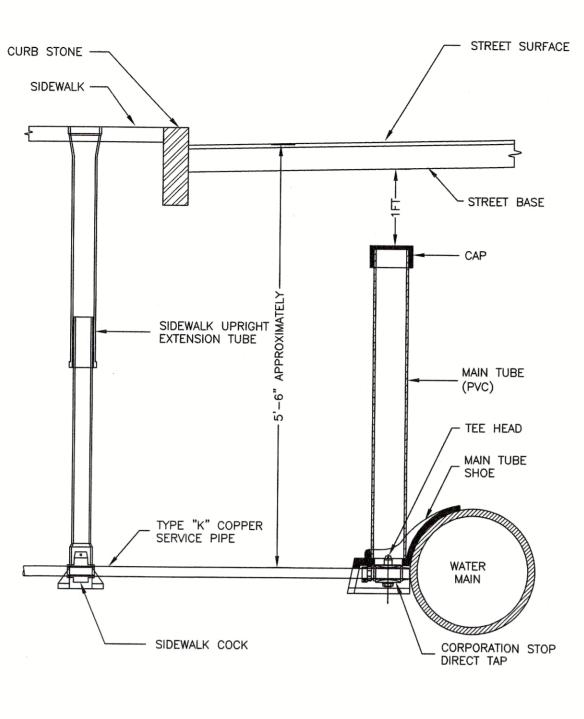

TYPICAL WATER CONNECTION FOR 3/4" AND 1" SERVICE PIPES

(NOT TO SCALE)

TYPICAL WATER CONNECTION FOR 11/2" AND 2" SERVICE PIPES (NOT TO SCALE)

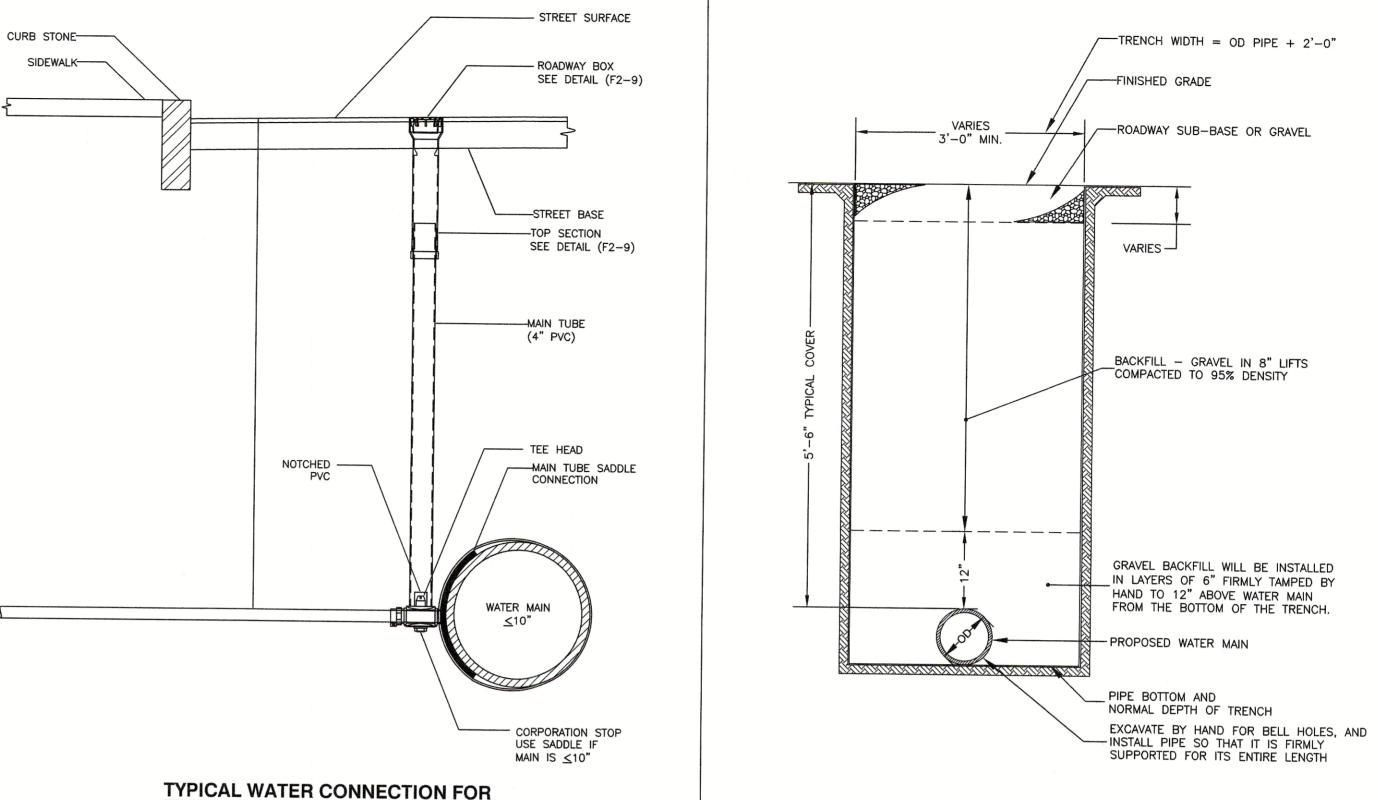

TYPICAL TRENCH DETAIL OF
WATER MAIN IN FIRM GROUND
(NOT TO SCALE)


OWNER/APPLICANT


3 BOND STREET, LLC. 1 ADAMS STREET LEXINGTON, MA 02420

CONTACT: ALISON RYAN

PROJECT ADDRESS


3 BOND STREET
BOSTON, MA 02118-3605

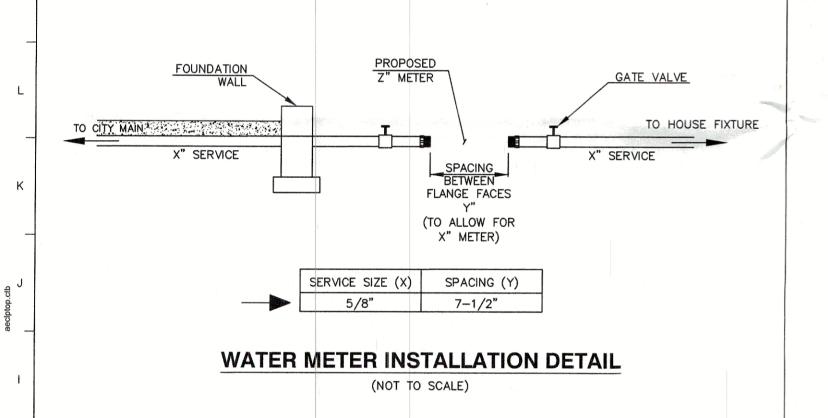

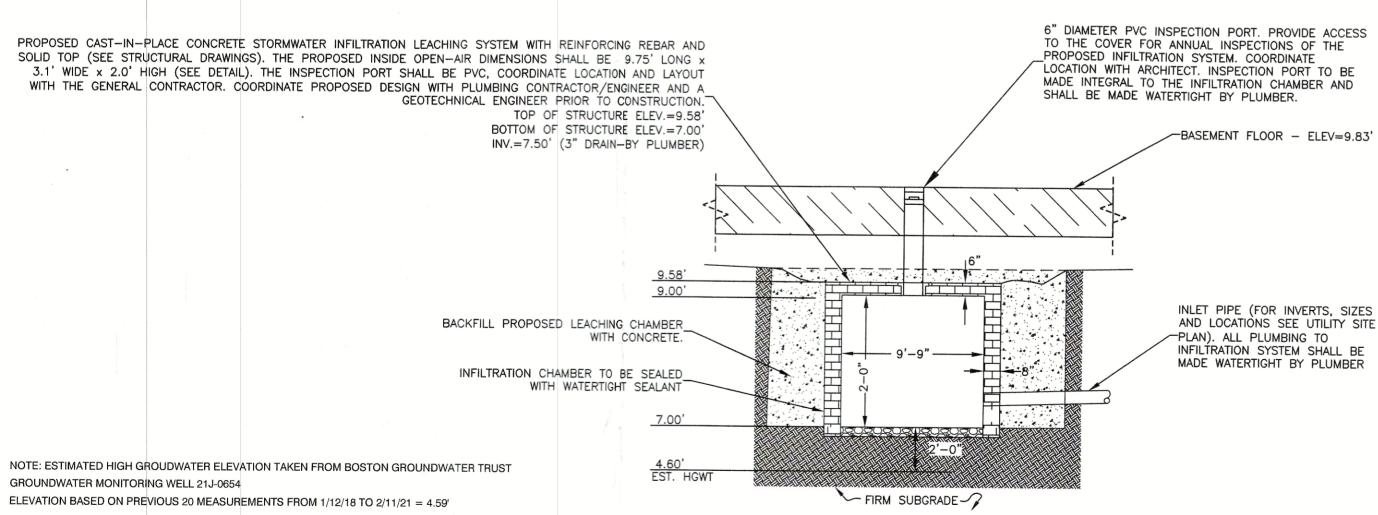


CAST-IN-PLACE LEACHING CHAMBER (INFILTRATION SYSTEM) DETAIL

(NOT TO SCALE)

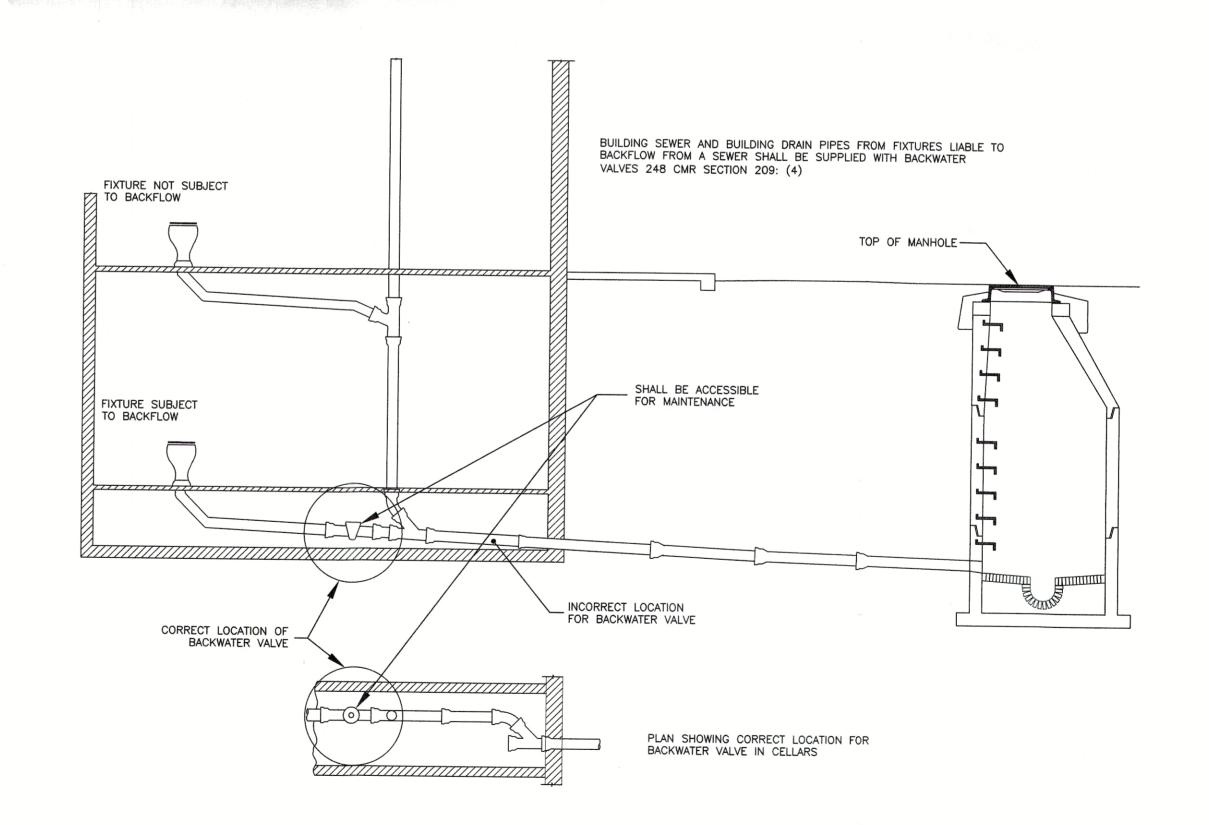

NOTE: ALL PLUMBING FIXTURES BELOW THE LEVEL OF THE TOP OF THE MANHOLE OF THE SEWER SERVICING THE FIXTURE(S) SHALL BE CONSIDERED AS BEING SUBJECT TO BACKFLOW AND SHALL BE SUPPLIED WITH BACKWATER VALVES.

LOCATION OF BACKWATER
VALVES IN BASEMENTS DETAIL
(NOT TO SCALE)

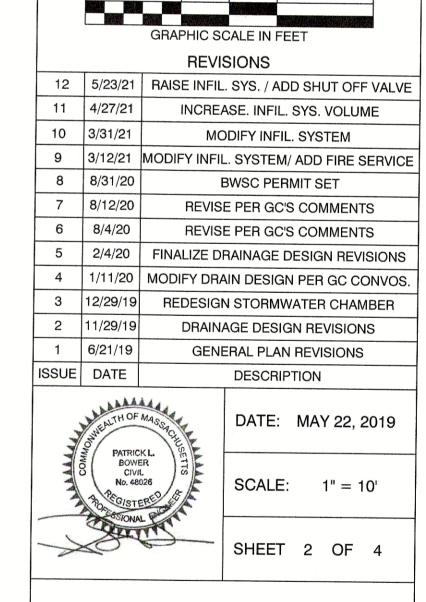


3 BOND STREET

BOSTON (SOUTH END), MASSACHUSETTS

C1.2 - DETAILS BWSC PLAN #19355

AMOSKEAG ENGINEERING CONSULTANTS, PLLC

P.O. BOX 563 SANDOWN, NH 03873 tel.: 603.493.2797

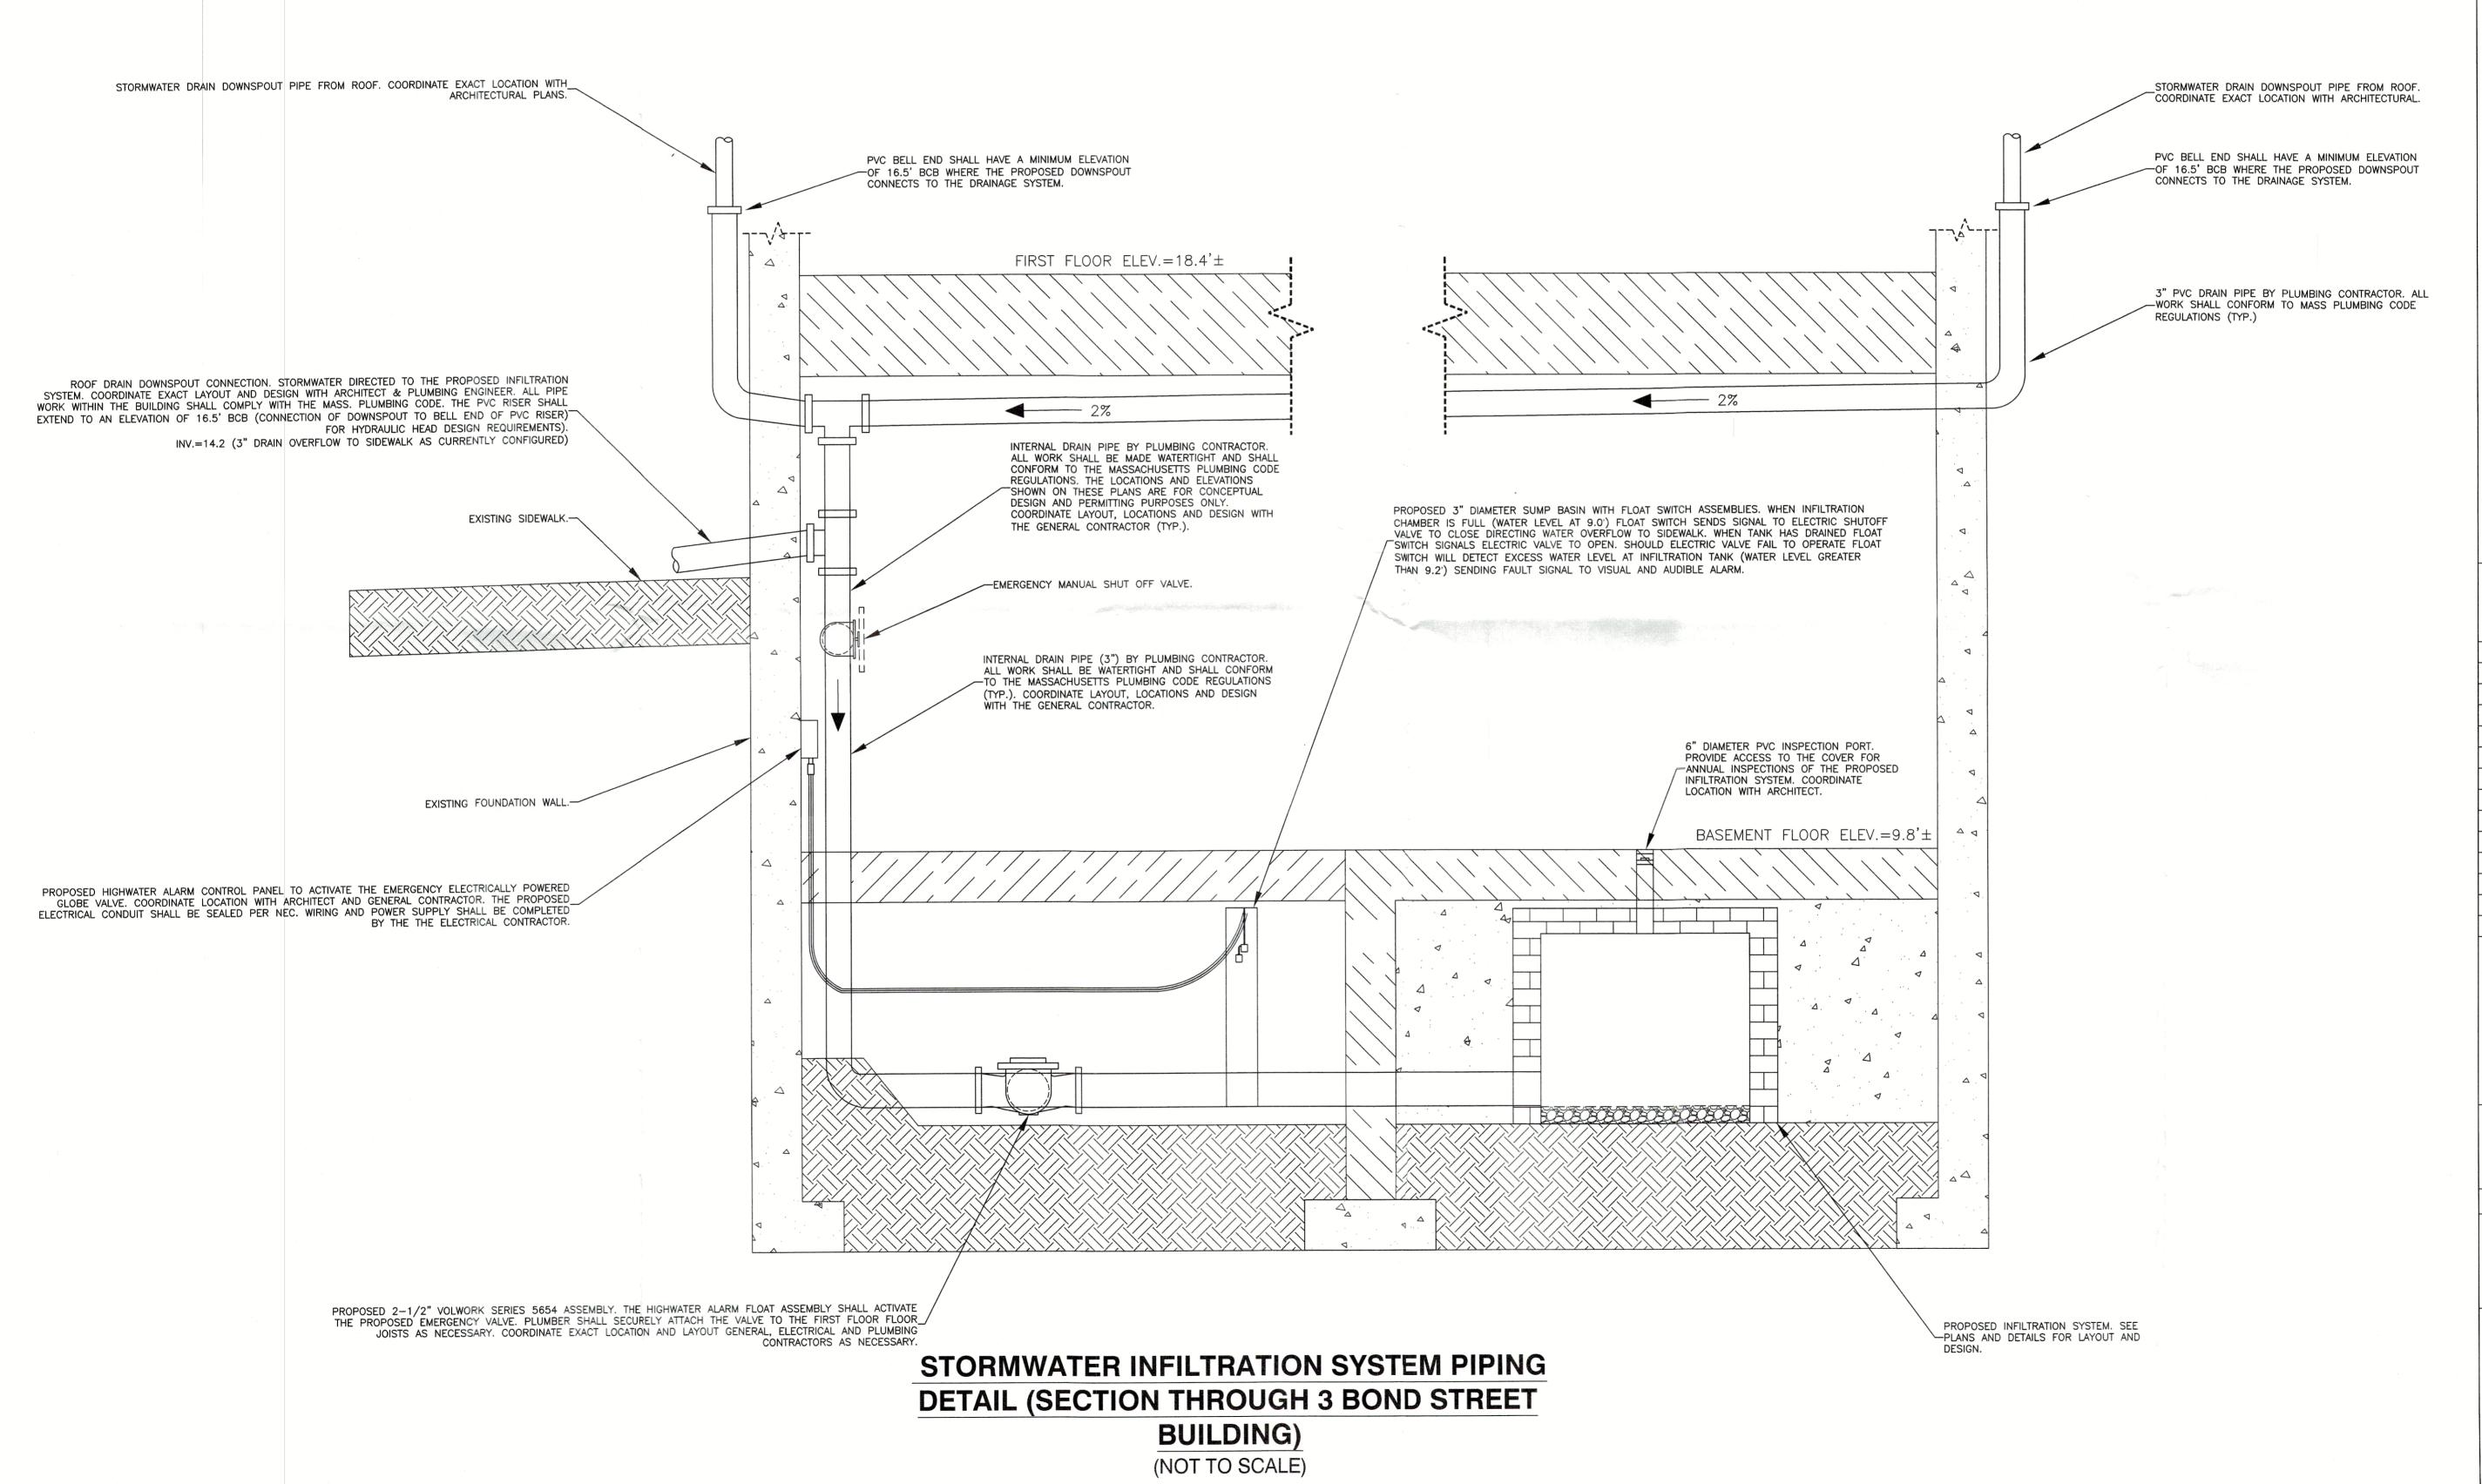

OWNER/APPLICANT

3 BOND STREET, LLC. 1 ADAMS STREET LEXINGTON, MA 02420

CONTACT: ALISON RYAN

PROJECT ADDRESS

3 BOND STREET
BOSTON, MA 02118-3605




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		GRAPHIC SCALE IN FEET			
REVISIONS					
12	5/23/21	RAISE INFIL. SYS. / ADD SHUT OFF VALV			
11	4/27/21	INCREASE. INFIL. SYS. VOLUME			
10	3/31/21	MODIFY INFIL. SYSTEM			
9	3/12/21	MODIFY INFIL. SYSTEM/ ADD FIRE SERVI			
8	8/31/20	BWSC PERMIT SET			
7	8/12/20	REVISE PER GC'S COMMENTS			
6	8/4/20	BEVISE PER GC'S COMMENTS			

3 12/29/19 REDESIGN STORMWATER CHAMBER
2 11/29/19 DRAINAGE DESIGN REVISIONS
1 6/21/19 GENERAL PLAN REVISIONS
ISSUE DATE DESCRIPTION

5 2/4/20 FINALIZE DRAINAGE DESIGN REVISIONS

4 1/11/20 MODIFY DRAIN DESIGN PER GC CONVOS

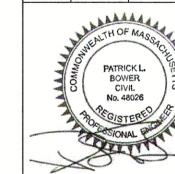

DATE: MAY 22, 2019

SHEET 3 OF 4

SCALE: 1" = 10'


3 BOND STREET

BOSTON (SOUTH END), MASSACHUSETTS

C1.3 - SECTION DETAIL BWSC PLAN #19355

AMOSKEAG ENGINEERING
CONSULTANTS, PLLC

P.O. BOX 563 SANDOWN, NH 03873 tel.: 603.493.2797

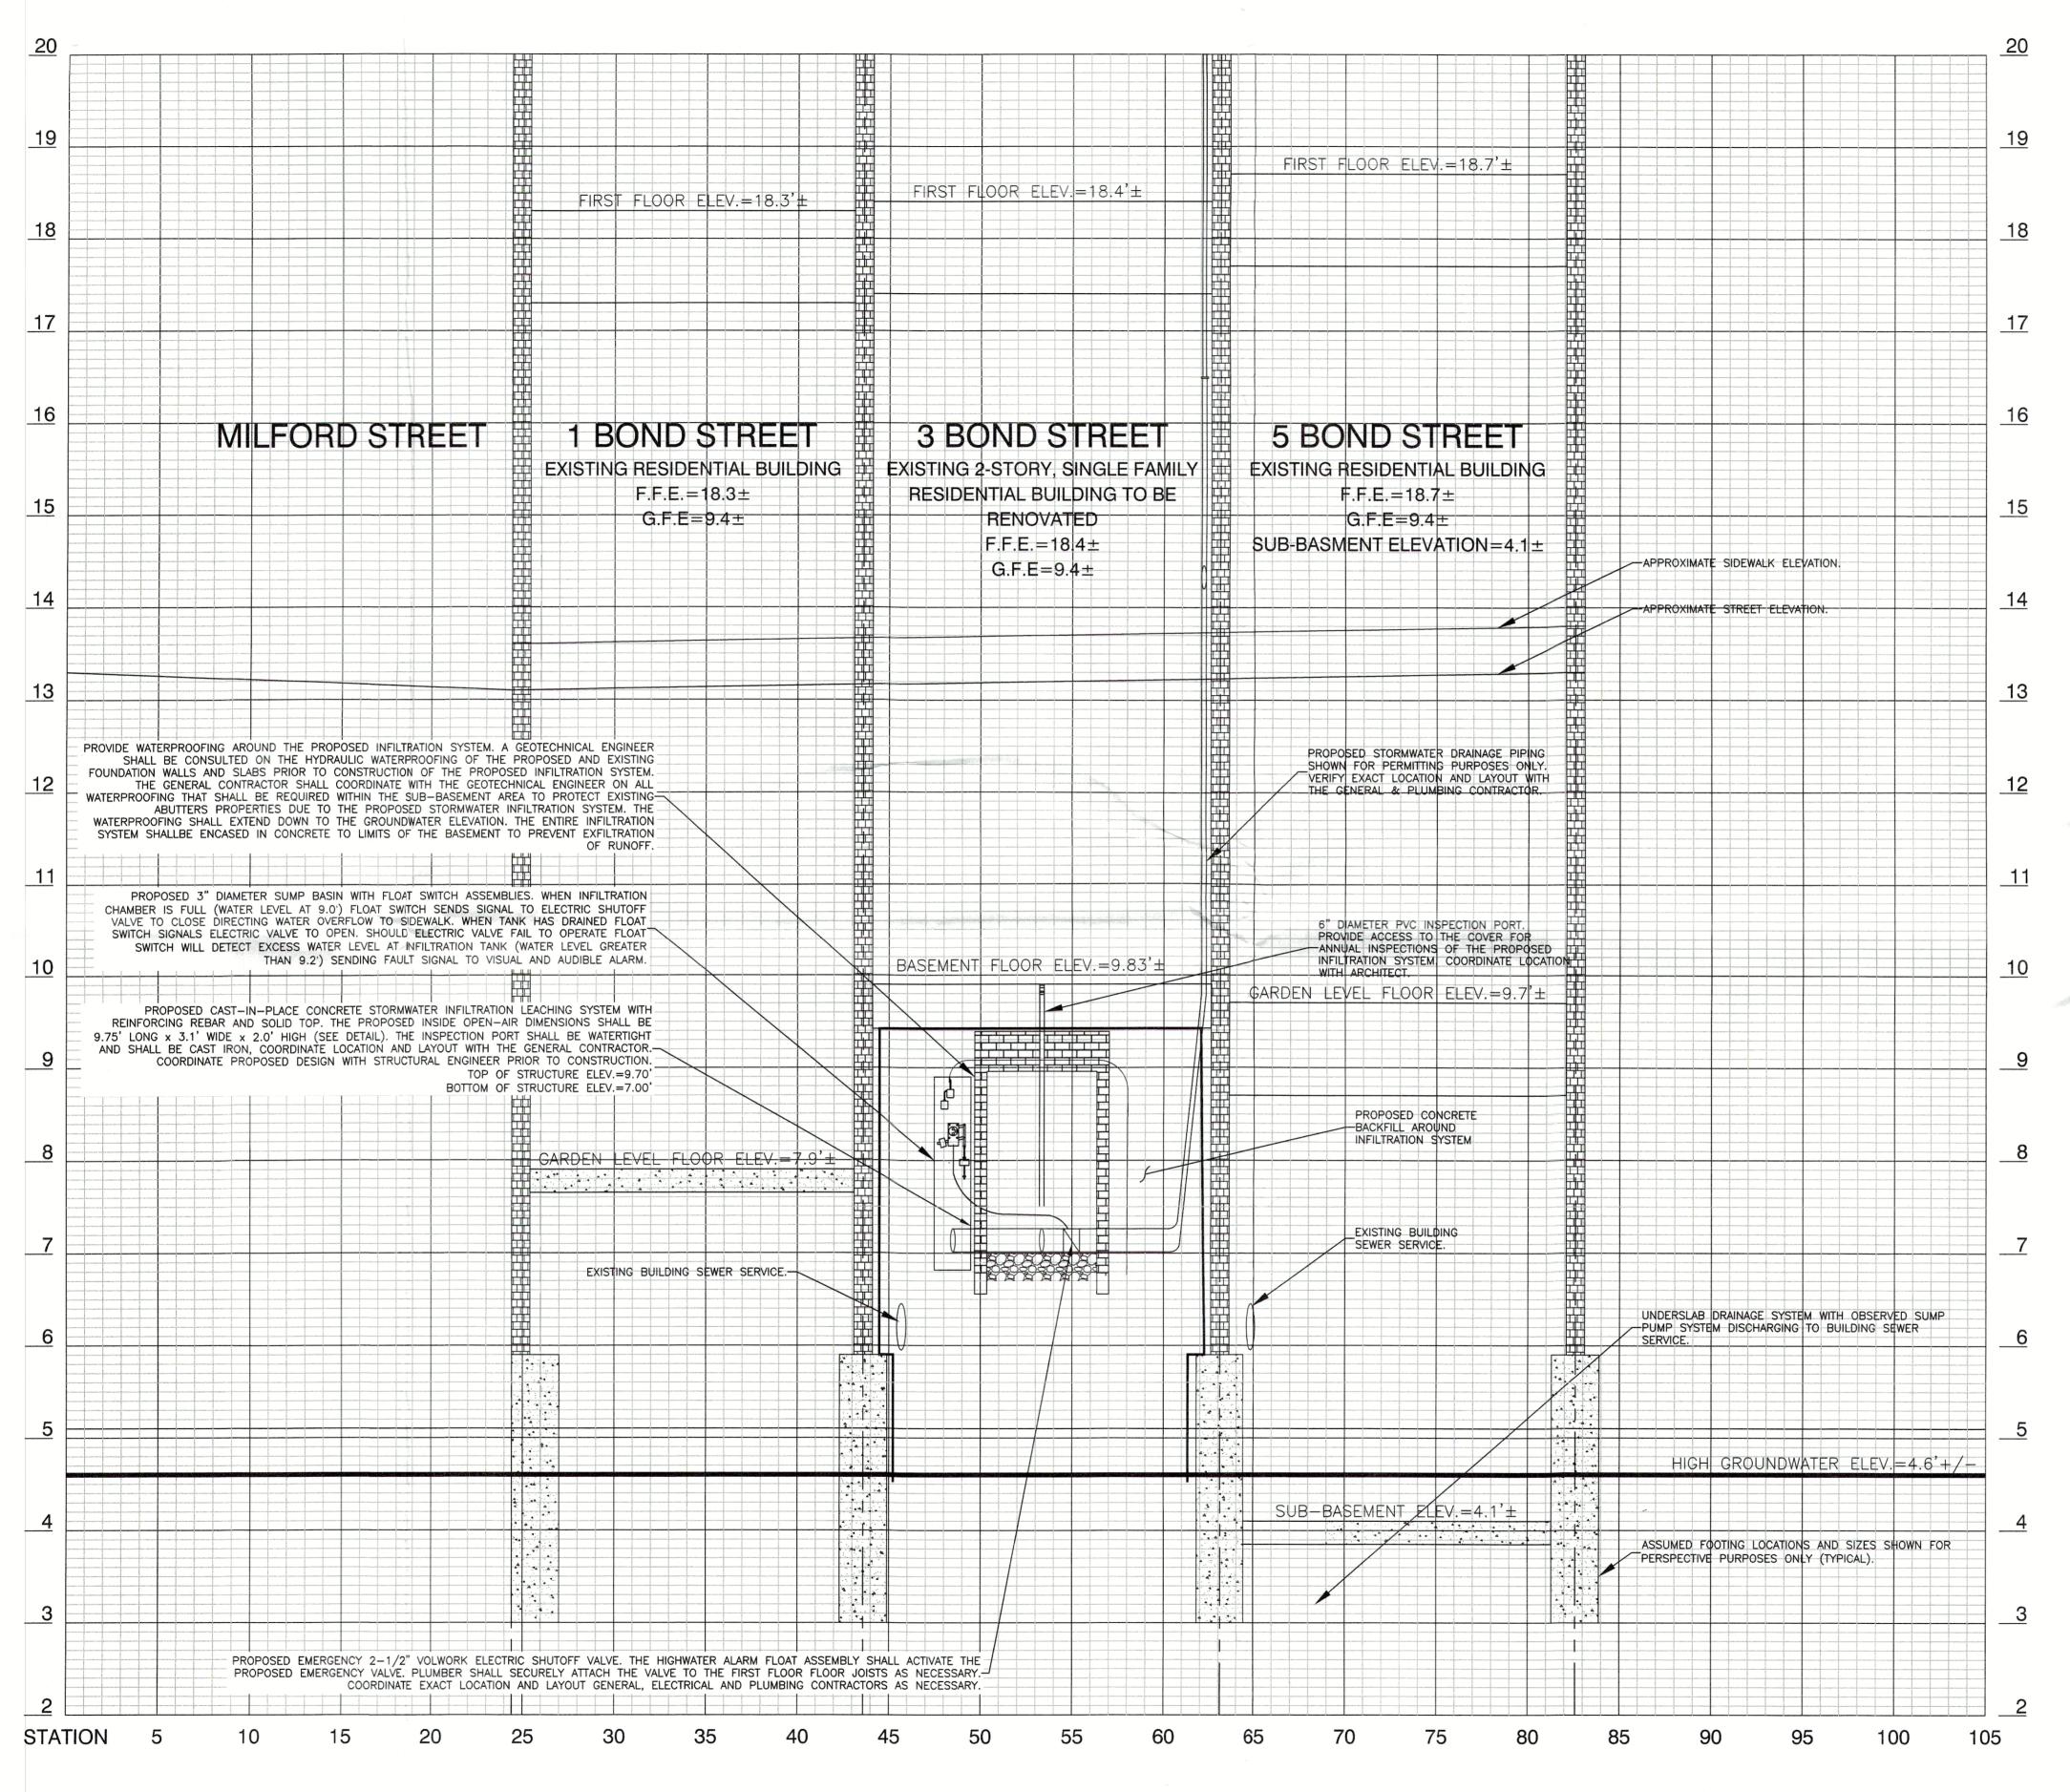

PROFILE OF EXISTING BUILDINGS ON BOND STREET (#'S 1,3 & 5)

HORIZONTAL 1" = 5'


NOTE: ESTIMATED HIGH GROUDWATER ELEVATION TAKEN FROM BOSTON GROUNDWATER TRUST GROUNDWATER MONITORING WELL 21J-0654 ELEVATION BASED ON PREVIOUS 20 MEASUREMENTS FROM 1/12/18 TO 2/11/21 = 4.59'

OWNER/APPLICANT

3 BOND STREET, LLC. 1 ADAMS STREET LEXINGTON, MA 02420


CONTACT: ALISON RYAN

PROJECT ADDRESS 3 BOND STREET BOSTON, MA 02118-3605

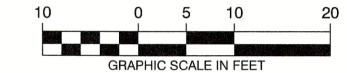

REVISIONS

12	5/23/21	RAISE INFIL. SYS. / ADD SHUT OFF VALVE
1,1	4/27/21	INCREASE. INFIL. SYS. VOLUME
10	3/31/21	MODIFY INFIL. SYSTEM
9	3/12/21	MODIFY INFIL. SYSTEM/ ADD FIRE SERVICE
8	8/31/20	BWSC PERMIT SET
7	8/12/20	REVISE PER GC'S COMMENTS
6	8/4/20	REVISE PER GC'S COMMENTS
5	2/4/20	FINALIZE DRAINAGE DESIGN REVISIONS
4	1/11/20	MODIFY DRAIN DESIGN PER GC CONVOS.
3	12/29/19	REDESIGN STORMWATER CHAMBER
2	11/29/19	DRAINAGE DESIGN REVISIONS
1	6/21/19	GENERAL PLAN REVISIONS
ISSUE	DATE	DESCRIPTION

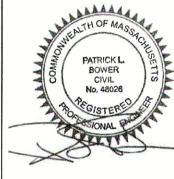

DATE: MAY 22, 2019

SCALE: 1" = 10'

SHEET 4 OF 4

3 BOND STREET

BOSTON (SOUTH END), MASSACHUSETTS

C1.4 - PROFILE DETAIL BWSC PLAN #19355

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