#### ABBREVIATIONS:

ASTM AWS AB & OR 8 APPROX ARCH  $(\alpha)$ BAL BETW BM BRG

ADDL

ALT

AFF

BLK **BORBOT** BEW BRKT BLDG

CIP CTRD CLR COL CONC CMU CONST CONSTJT OR ( CONT CJ DET DIA OR Ø DIM

EA ELECT EL OR 🕀 ELEV EMBED EQ EQUIP **EXIST** EXP BOLT EJ OR EXP JT EXT

DN

DWG

FF FT FIN FIN FL **FPRF** FL FD FTG FDN GA GALV GWB or GYP HGT H OR HORIZ HDR INFO INCL ID INSUL INT INV LWC LBS

**ADDITIONAL** ALTERNATE MATL **ABOVE FINISH FLOOR** MAX MECH AMERICAN SOCIETY FOR TESTING MEMB AND MATERIALS MEP AMERICAN WELDING SOCIETY MID ANCHOR BOLT MID-PT AND MIN **APPROXIMATELY** MR ARCHITECT OR ARCHITECTURAL AT NFPA BALANCE BETWEEN NOM BEAM NWC BEARING Ν BLOCK NIC BOTTOM NTS BOTTOM EACH WAY BRACKET BUILDING OC **OPNG** CAST-IN-PLACE OPP CENTERED OD CENTERLINE OF CLEAR P.T. COLUMN PT CONCRETE PTD CONCRETE MASONRY UNIT PTB CONSTRUCTION PSF CONSTRUCTION JOINT PSI CONTINUOUS PVC **CONTROL JOINT** P/C DETAIL R DIAMETER REF DIMENSION REINF DOWN DRAWING REQD RD EACH  $(\mathbf{S})$ **ELECTRICAL ELEVATION** SECT ELEVATOR SH EMBEDMENT SIM EQUAL SOG EQUIPMENT S EXISTING SPECS **EXPANSION BOLT** SPKR **EXPANSION JOINT** SQ **EXTERIOR** STN STL STD **FINISH FACE** STL FEET OR FOOT ST STL FINISH STRUCT **FINISHED FLOOR** SYM FIREPROOF FLOOR TEMP FLOOR DRAIN FOOTING THK FOUNDATION Х GAGE OR GAUGE ΤO GALVANIZED T & B GYPSUM WALL BOARD TOC HEIGHT TOS HORIZONTAL TOW HEADER TYP INFORMATION UNO **INCLUDING OR INCLUSIVE INSIDE DIAMETER INSIDE FACE** VIF INSULATION W **INTERIOR** WWPA INVERT JOINT W/ LIGHT WEIGHT CONCRETE W/O WP POUNDS

NO OR # SCH OR SCHED V OR VERT


MANUF OR MFR MANUFACTURER MATERIAL MAXIMUM MECHANICAL MEMBRANE MECHANICAL EQUIPMENT PAD MIDDLE MID-POINT MINIMUM MOISTURE RESISTANT NATIONAL FOREST PRODUCTS ASSOCIATION NOMINAL NORMAL WEIGHT CONCRETE NORTH NOT IN CONTRACT NOT TO SCALE NUMBER **ON CENTER** OPENING OPPOSITE OUTSIDE DIAMETER OUTSIDE FACE PRESSURE TREATED POINT PAINTED POST-TENSIONED BAR POUNDS PER SQUARE FOOT POUNDS PER SQUARE INCH POLYVINYL CHLORIDE PRECAST CONCRETE RADIUS REFERENCE REINFORCE, REINFORCING OR REINFORCEMENT REQUIRED ROOF DRAIN SEALANT SCHEDULE SECTION SHEET SIMILAR **SLAB ON GRADE** SOUTH **SPECIFICATIONS** SPRINKLER SQUARE STAINLESS STEEL STANDARD STEEL STAINLESS STEEL STRUCTURAL SYMMETRICAL **TEMPERATURE OR** TEMPORARY THICK OR THICKNESS TIMES OR BY TOP OF TOP AND BOTTOM TOP OF CURB or CONCRETE TOP OF STEEL TOP OF WALL TYPICAL UNLESS NOTED OTHERWISE VERTICAL VERIFY IN FIELD WEST WESTERN WOOD PRODUCTS ASSOCIATION WITH WITHOUT WORKING POINT

# Springfield Street Residences

## 4-6 E. Springfield Street, Boston, MA 02118

_	- T- U	,	,			
<u>CODE AN</u>	ALYSIS:		SYMBOL LEGEND			
1. APPLICABLE CODES:						EXISTING WALL
		DE : 5 (780 CMR)		PROPOSED WALL		
	IEBC 202	15			r	
	IECC 201	18 5 (527 CMR)			L J	EXISTING WALL TO BE REMOVED
		TION AMENDMENTS				
	G DISTRICT - NDA	N				EXISTING DOOR
Z. ZOMIN	SETBACKS:	<b>n</b>				EXISTING DOOR
	FRONT:	<u>ALLOWED</u> CONFORMITY	<u>EXISTING</u> 0.0'	<u>PROPOSED</u> NO CHANGE		
	RIGHT:	NONE	NONE	NO CHANGE		
	LEFT:	NONE	NONE	NO CHANGE		PROPOSED DOOR
	REAR: HEIGHT:	20' 70'	NONE 34'-2''	NO CHANGE 55'-4"	Mr.	
						EXISTING DOOR TO BE REMOVED
	FAR: 3.0 LOT SIZE: 1,53	31 SF				
	ALLOWED: 4,9	53 SF			Boom nome	
	EXISTING: 4,73 PROPOSED: 7				Room name	ROOM TAG
	BASEME	NT: 1,360 SF			101	NOOM TAG
		LOOR: 1,376 SF ) FLOOR: 1,418 SF				
	THIRD F	LOOR: 1,418 SF				- SHEET #
		I FLOOR: 1,377 SF _OOR: 800 SF			1 A101 1	ELEVATION TAG
	ER 3 - USE GROU ECTION 310.0 - R2	JP CLASSIFICATION	:		•	— VIEW #
01	-CHON 310.0 - 112	-				— VIEW #
		CTION CLASSIFICAT EPERATION - 1HR	ION		1 SIM	SECTION TAG
		PE 5A CONSTRUCT	ION		A101	
						- SHEET #
IECC SPI	ECIFICATIONS:					1HR RATED PARTITION
						(UL DESIGN U309)
1.EXTER	IOR WALLS: 2X6 WOOD FF	RAMING				
	<b>R21 MIN INSU</b>	LATION VALUE (CAV				
BASEMENT: R10 CONTINUOUS INSULATION OR R13 CAVITY INSULATION					HD (O)	HEAT DETECTOR - KIDDE HD135F
2. WINDOWS:						
	DOUBLE PAN	-	SA/CO	COMBO SMOKE/CO DETECTOR -		
MIN. U-FACTOR: .32 REQUIREMENTS FOR 1 WDW MIN PER BEDROOM:						KIDDE I12010SCO
5.7SF OPERABLE CLEAR AREA,					SA/CO	COMBO SMOKE/CO DETECTOR
44" MAX SILL HGT 3. EXTERIOR DOORS:					⊕ PE	(PHOTOELECTRIC)
DOUBLE PANE LOW E						KIDDE KN-COPE-IC
MIN. U-FACTOR: .33 4. CEILING/ROOF						

4. CEILING/ROOF **R49 MIN INSULATION VALUE** 

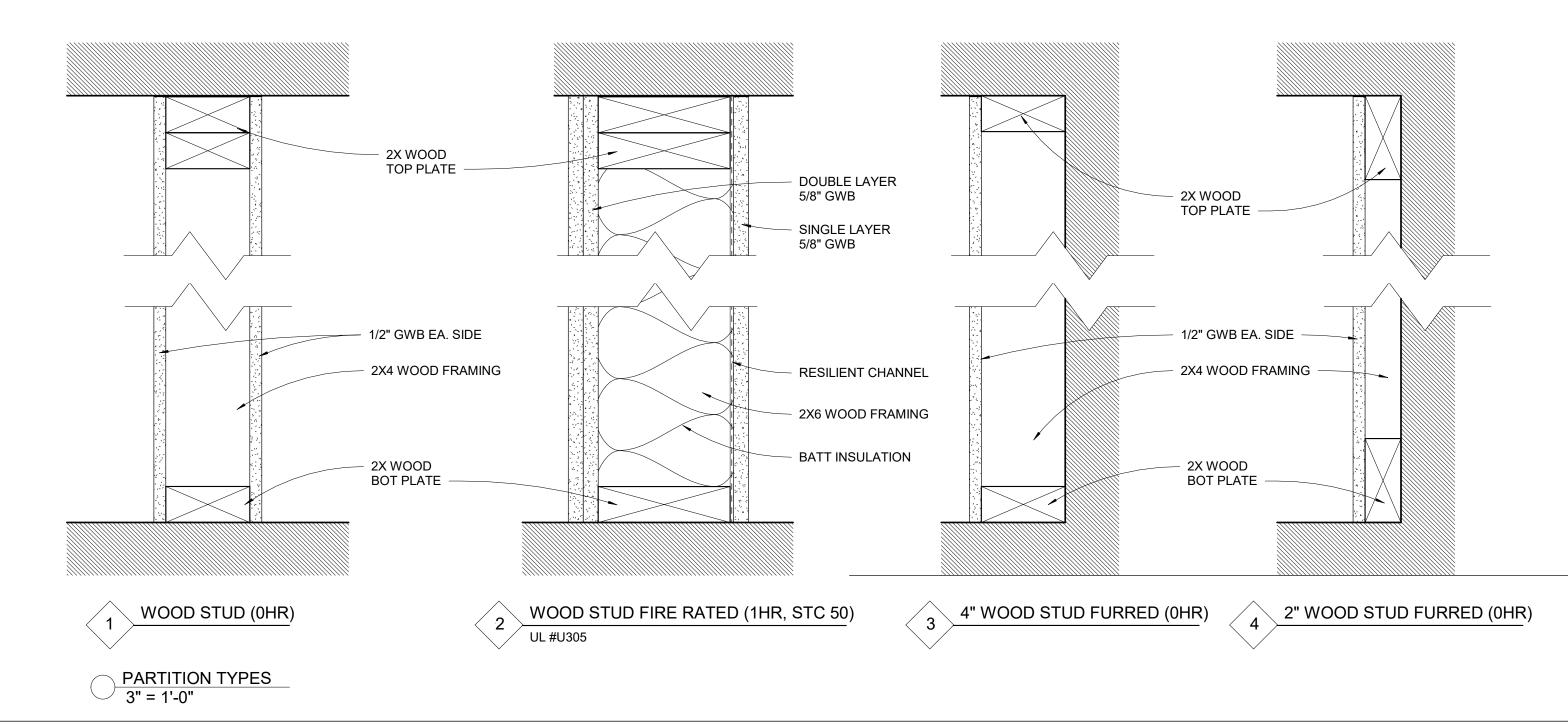

DRAWING LIST

SHEET NAME SHEET #

A000	TITLE SHEET
A100	BASEMENT & 1ST FLOOR PLANS
A101	2ND & 3RD FLOOR PLANS
A102	4TH & 5TH FLOOR PLANS
A103	ROOF PLANS
A200	EXTERIOR ELEVATIONS
A201	EXTERIOR ELVATIONS

### **GENERAL NOTES:**

- 1. WORK SHALL COMPLY WITH FEDERAL, STATE AND LOCAL BUILDING CODES AND REGULATIONS. UNLESS OTHERWISE AGREED UPON, THE CONTRACTOR IS RESPONSIBLE FOR SECURING ALL BUILDING PERMITS AS REQUIRED TO PERFORM HIS OR HER WORK AND WILL RETAIN AND PAY FOR ALL REQUIRED INSPECTIONS FOR THE DURATION OF CONSTRUCTION.
- 2. CONTRACTOR SHALL VERIFY ALL EXISTING CEILINGS AND EGRESS STAIRS ARE 1HR FIRE RATED. SINGLE LAYER OF PLASTER OR 5/8" GWB EACH SIDE OF INTERIOR PARTITION (UL DESIGN# L305) SINGLE 5/8" AT CEILINGS (UL DESIGN# L512). ALL REPLACEMENT PATCHING OR REPAIRING IS THE RESPONSIBILITY OF CONTRACTOR. CONTACT ARCHITECT IF RATING IS BELIEVED TO BE INHERENT IN EXISTING ASSEMBLY.
- 3. CONTRACTOR SHALL ENGAGE A LICENSED ELECTRICIAN FOR ALL ELECTRICAL WORK AND IN COMPLIANCE WITH NFPA 70.
- 4. CONTRACTOR RESPONSIBLE FOR ALL PREPARATION WORK REQUIRED BY MANUFACTURER'S SPECIFICATIONS.
- 5. CONTRACTOR SHALL PROVIDE PRODUCT SUBMITTAL FOR SMOKE ALARM FIXTURES FOR APPORVAL
- 6. CONFLICTS BETWEEN SITE CONDITIONS AND DRAWINGS SHALL BE BROUGHT TO THE IMMEDIATE ATTENTION OF THE ARCHITECT OR THE APPROPRIATE CONSULTING ENGINEERS.
- 7. CONFIRM DIMENSIONS WITH THE ARCHITECT OR APPROPRIATE CONSULTING ENGINEER.
- 8. CONTRACTOR TO NOTIFY ARCHITECT, AFTER LAYOUT AND PRIOR TO FRAMING, OF ANY DISCREPANCY, OMISSION, OR UNANTICIPATED FIELD CONDITIONS ALTER THE DESIGN INTENT.
- 9. CONTRACTOR TO NOTIFY ARCHITECT, AFTER LAYOUT AND PRIOR TO FRAMING, IF DIMENSIONS INDICATED WITH "+/-" VARIES MORE THAN 3" FROM ACTUAL FIELD MEASURMENTS.
- 10. CONTRACTOR RESPONSIBLE FOR ALL PREPARATION WORK REQUIRED BY MANUFACTURER'S SPECIFICATIONS.
- 11. DAMAGED TO EXISTING OR NEW CONSTRUCTION CAUSED BY THE CONTRACTOR, HIS OR HER SUB-CONTRACTORS OR CREW IS THE RESPONSIBILITY OF THE CONTRACTOR.

ARCHITECT				
S47 a	in			
517 boston post rd suite #30 sudbury, ma 01776 p: 508.500.4730 www.s47a.com	/ 111			

PROJECT: Springfield St Residences 4-6 E. Springfield Boston, MA 02118

CLIENT: **River Front Realty** 


275 Main St Boston, MA 02129

PROJECT TEAM:

**REVISIONS:** 

DRAWING TITLE:

### TITLE SHEET

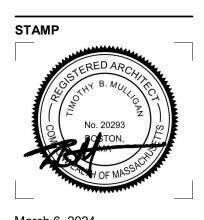



March 6, 2024 DATE OF ISSUE **DESIGN REVIEW** DOCUMENT PHASE


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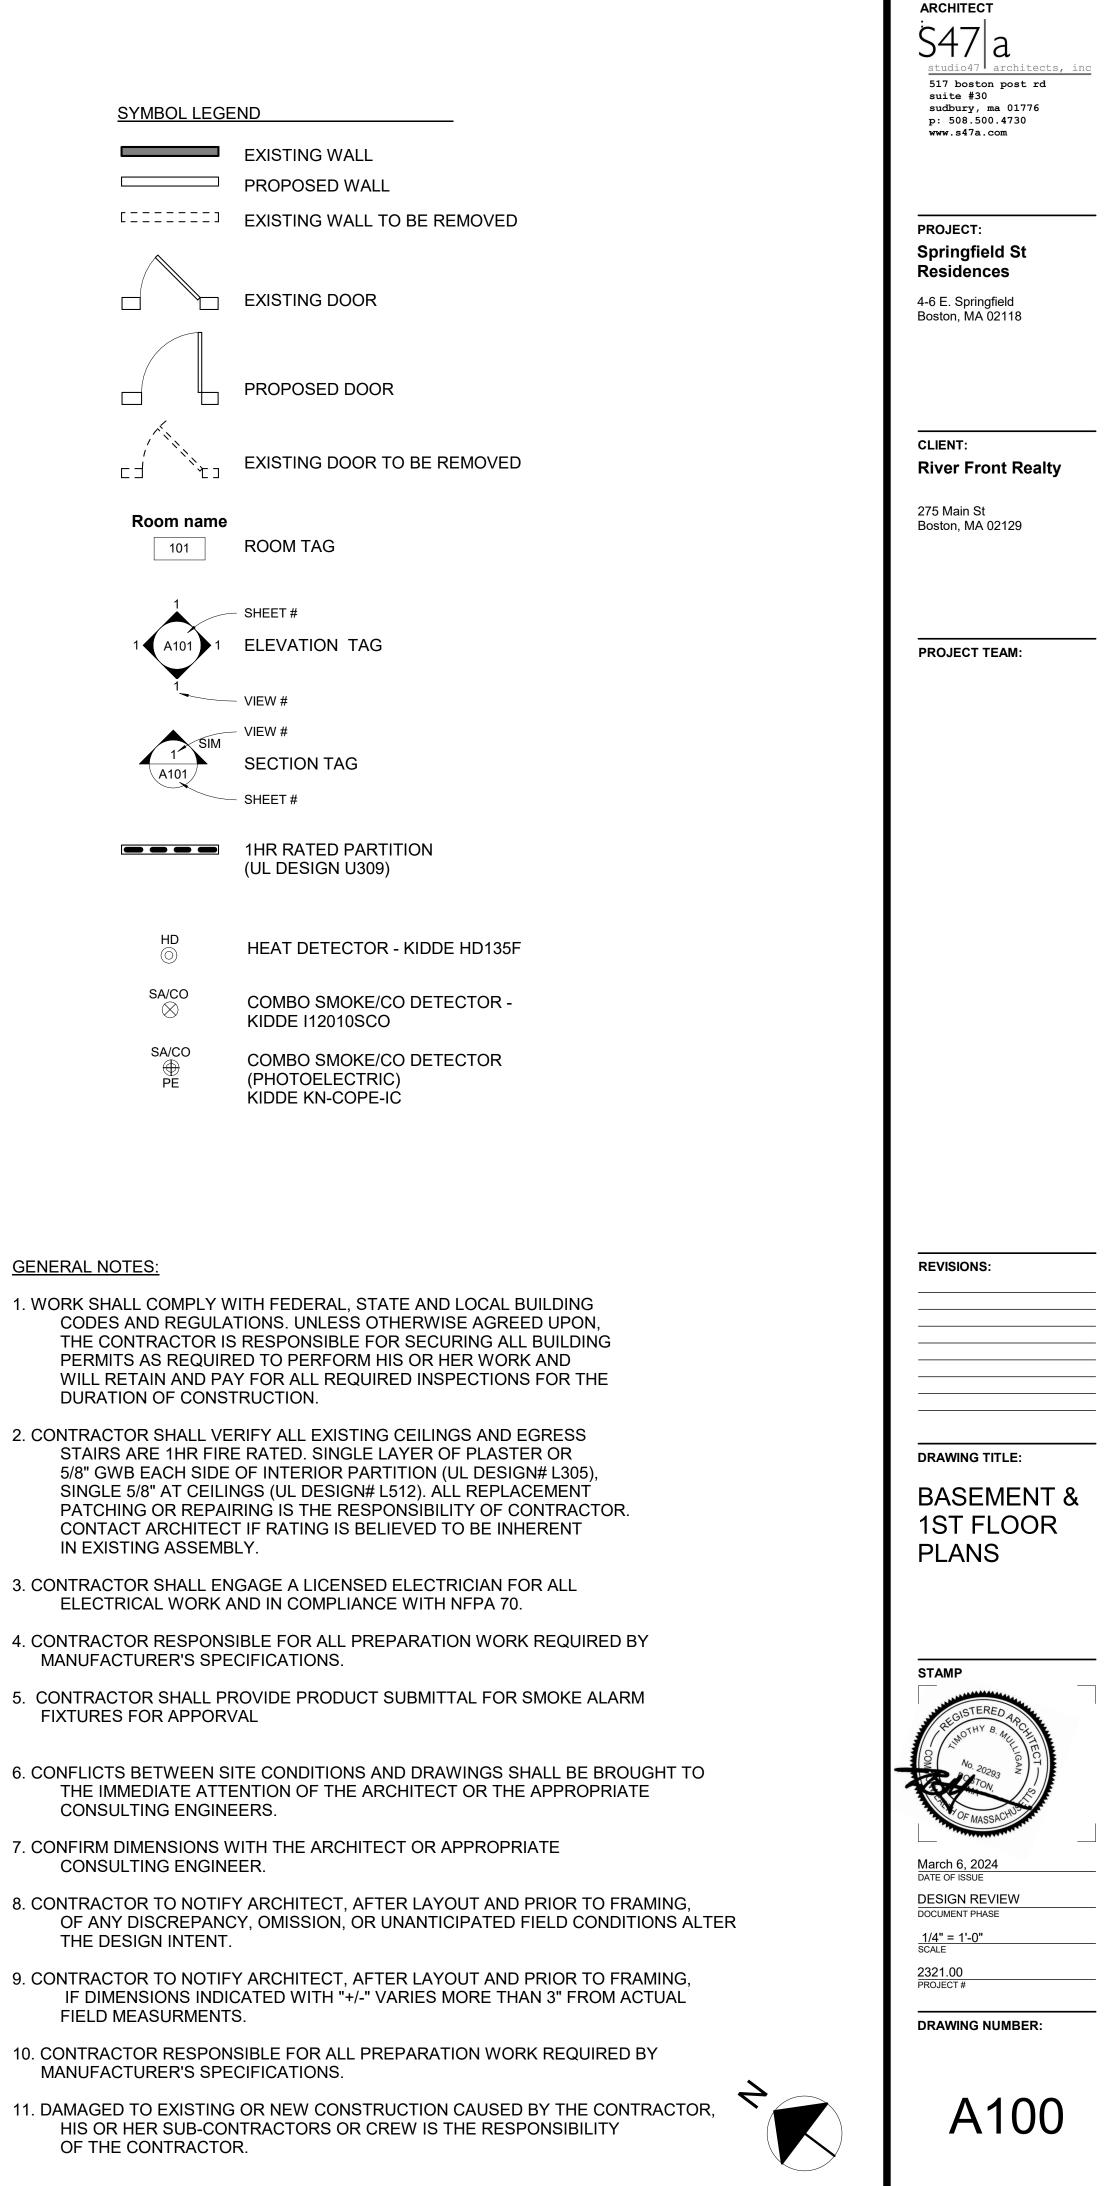
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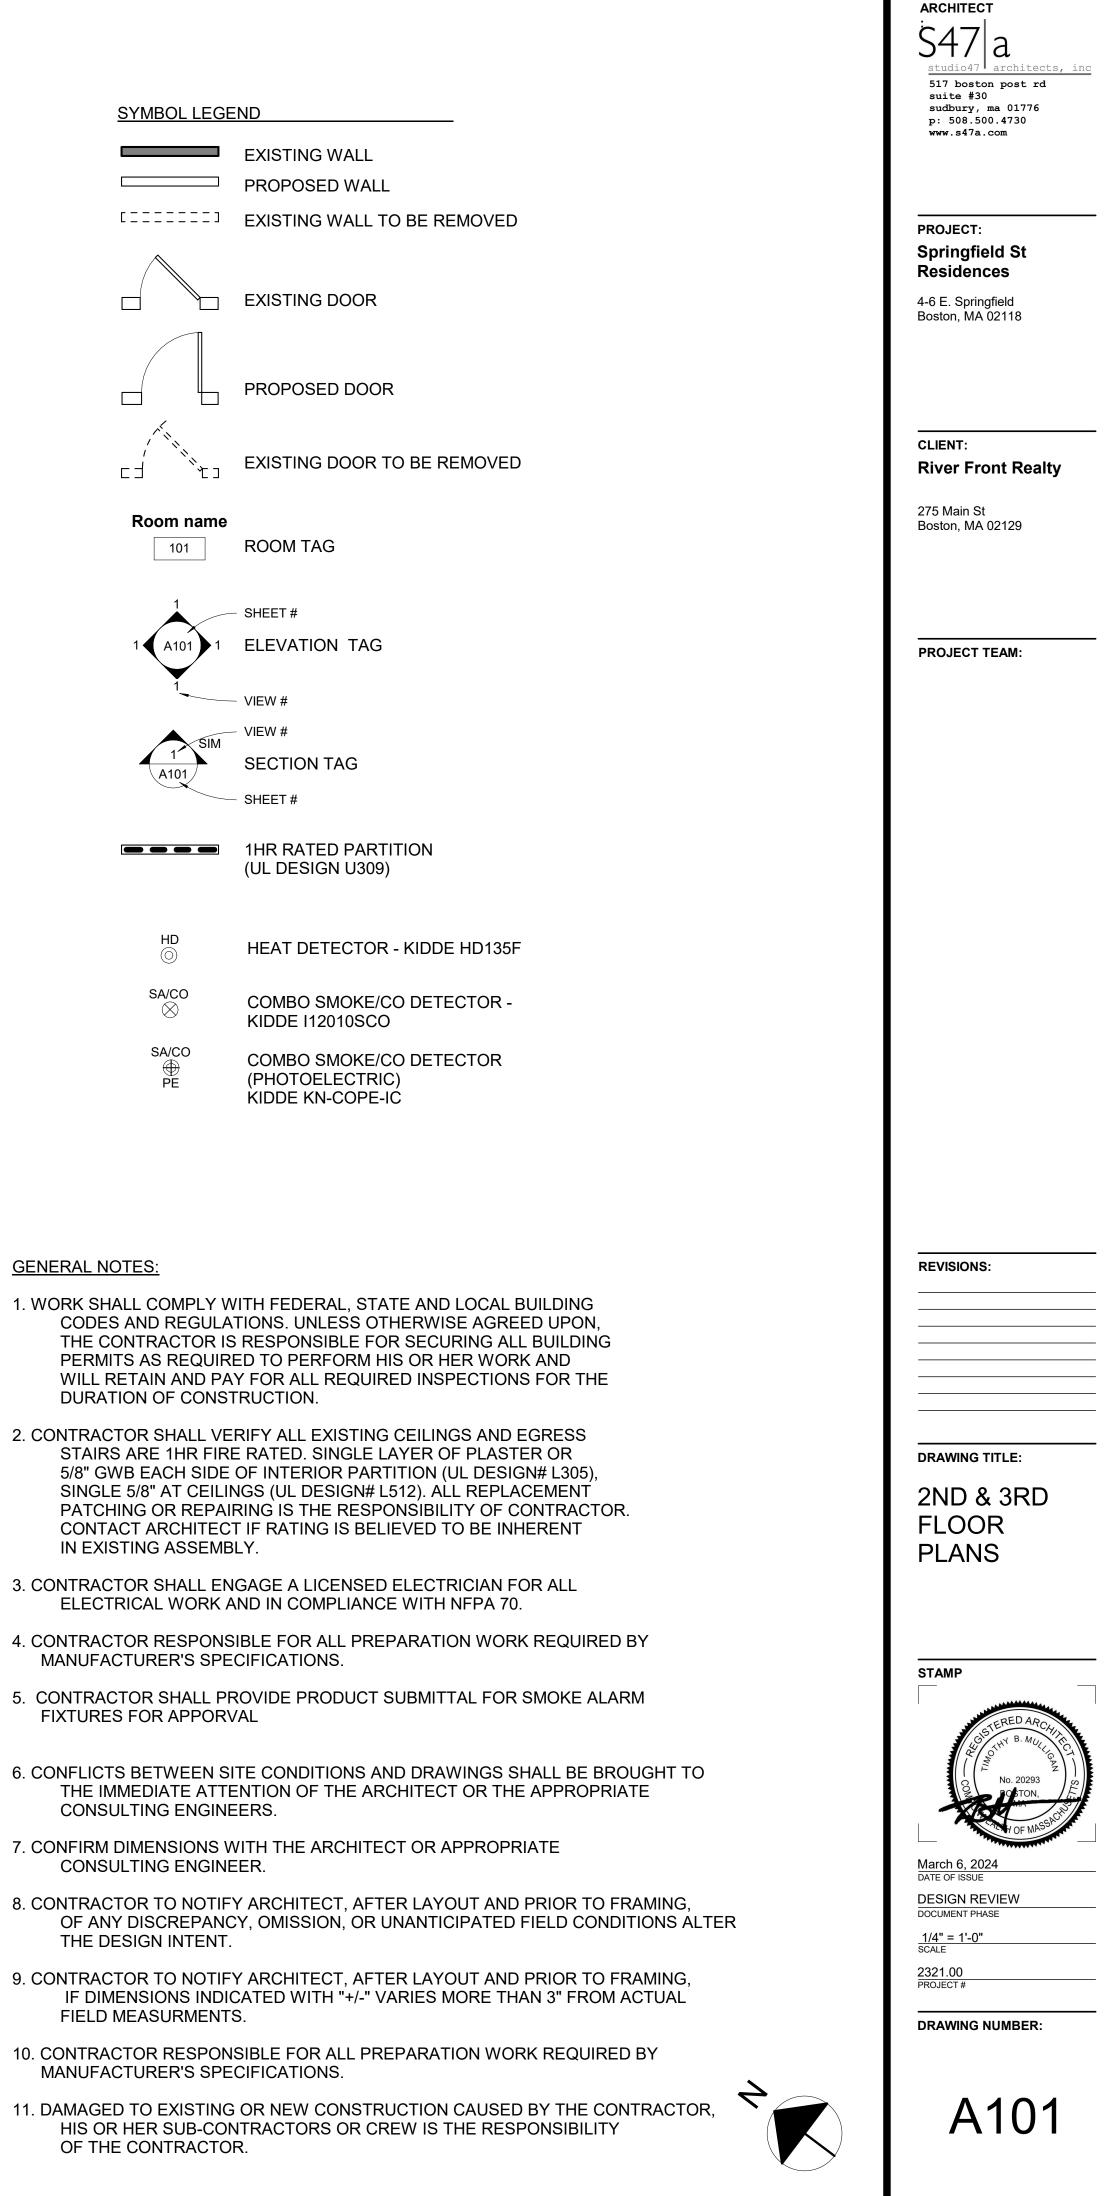



**GENERAL NOTES:** 




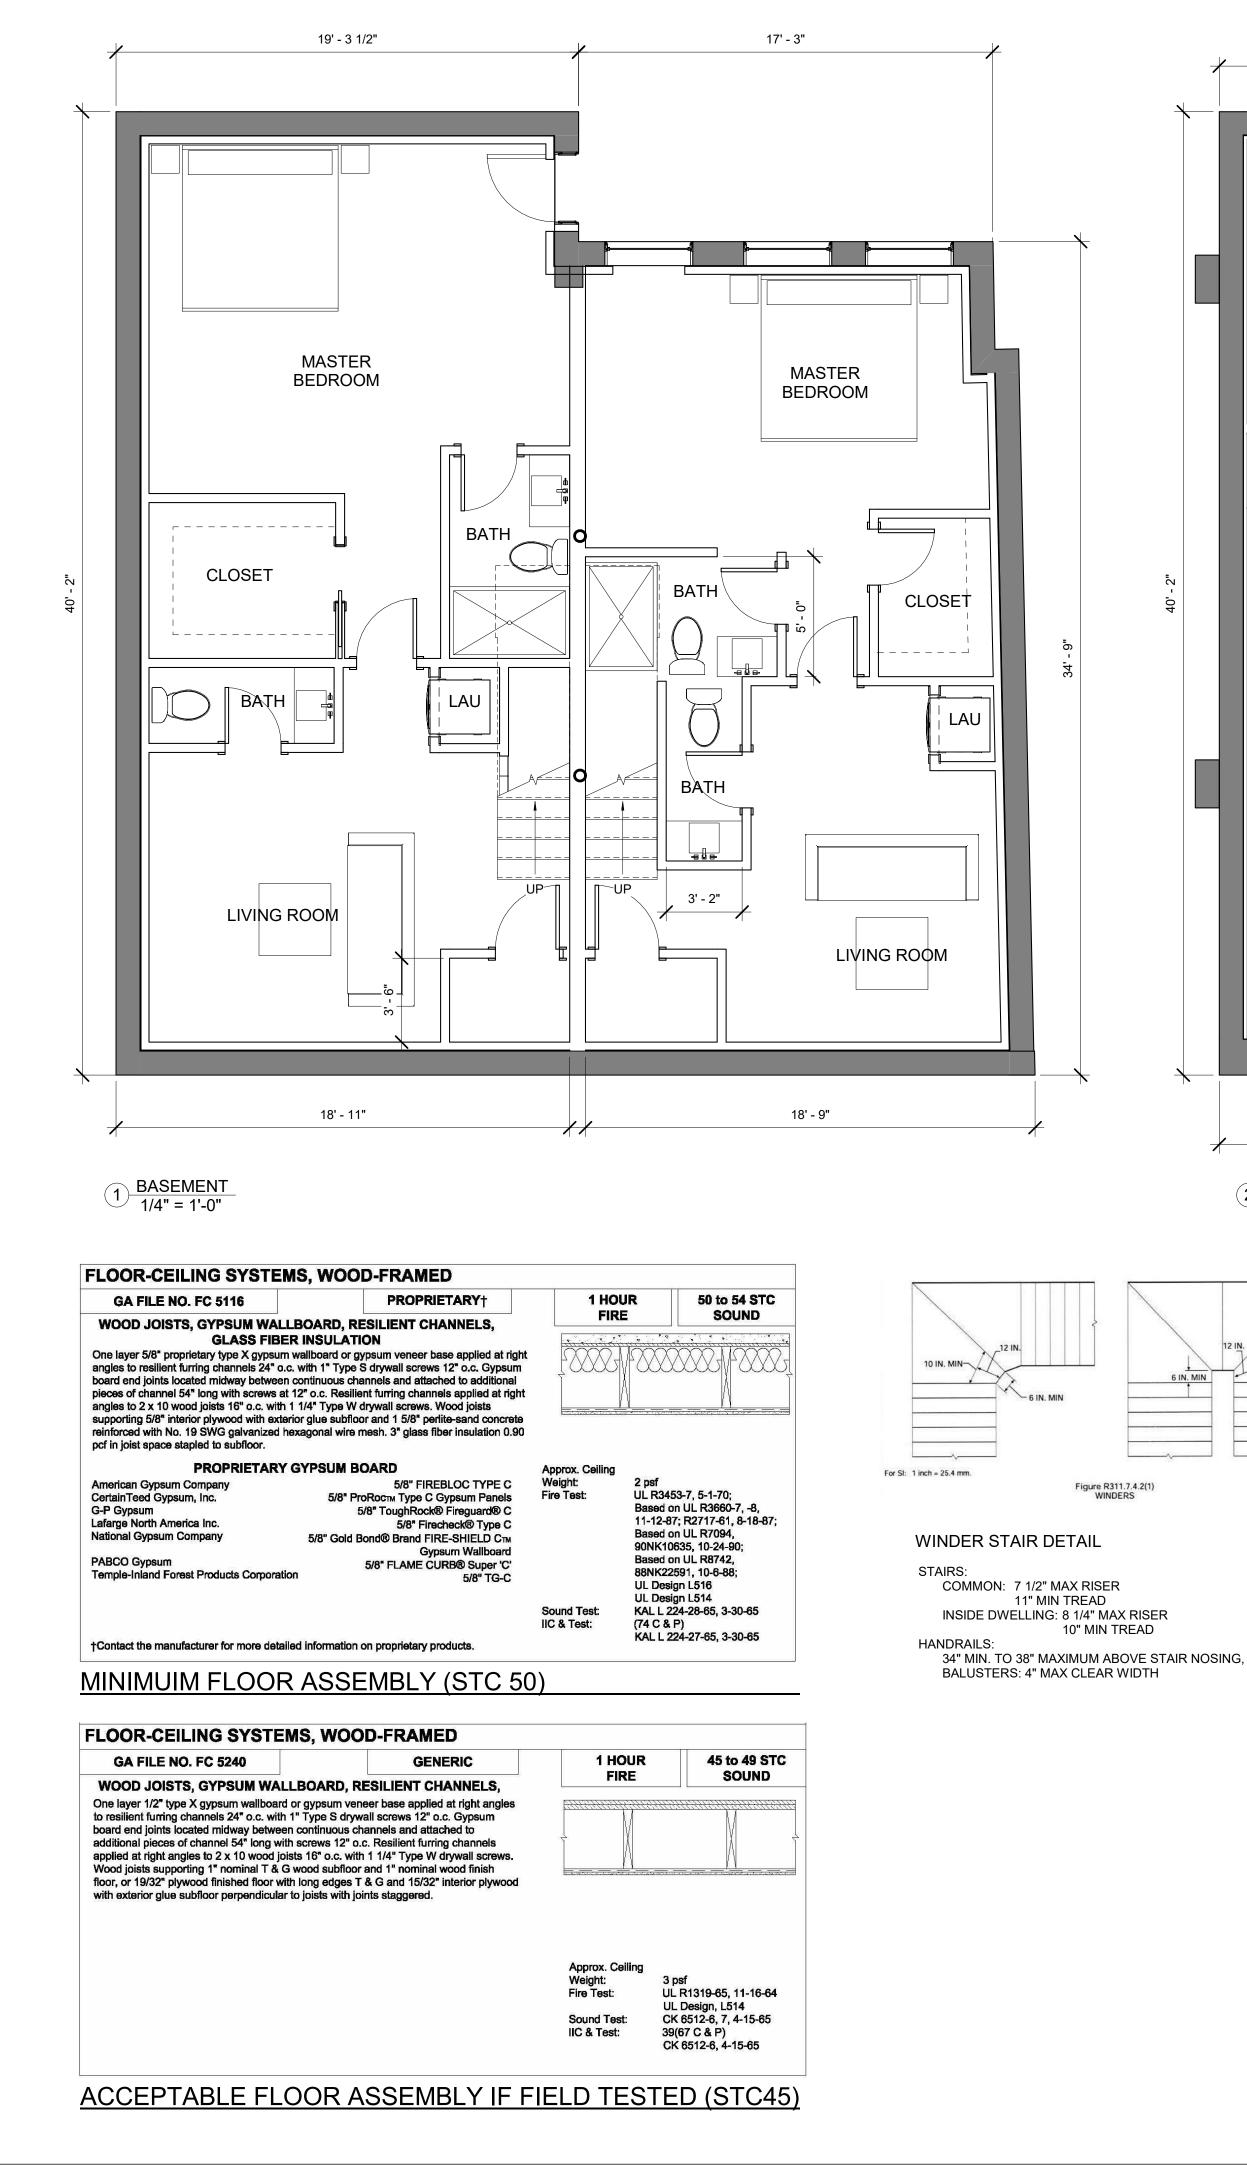

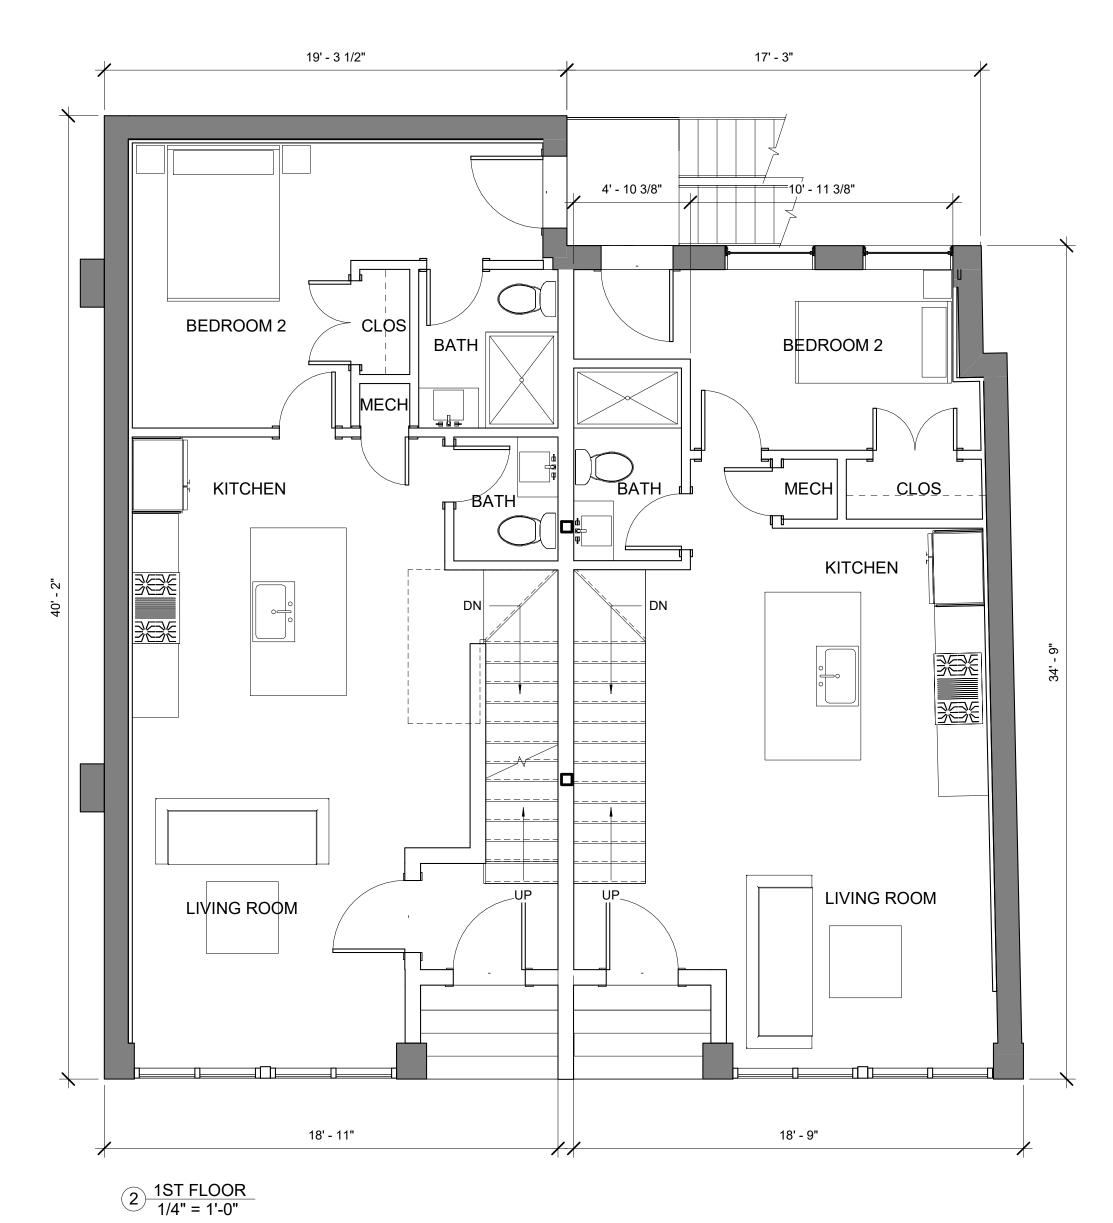
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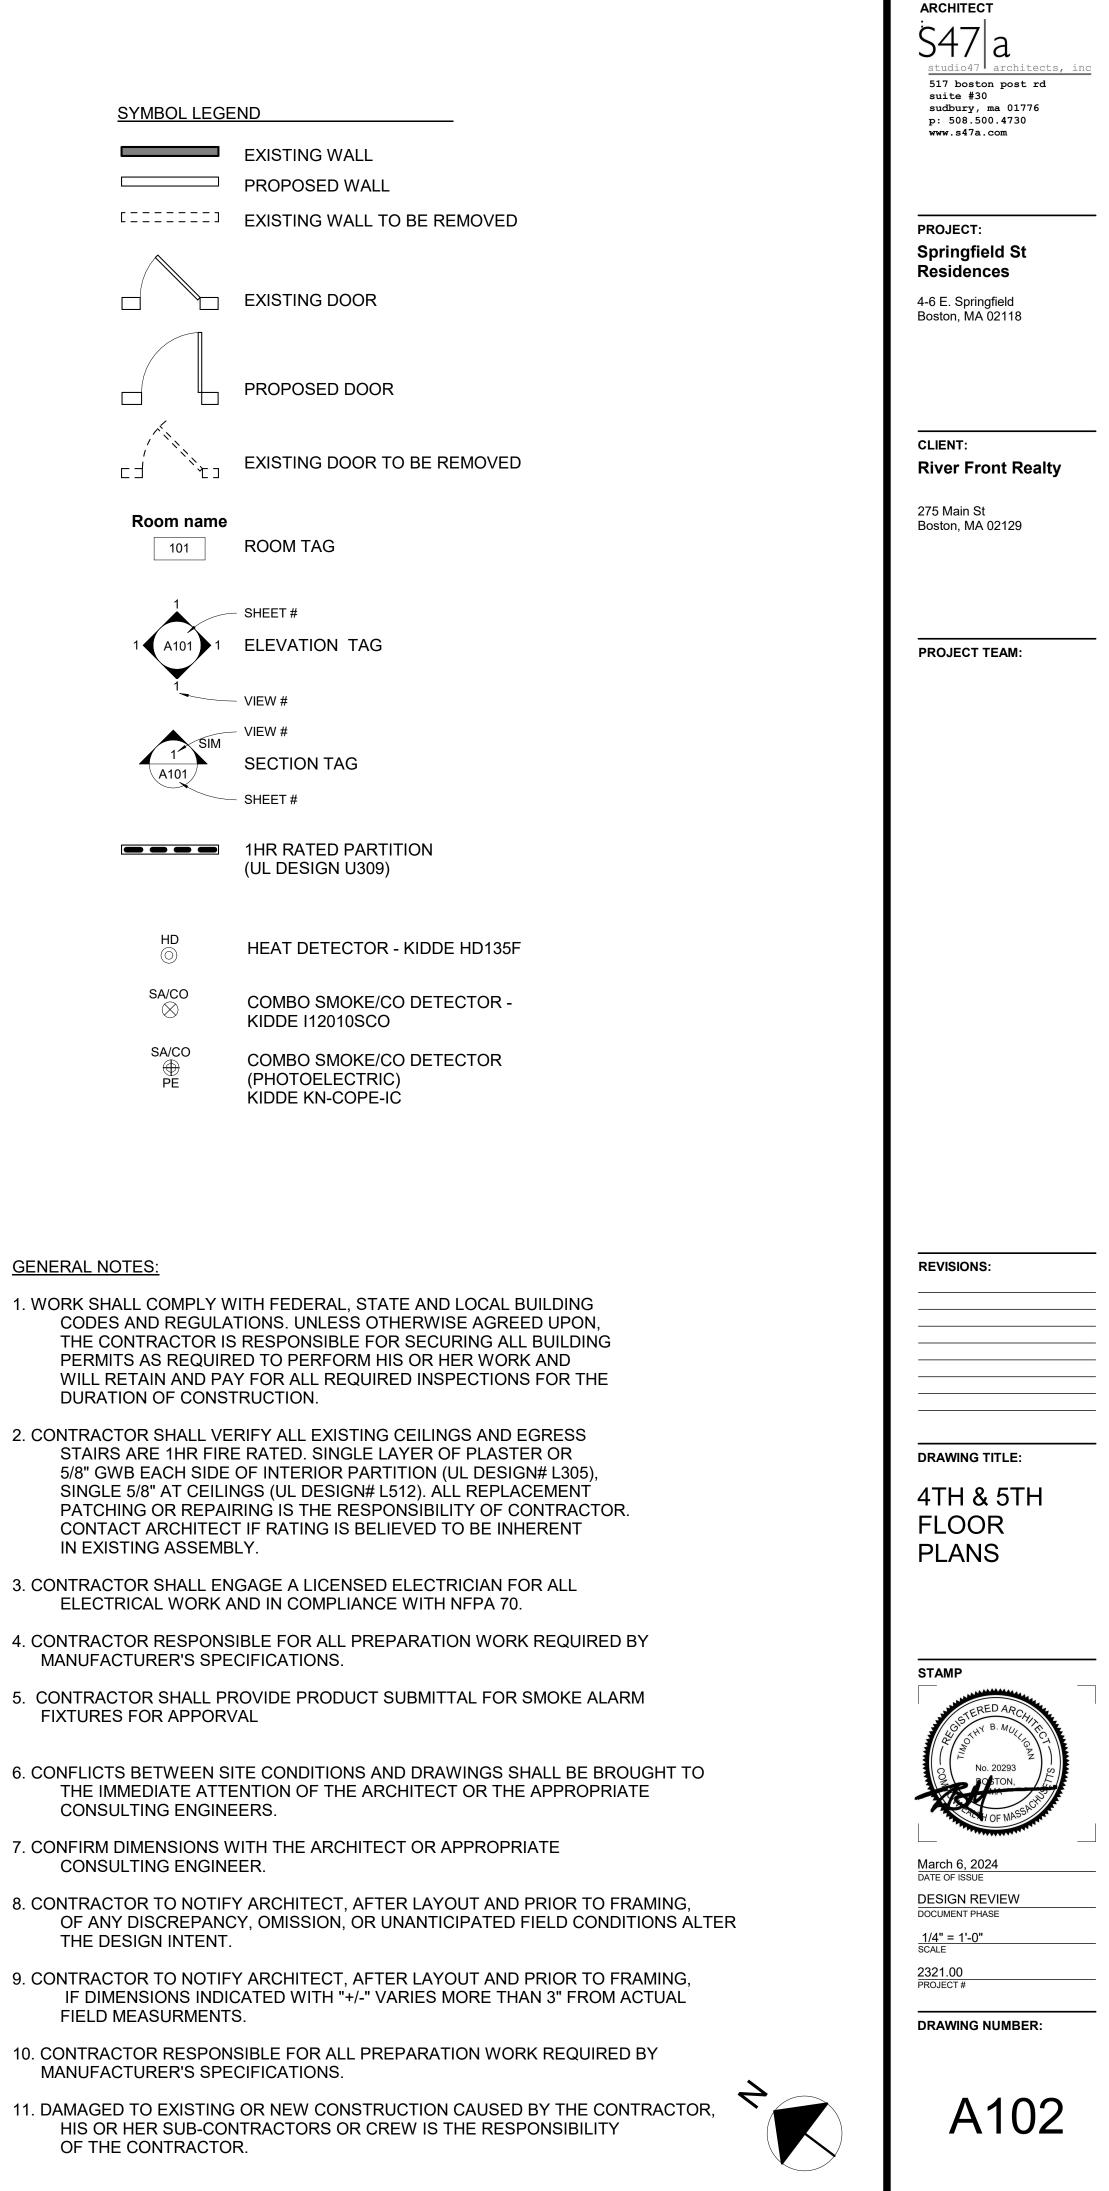


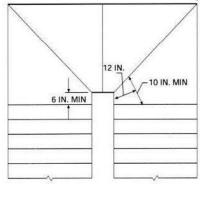


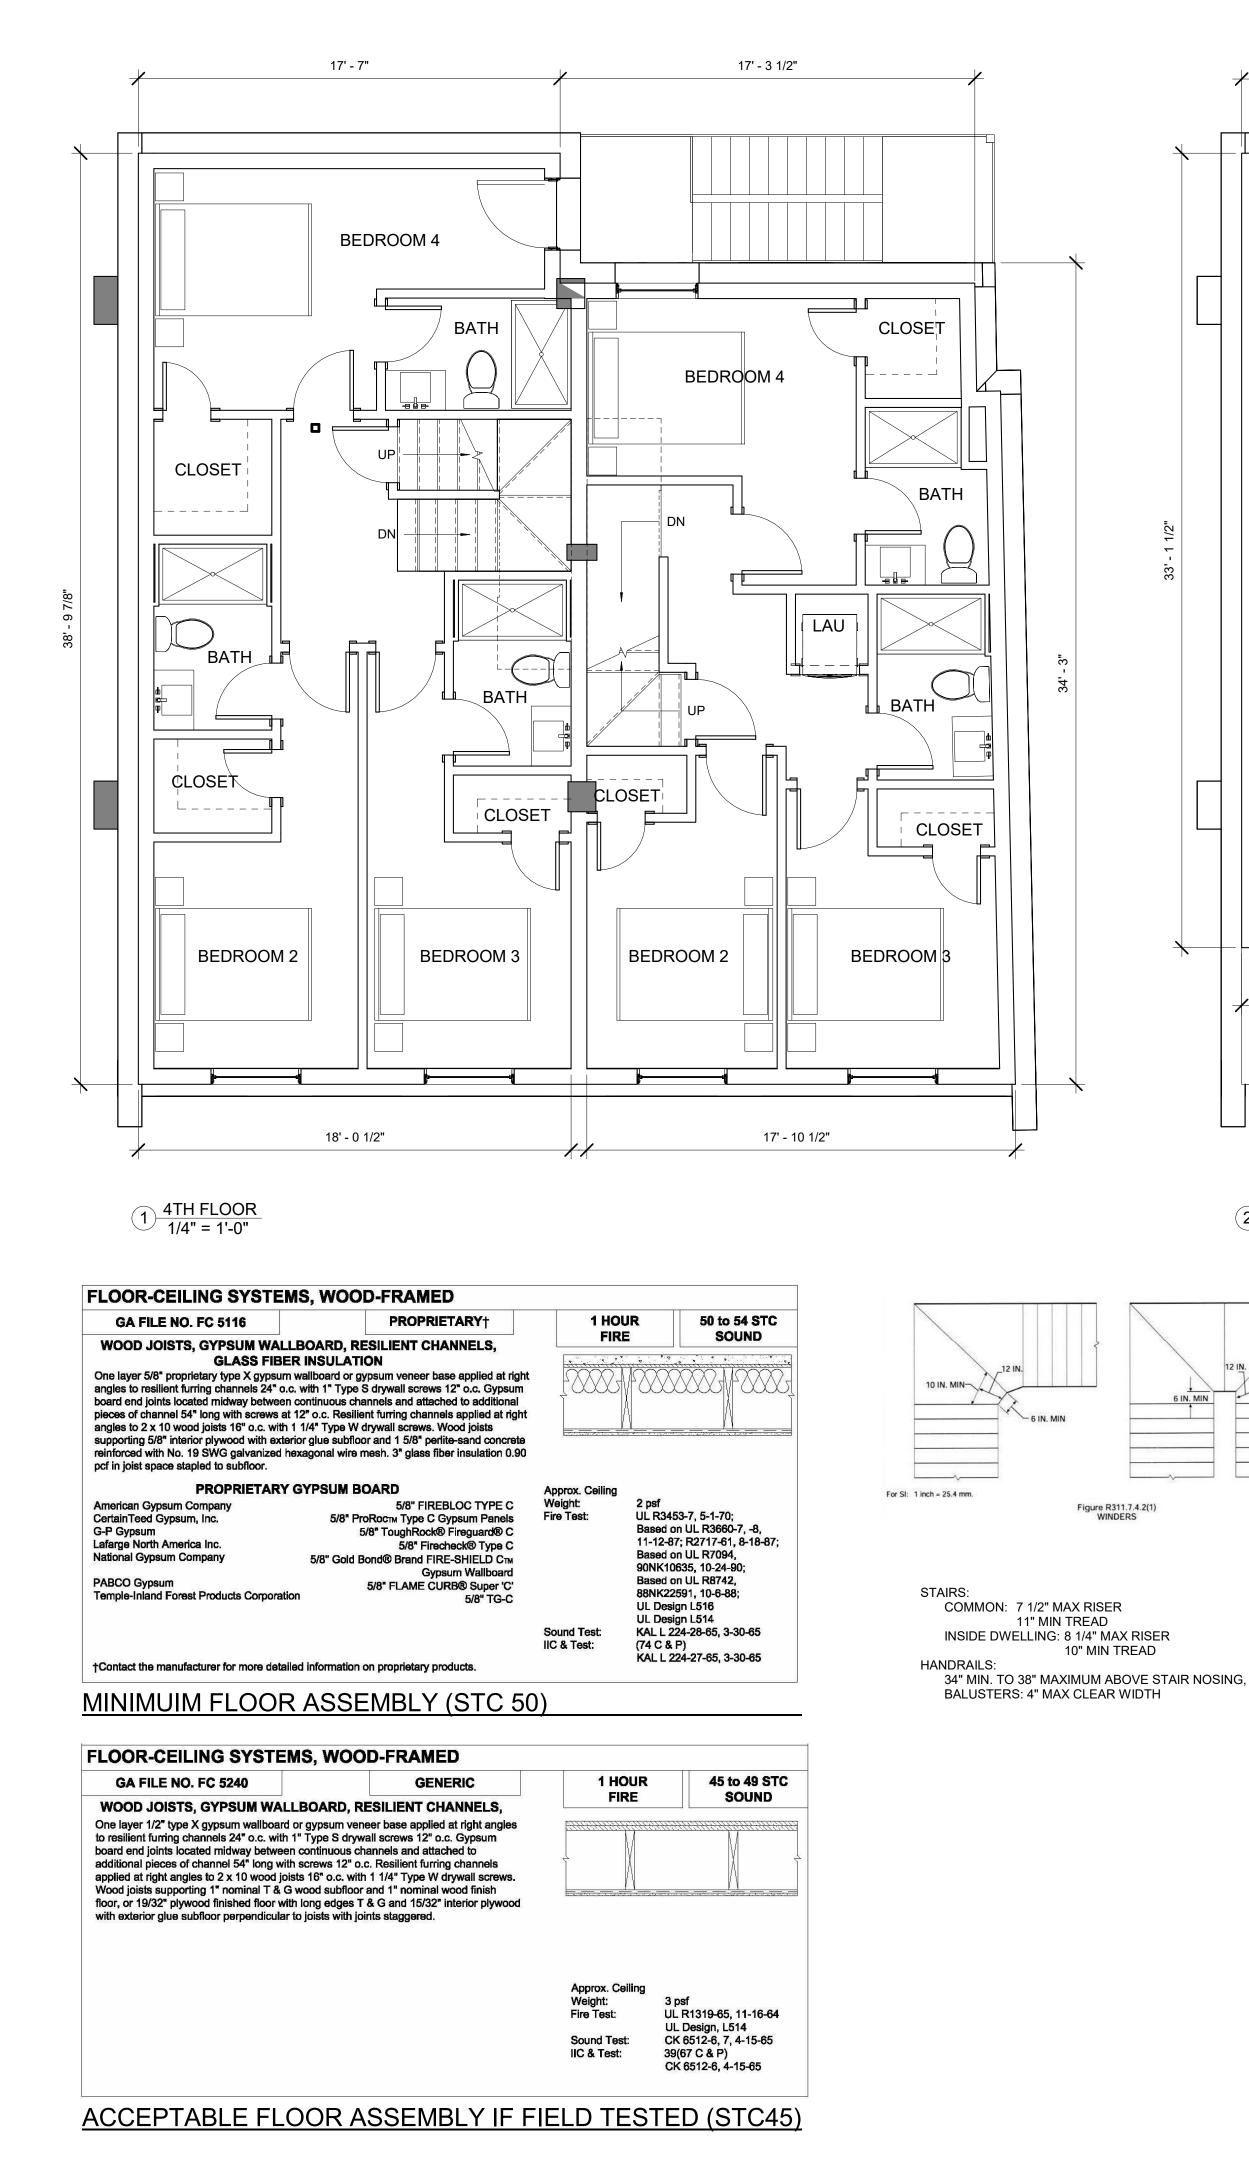(2) 5TH FLOOR 1/4" = 1'-0"

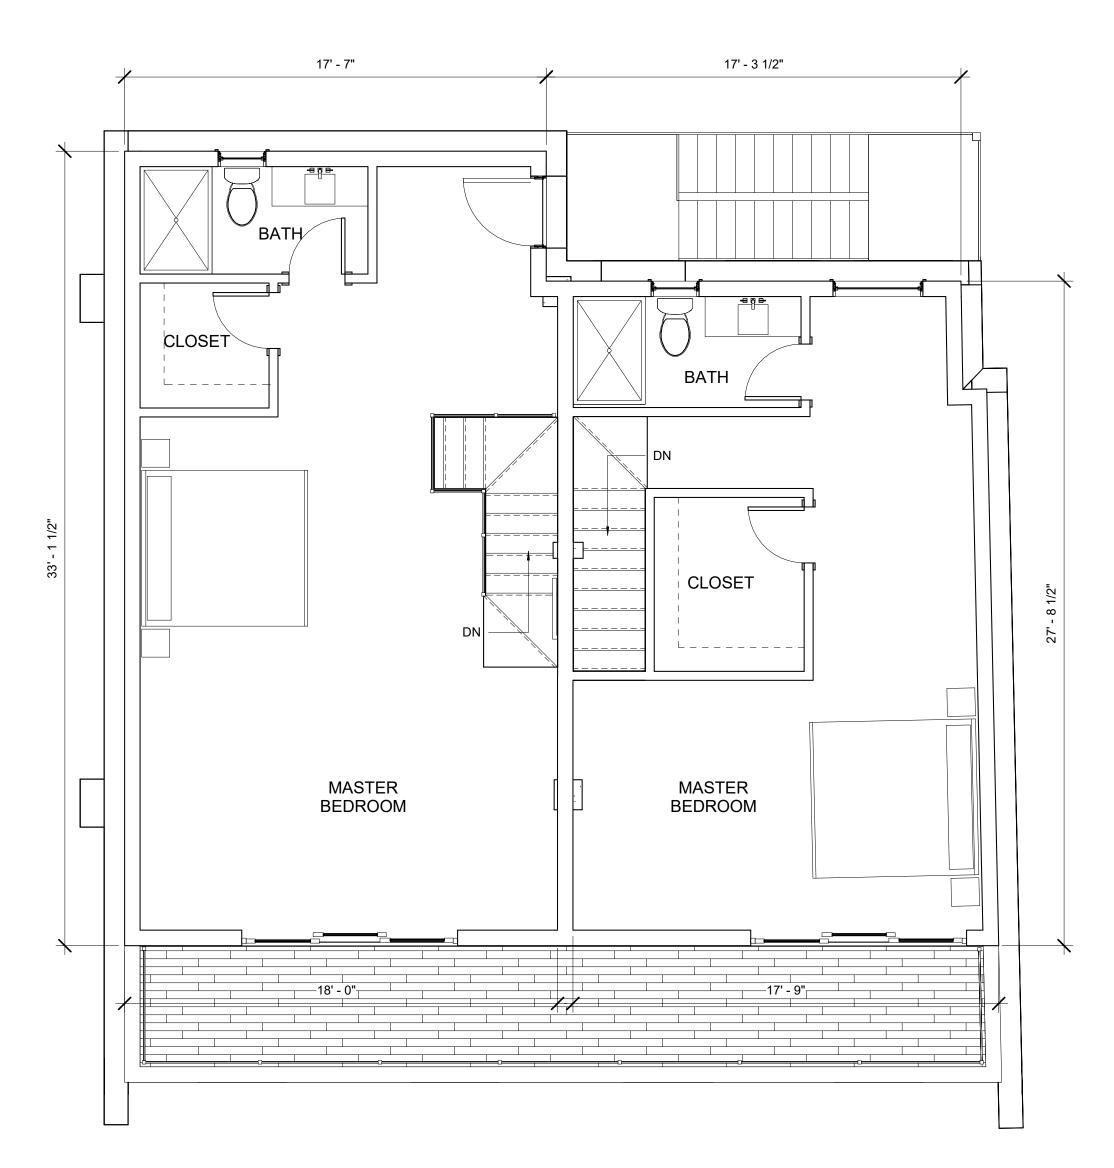

### **GENERAL NOTES:**

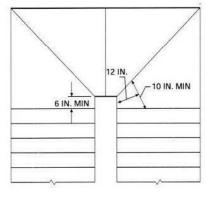

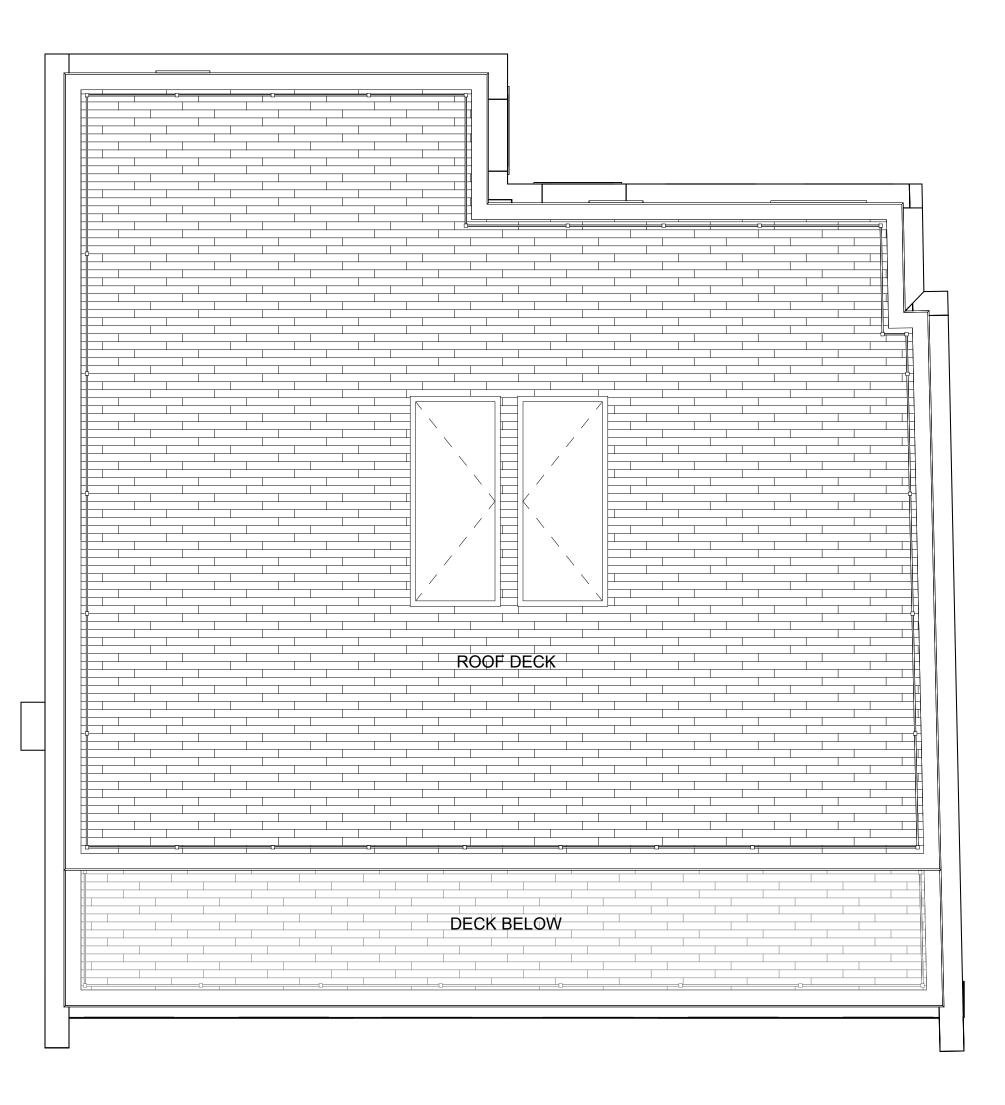

1 ROOF PLAN 1/4" = 1'-0"

A	1	0	3

DRAWING	NUMBER:

March 6, 2024 DESIGN REVIEW <u>1/4" = 1'-0"</u> SCALE 2321.00 PROJECT #

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STAMP

ROOF PLANS

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PROJECT TEAM:

4-6 E. Springfield Boston, MA 02118

**River Front Realty** 

275 Main St Boston, MA 02129


CLIENT:

PROJECT: Springfield St Residences

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ARCHITECT

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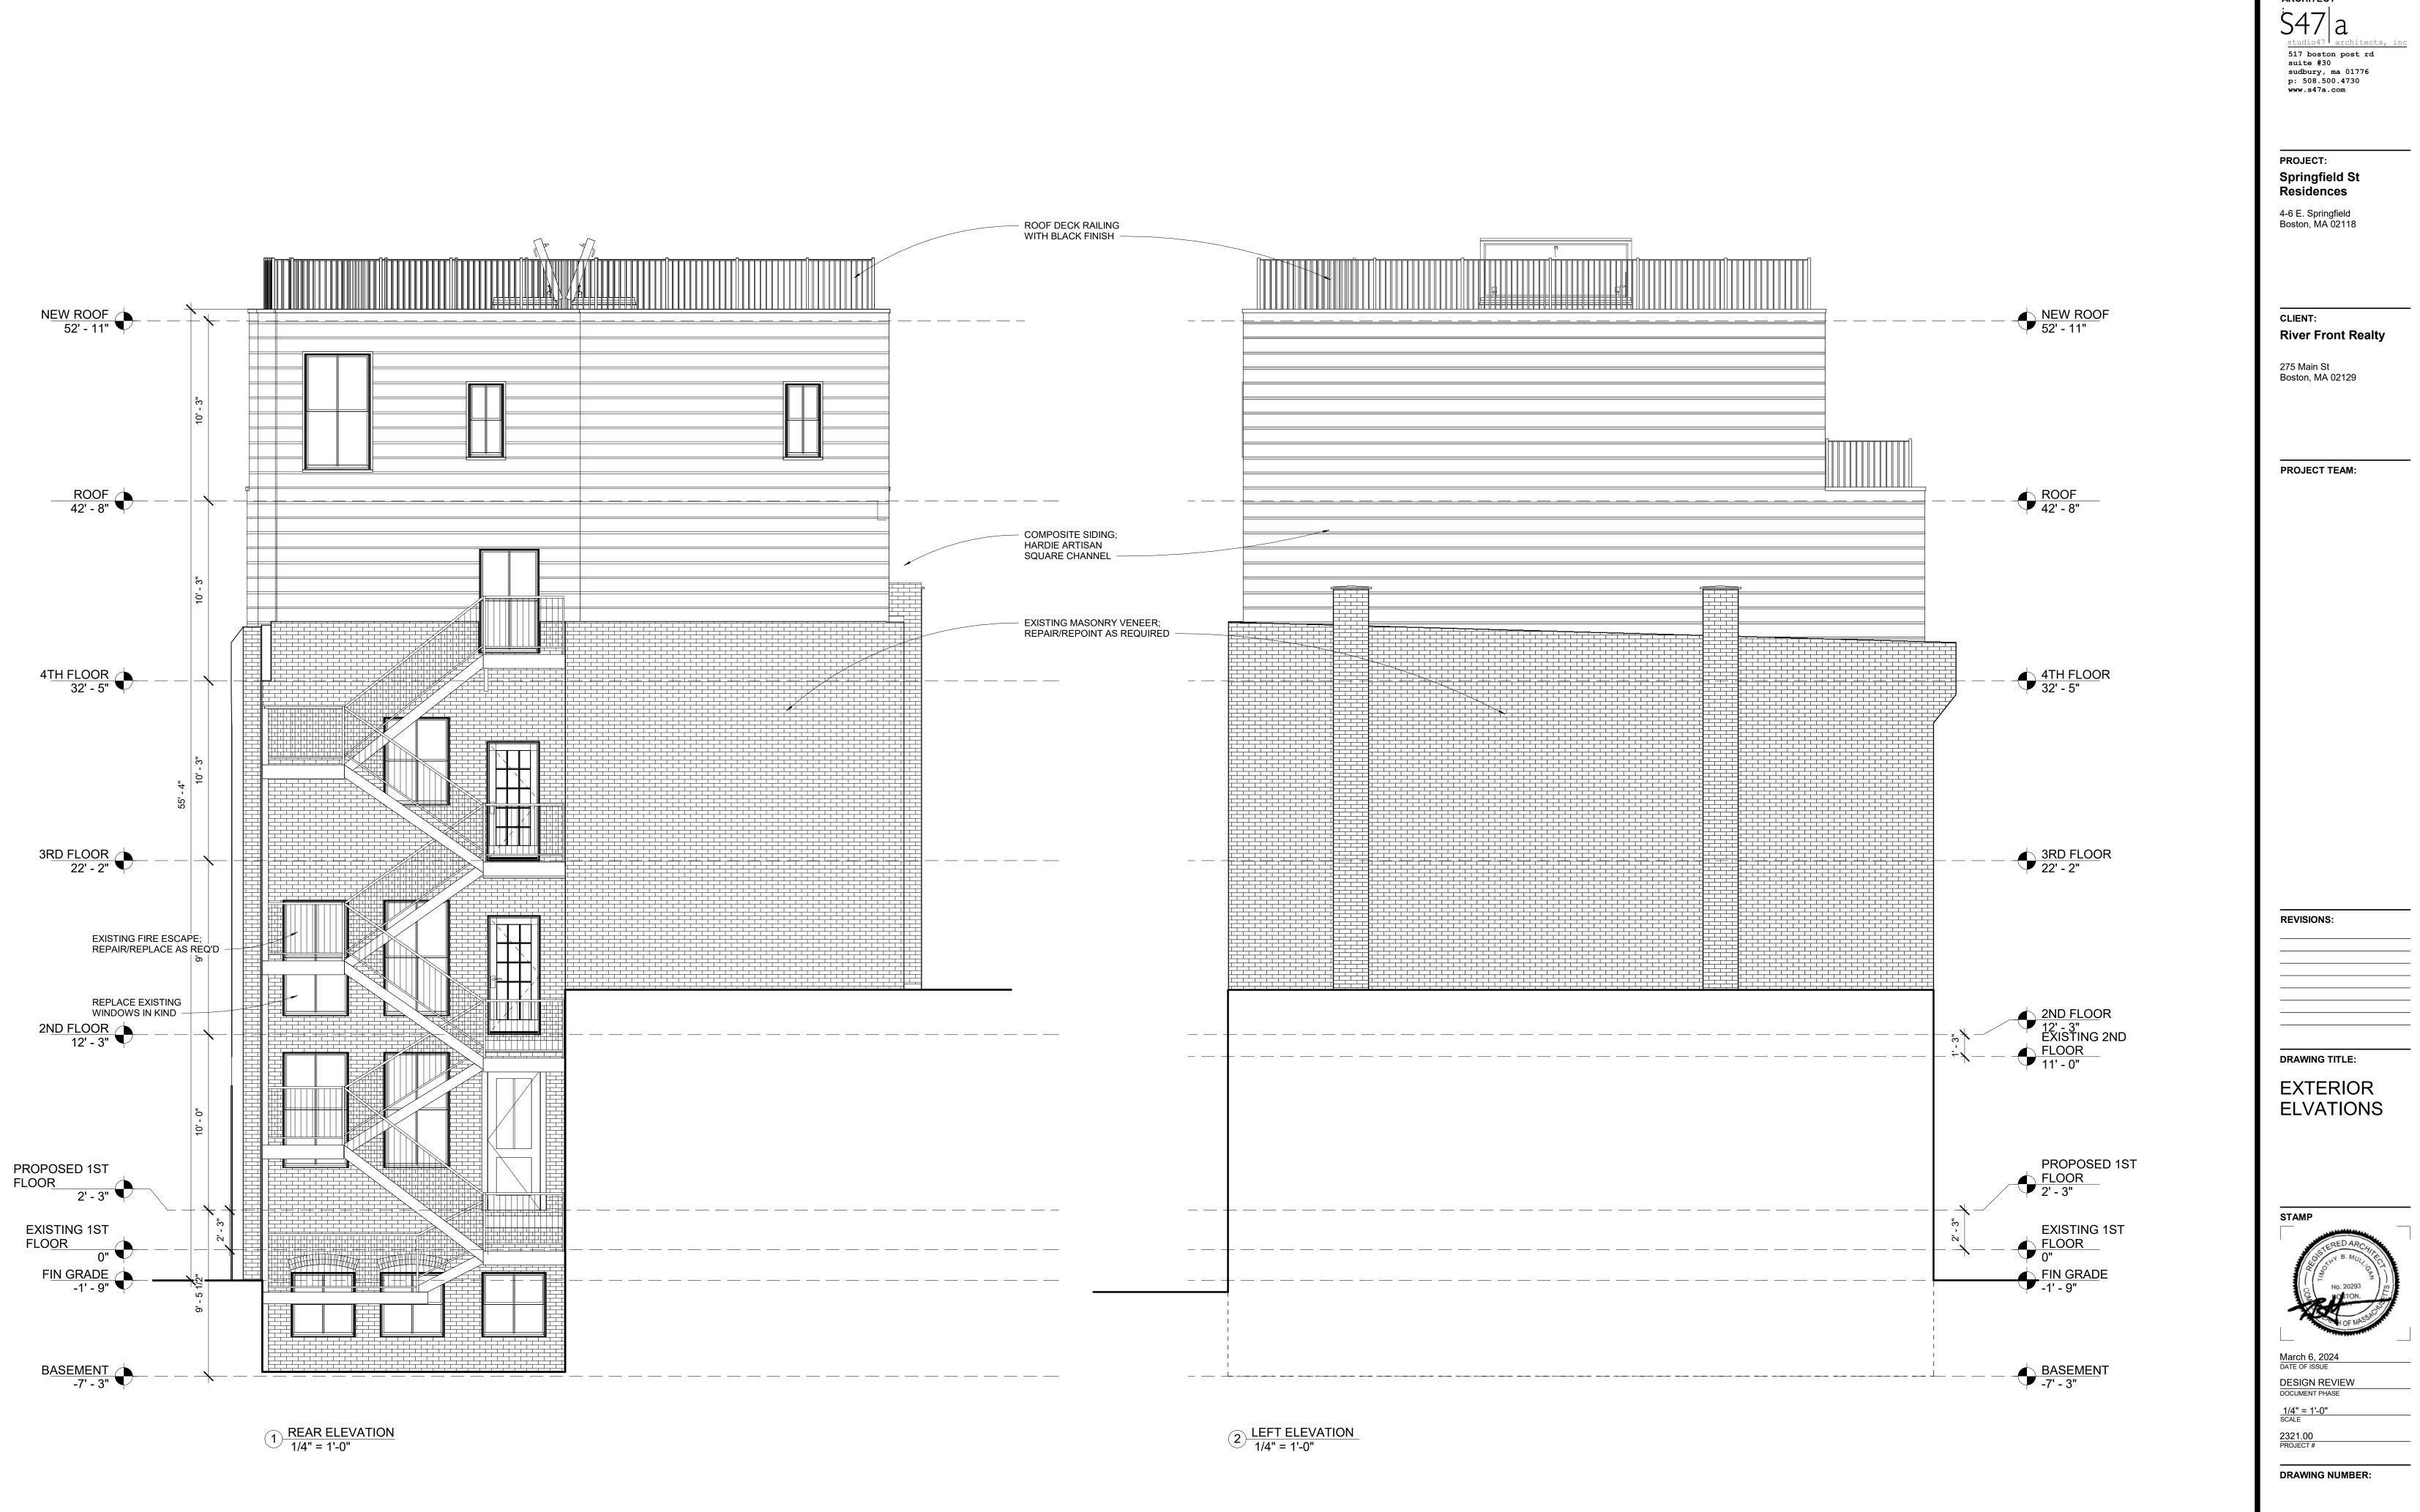


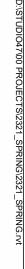

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A201