

SINGLE-FAMILY RENOVATION & ADDITIONS

18 COMMONWEALTH AVENUE, BOSTON, MA 02116

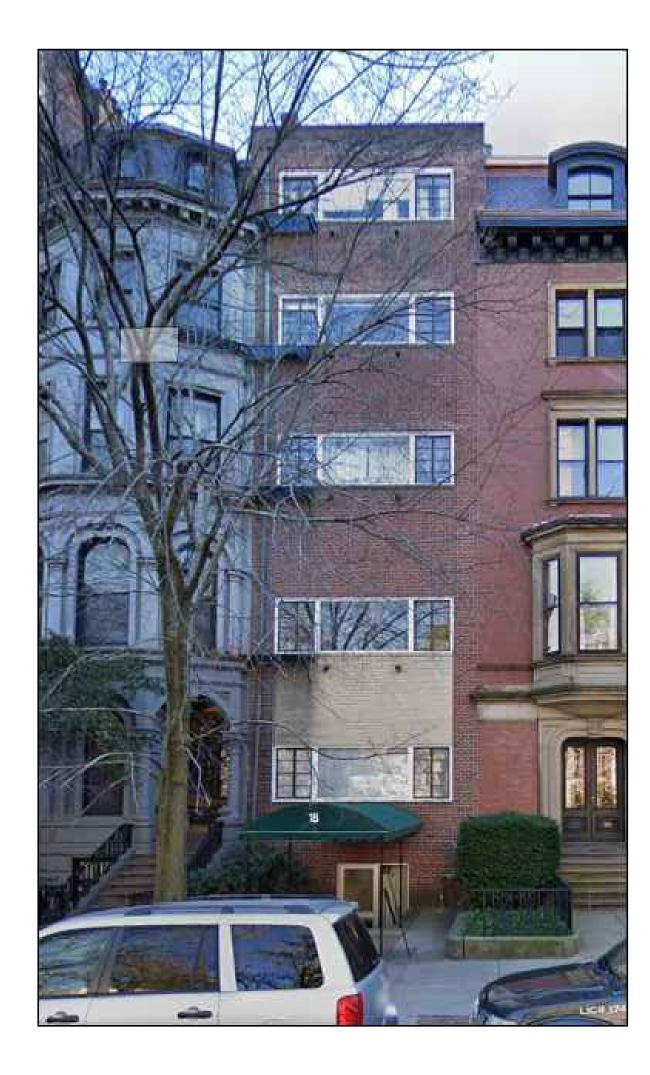

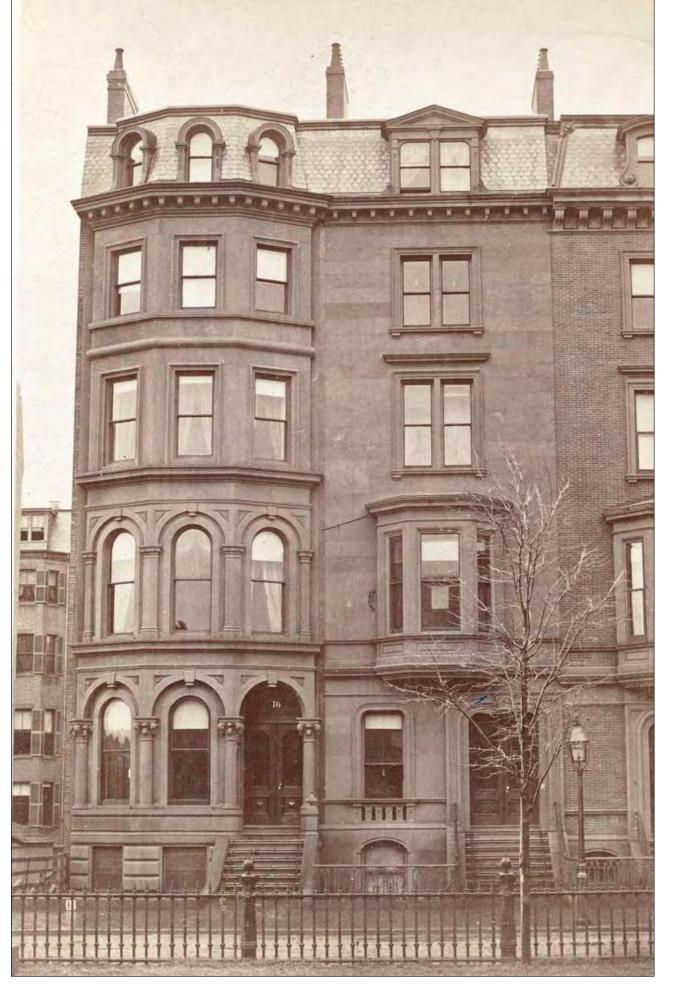

ZONING SUMMARY

ZONING CODE ANALYSIS - 18 COMMONWEALTH AVE., BOSTON

Existing	Proposed
Multi-family - 11 UNITS	Single-family - 1 UNIT

			First - all	D	
	Code Requirement		Existing Condition	Proposed Project	Notes
Any Dwelling	Use 1	Any Other Use			
Lot Area Minimum	NONE				
Min Lot Area for Additional Units	NONE				
Total Required Lot Size	NONE		2,366 SF	2,366 SF	
Min Required Lot Width and Frontage	NONE		19.0'	19.0'	
Max FAR	3.00		3.38	3.21	
Max Building Height / Stories	65'		66.0'	66.0'	
Usable Open Space	50 SF / UNIT		34 SF / UNIT	905 SF / UNIT	
Min Front Yard	20'		20'	20'	
Min Side Yard	0'		0'	0'	
Min Rear Yard	31.1'		34.4'	31.1'	
Max Use of Rear Yard					

Overlays:
GROUND WATER OVERLAY DISTRICT
GESTRICTED PARKING
GACK BAY ARCHITECTURAL DISTRICT

Other Non-Dimensional Zoning Issues:

X'G PARKING - 2 SPACES

EQUIRED - 0 SPACES

CODE SUMMARY

EX'G TYPE 3B CONSTRUCTION
EX'G MULTI-FAMILY (11 DWELLING UNITS)

PROPOSED R-3 USE GROUP (SINGLE-FAMILY)
EX'G NON-SPRINKLERED AND ALARMED

PROPOSED SPRINKLERED AND ALARMRED ZONE: MFR, SOUTH END

SOIL TESTING

NOTE: THERE HAS BEEN NO SOIL TESTING PROVIDED TO THIS OFFICE FOR THIS PROJECT. THE DESIGNING ARCHITECT OR STRUCTURAL ENGINEER ACCEPTS NO RESPONSIBILITY FOR EXISTING SOIL CONDITIONS. ANY SOIL BEARING CAPACITY OF THIS FOUNDATION SYSTEM IS DESIGNED BASED ON A 2 TON MINIMUM SOIL BEARING CAPACITY. IT SHALL BE THE CONTRACTORS OR OWNERS' RESPONSIBILITY TO DETERMINE SUITABLE SOIL CONDITIONS AND VERIFY THE BEARING PRESSURE. IF A SUITABLE SOIL THAT CAN WITHSTAND A 2 TON BEARING CAPACITY IS NOT AVAILABLE, THIS OFFICE SHOULD BE CONTACTED BY THE CONTRACTOR OR OWNER FOR A FOUNDATION REDESIGN.

KEY

SD	SMOKE DETECTOR
HD	HEAT DETECTOR
CO	CARBON MONOXIDE DETECTOR
1	1 HOUR WALL
	FAN
#	DOOR TYPE
? >	WINDOW TYPE

EX'G WALL TO REMAIN

WALL TO BE REMOVED

1 HOUR CLG. ABOVE

POSED RENOVATION

OMMONWEALTH AVEN

TON MA 02116





Revision Date

Project No:	2024121
Scale: A	S NOTED
Date: 01	I-03-2025

Drawing Name

Drawn By: DF

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Sheet No.

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GENERAL NOTES:

CONTRACTOR RESPONSIBILITY-

CONTRACTOR IS SOLELY RESPONSIBLE FOR:

- 1. VIEWING SITE AND INCLUDING ANY SPECIAL CONDITIONS NECESSARY TO PERFORM THE
- WORK AS DESCRIBED IN THE DRAWINGS. 2. ESTABLISHING CONTROL OF THE SITE VIA SURVEY, AND LAYOUT.
- 3. OBTAINING AND PAYING FOR ALL PERMITS.
- 4. PAYING FOR ALL TEMPORARY UTILITIES AND FACILITIES.
- 5. CHECKING AND CONFIRMING ALL DIMENSIONS, AND LAYOUTS.
- 6. SCHEDULING AND SEQUENCING.
- 7. CONSTRUCTION MEANS, METHODS AND TECHNIQUES 8. MAINTAINING DRAWINGS AND PERMITS ON SITE.
- 9. JOB SITE SAFETY
- 10. COORDINATION BETWEEN TRADES, AND SUPPLIERS.
- 11. PROVIDE SCHEDULE TO OWNER AND ARCHITECT,
- 12. PROVIDE A SCHEDULE OF VALUES TO THE OWNER AND ARCHITECT
- 13. TEMPORARY HEAT, ICE AND SNOWPLOWING IS THE RESPONSIBILITY OF THE CONTRACTOR.
- 14. SITE CLEANLINESS AND CONFORMANCE TO NFPA 241 REQUIREMENTS. 15. REPAIRING ANY WORK DAMAGED BY HIS FORCES WHILE PERFORMING THIS CONTRACT.
- 16. GIVING WARRANTY FOR HIS WORK FOR A PERIOD OF ONE YEAR FROM THE DATE OF FINAL COMPLETION.

REVIEW OF WORK BY DESIGNERS-

CONTRACTOR SHALL NOTIFY ARCHITECT BEFORE PROJECT STARTS.

CONTRACTOR SHALL NOTIFY ARCHITECT, ONE WEEK PRIOR TO:

17. POURING CONCRETE

18. INSULATING

19. INSTALLING DRYWALL 20. FINAL INSPECTION

SHOP DRAWINGS-

ALL SHOP DRAWINGS SHALL BE SUBMITTED 30 DAYS AFTER CONTRACT AWARD.

GENERAL CONTRACTOR SHALL APPROVE SHOP DRAWINGS, PRIOR TO SUBMITTING TO ARCHITECT OR ENGINEER.

NON SUBMISSION DOES NOT CONSTITUTE APPROVAL OF ANY WORK.

NO EXCEPTIONS TAKEN DOES NOT RELIEVE THE CONTRACTOR OF PERFORMING ANY OTHER WORK ON THE DRAWINGS.

CONTRACTOR SHALL EXPECT A MINIMUM OF 2 WEEKS FOR DESIGNERS' REVIEW TIME.

ANY VARIANCE FROM THE ORIGINAL DESIGN SHALL BE NOTED.

ANY SUBSTITUTION NOT INDICATED SHALL NOT CONSTITUTE APPROVAL OF A CHANGE.

SHOP DRAWINGS ARE NOT COORDINATION DRAWINGS.

DESIGNERS ARE NOT RESPONSIBLE FOR DIMENSIONS

CONTRACTOR TO ENSURE MATERIALS AND ASSEMBLIES ARE COMPATIBLE AND ACCEPTABLE TO THE MANUFACTURER. ALL ASSEMBLY MATERIALS SHALL BE FROM A SINGLE SOURCE AS MUCH AS POSSIBLE.

REQUEST FOR INFORMATION -

ONLY RFI'S SENT THROUGH BY THE OWNER AND AWARDING CONTRACTOR WILL BE ANSWERED. SUBCONTRACTORS MUST SUBMIT RFI'S THROUGH THE GENERAL CONTRACTOR.

BIDDING PHASE - OWNER AND AWARDING CONTRACTOR ARE RESPONSIBLE FOR COMPILING AND AGGREGATING RFI'S AND SUBMITTING TO THE ARCHITECT OR DESIGNER AT ONE TIME ONLY. ARCHITECT OR DESIGNER HAS ONE WEEK TO RESPOND. QUESTIONS MUST BE COMPLETE, NOT PIECEMEAL AND SHOULD BE SUBMITTED BY CSI DIVISION.

CHANGE ORDERS-

CONTRACTOR SHALL VISIT THE SITE AND BE THOROUGHLY ACQUAINTED WITH THE PROJECT PRIOR TO SUBMITTING A PRICE. ADDITIONAL MONEY WILL NOT BE GRANTED FOR WORK NOT CLARIFIED PRIOR TO BIDDING.

DESIGNER SHALL BE NOTIFIED OF ANY CHANGE TO THE DRAWINGS, UNFORESEEN FIELD CONDITIONS OR DISCREPANCIES PRIOR TO PERFORMING WORK.

ANY PROPOSED CHANGES SHALL BE ACCOMPANIED WITH A WRITTEN DESCRIPTION OR A SKETCH FOR CLARIFICATION.

ALL CHANGE ORDERS SHALL BE APPROVED PRIOR TO PERFORMING WORK.

CHANGE ORDERS SHALL BE PRICED EITHER LUMP SUM OR UNIT PRICE OR TIME AND MATERIALS.

ANY SUBSTITUTION REQUEST SHALL BE MADE VIA CHANGE ORDER, AND NOT VIA SHOP DRAWINGS UNLESS AGREED TO.

ANY CHANGE SHALL STATE THE CREDIT OR COST ADD AND/OR ANY CHANGE TO THE SCHEDULE.

REQUISITIONS-

ANY REQUISITION REQUIRED TO BE SIGNED BY THE ARCHITECT SHALL BE SUBMITTED A MINIMUM OF ONE WEEK PRIOR TO BEING SUBMITTED TO THE BANK FOR REVIEW.

CONTRACTOR SHALL PROVIDE RECEIPTS AND INSURANCE CERTIFICATES FOR ANY MATERIALS FOR PAYMENT FOR ANY UNINSTALLED MATERIALS.

WOOD NOTES:

- 1. ALL LUMBER SHALL HAVE A MOISTURE CONTENT OF NOT MORE
- 2. ALL FRAMING LUMBER SHALL BE #2 SPF, OR BETTER, HAVING A MINIMUM:

FB=875 PSI, FV=135 PSI, E=1,300,000 PSI.

- 3. ALL JOIST SPANS SHALL HAVE ONE ROW OF 1" X 3: CROSS BRIDGING AT MID SPAN AND NOT MORE THAN 8'-O" O.C.
- 4. ALL STUD BEARING WALLS SHALL HAVE ONE ROW OF 2X HORIZONTAL BLOCKING AT 1/2 STUD HEIGHT, AND NOT MORE THAN 6'-O" O.C. MAXIMUM.
- 5. PROVIDE AND INSTALL ALL NECESSARY TIMBER CONNECTORS WITH ADEQUATE STRENGTH.
- 6. PROVIDE DOUBLE JOIST BELOW PARTITIONS PARALLEL TO JOIST
- 7. PROVIDE SOLID BRIDGING BELOW PARTITIONS PERPENDICULAR TO JOIST FRAMING.
- 8. PROVIDE SOLID BRIDGING BETWEEN JOIST FRAMING MEMBERS WHEN BEARING ON STUD PARTITIONS OR BEAMS.
- 9. PROVIDE A CONTINUOUS BAND JOIST AT EXTERIOR STUD WALLS.
- 10. PROVIDE DIAGONAL METAL STRAP BRACING AT ALL CORNERS AND WALL INTERSECTIONS, AT THE INSIDE FACE OF STUDS, FROM TOP PLATE TO FLOOR PLATE AT A 45 DEGREE ANGLE WITH A SIMPSON TYPE "RCWB" STRAP, OR EQUAL.
- 11. ALL BUILT-UP BEAMS SHALL BE BOLTED WITH ½" Ø THRU BOLTS, MEETING A307 STANDARDS, OR, AS NOTED ON DRAWINGS.

Lintels over openings i			in bearing walls shall be as follows; or as noted on drawing			
	Span of	opening:	Size: 2x6 studs	Size: 2x4 studs		
	less than	n 4'-0"	3 - 2x4	2 - 2x4		
	up to	6'-0"	3 - 2x6	2 - 2x6		
	up to	8'-0"	3 - 2x8	2 - 2x8		
	up to	10'-0"	3 - 2x10	2 - 2x10		

DESIGN CRITERIA:

ALL WORK PERFORMED UNDER THIS CONTRACT SHALL CONFORM TO THE NINTH EDITION OF THE MASSACHUSETTS BUILDING CODE.

DESIGN LIVE LOAD = 40 POUNDS PER SQUARE FOOT

- FLOORS

- PRIVATE DECK

DESIGN SNOW LOAD = 40 POUNDS PER SQUARE FOOT WITH SNOW DRIFT

WHERE APPLICABLE WIND LOAD = 128 MILES PER HOUR

SEISMIC: $S_S = 0.217$ S1 = 0.069

ALL LUMBER SHALL BE #2 SPF, Fb= 875 PSI, Fv=135 PSI.

FOUNDATION NOTES:

- THE FOUNDATION HAS BEEN DESIGNED FOR 4000 PSF ALLOWABLE SOIL BEARING CAPACITY.
- 2. ALL BACKFILL UNDER STRUCTURAL SLABS, MATS, AND FOOTINGS WILL BE ENGINEERED BACKFILL COMPACTED IN SPECIFIC LIFTS TO 95 PERCENT OF MAXIMUM DRY DENSITY, UNLESS OTHERWISE INDICATED OR SPECIFIED.
- 3. ALL EMBANKMENTS AND BACKFILL COMPACTED IN SPECIFIED LIFTS TO 90 PERCENT OF MAXIMUM DRY DENSITY, UNLESS OTHERWISE INDICATED OR SPECIFIED.
- 4. PROVIDE SHEETING, BRACING, AND UNDERPINNING AS REQUIRED TO PRESERVE ADJACENT STRUCTURES.
- 5. FOUNDATIONS SHALL NOT BE POURED IN WATER OR ON FROZEN GROUND.
- 6. VERIFY LOCATIONS AND REQUIREMENTS FOR INSERTS, SLEEVES, CONDUITS, EMBEDMENT AND PENETRATIONS WITH RESPECTIVE TRADES BEFORE PLACING CONCRETE.
- 7. DOWELS FROM FOUNDATIONS INTO PIERS, COLUMNS, BUTTRESSES OR WALLS SHALL BE THE SAME SIZE AND NUMBER AS REINFORCEMENT IN PIERS, COLUMNS, BUTTRESSES OR WALLS ABOVE, EXCEPT AS OTHERWISE SHOWN.
- 8. CONTRACTOR SHALL PROVIDE CONTINUOUS DRAINAGE BY MECHANICAL METHODS TO CONTROL SURFACE AND UNDERGROUND WATER, AS REQUIRED DURING CONSTRUCTION.
- 9. CONTRACTOR SHALL ENSURE THAT GROUND WATER LEVELS UNDER ADJACENT STRUCTURES AND PROPERTIES ARE NOT ALTERED.
- 10. ALL FOUNDATION UNITS (PIERS) SHALL BE CENTERED SUPPORT MEMBERS, UNLESS OTHERWISE NOTED ON PLANS.
- 11. COORDINATE UNDER FLOOR AND PERIMETER DRAIN REQUIREMENTS WITH ARCHITECTURAL, CIVIL AND PLUMBING DRAWINGS AND THE REQUIREMENTS OF THE GEOTECHNICAL ENGINEER. 12. ALL BEARING MATERIALS SHALL BE INSPECTED BY THE INDEPENDENT TESTING AGENCY PRIOR TO CONCRETE PLACEMENT. THE INDEPENDENT TESTING AGENCY SHALL DETERMINE THE SUITABILITY OF THE BEARING MATERIAL. FOOTING ELEVATIONS SHALL BE ADJUSTED AS REQUIRED.
- 13. BOTTOM OF ALL EXTERIOR FOOTINGS SHALL BEAR A MINIMUM OF 4'-0" BELOW FINAL FINISHED GRADE FOR FROST PROTECTION.
- 14. FOUNDATION WALLS THAT RETAIN EARTH SHALL BE BRACED AGAINST BACKFILLING PRESSURES UNTIL FLOOR & SLAB AT TOP AND BOTTOM ARE IN PLACE
- 15. WHERE FOUNDATION WALLS ARE TO HAVE EARTH PLACED ON EACH SIDE, PLACE FILL SIMULTANEOUSLY SO AS TO MAINTAIN A COMMON ELEVATION ON EACH SIDE OF THE WALL. 16. ALL FOOTING EXCAVATIONS ARE TO BE FINISHED BY HAND
- 17. SEE THE REQUIREMENTS OF THE SPECIFICATIONS FOR BACKFILLING UNDER OR ADJACENT TO ANY PORTION OF THE BUILDING.
- 18. PROTECT IN-PLACE FOUNDATIONS, SLABS AND ADJACENT STRUCTURES, NEW CONSTRUCTION, STREET UTILITIES FROM FROST PENETRATION OR DAMAGE FROM CONSTRUCTION ACTIVITIES UNTIL THE PROJECT IS COMPLETED.
- 19. SLAB ON GRADE SHALL BEAR DIRECTLY ON A MIN. 12" THICK LAYER OF COMPACTED STRUCTURAL FILL, OR MIN. 6" THICK LAYER OF CRUSHED STONE, PLACED ABOVE PROOFROLLED AND COMPACTED EXISTING FILL, OR ABOVE UNDISTURBED NATURAL TILL. SHOULD BEDROCK BE ENCOUNTED AT OR WITHIN 12" OF BOTTOM OF SLAB, BEDROCK SHALL BE OVER EXCAVATED A MIN. OF 12" BELOW BOTTOM OF SLAB.
- 20. WHERE BEDROCK IS ENCOUNTED AT OR WITHIN 12" OF DESIGN FOOTING GRADE, IT SHOULD BE OVER EXCAVATED A MIN. OF 12" BELOW THE BOTTOM OF PROPOSED FOOTING. BEDROCK EXCAVATIONS SHOULD EXTEND A MIN. OF 12" BEYOND FOOTING EDGE. LOOSE ROCK PIECES SHOULD BE REMOVED WITHIN THE FOOTING BEARING ZONE, AND OPEN BEDROCK JOINTS SHOULD BE CHOKED WITH CRUSHED STONE OR FILLED WITH CONCRETE PRIOR TO PLACING THE SOIL CUSHION.

CONCRETE NOTES:

- 1. ALL CONCRETE SHALL ATTAIN A MINIMUM COMPRESSIVE STRENGTH OF:
- 3000 PSI FOR FOUNDATION WALL, EXTERIOR WALLS AND
- OTHER VERTICAL CONCRETE SURFACES EXPOSED TO THE WEATHER 2. MAXIMUM SLUMP SHALL NOT EXCEED 3"; AND MAXIMUM; COARSE AGGREGATE SIZE SHALI NOT EXCEED 3/4" IN DIAMETER.

REINFORCING NOTES:

- 1. ALL REINFORCEMENT, EXCEPT FOR TIES AND STIRRUPS, SHALL CONFORM TO ASTM 615-60.
- 2. ALL REINFORCEMENT FOR TIES AND STIRRUPS SHALL CONFORM TO ASTM 615-40.
- 3. ALL WELDED WIRE FABRIC SHALL CONFORM TO ASTM A185-70 SPECIFICATIONS.
- 4. ALL REINFORCEMENT SHALL BE INSPECTED AND APPROVED BY THE ARCHITECT OR HIS ENGINEER PRIOR TO THE PLACEMENT OF ANY CONCRETE.
- 5. THE CONTRACTOR SHALL SUBMIT FOUR PRINTS OF SHOP DRAWINGS: SHOWING ALL REINFORCING DETAILS, CHAIR BARS, HIGH CHAIRS, SLAB BOLSTERS, ETC. TO THE ARCHITECT FOR HIS APPROVAL. THE CONTRACTOR SHALL RECEIVE WRITTEN APPROVED SHOP DRAWINGS FROM THE ARCHITECT OR HIS ENGINEER PRIOR TO THE FABRICATION OF REINFORCEMENT.
- 6. CLEARANCES OF MAIN REINFORCING FROM ADJACENT CONCRETE SURFACES SHALL BE AS FOLLOWS:

3 INCHES

2 INCHES

A. FOOTINGS

B. SIDES OF FOUNDATIONS WALLS. EXPOSED FACES OF FOUNDATIONS. SIDES OF COLUMNS/PIERS, SLABS

ON GRADE FROM TOP SURFACE C. INTERIOR FACES OF FOUNDATIONS, TOP REINFORCING IN SLABS EXPOSED

1-1/2 INCHES TO THE WEATHER D. TOP STEEL OF INTERIOR SLABS 1 INCHES

7. MAXIMUM DEVIATION FROM THESE REQUIREMENTS SHALL BE 1/4" OF SECTIONS 10" OR LESS, 1/2" FOR SECTIONS GREATER THAN 10".

REMOVALS NOTES:

1. DEMOLITION CONTRACTOR IS TO ARRANGE FOR SHUT OFF OF EXISTING UTILITIES. CONTRACTOR SHALL ARRANGE ALL TEMPORARY POWER.

2. ALL DEMOLISHED MECHANICAL AND ELECTRICAL ITEMS SHALL BE REMOVED INCLUDING MAIN RUNS AND SERVICE LINES TO SOURCE. ALL SYSTEM LINES ARE NOT SHOWN ON CONSTRUCTION DOCUMENTS.

3. VERIFY EXTENT OF ALL CONDITIONS OF DEMOLITION WITH FLOOR PLANS AND SCHEDULED CONSTRUCTION PRIOR TO DEMOLITION. DISCREPANCIES BETWEEN DESIGN CONDITIONS AND EXISTING CONDITIONS SHALL BE BROUGHT TO THE ATTENTION OF THE OWNER &

4. ALL WALLS, SUBSTRUCTURAL FRAMES, PARTITIONS, EQUIPMENT, ETC. INDICATED BY DASHED LINES (----) SHALL BE REMOVED. ALL MECHANICAL, ELECTRICAL, PLUMBING AND OTHER SERVICES WHICH ARE CONTAINED IN THE AREA TO BE REMOVED SHALL ALSO BE REMOVED OR REROUTED. CONTRACTOR SHALL COORDINATE ALL DEMOLITION WITH NEW CONSTRUCTION BEFORE STARTING DEMOLITION.

5. ALL EXISTING UNUSED WALL PENETRATIONS IN INTERIOR AND EXTERIOR WALLS ALONG WITH PENETRATIONS LEFT AFTER SELECTIVE DEMOLITION ACTIVITIES SHALL BE INFILLED TO MATCH ADJACENT WALL FINISHES AND THICKNESS AS DIRECTED.

6. MAINTAIN CLEAR EXIT PATHS DURING DEMOLITION AND CONSTRUCTION ACTIVITIES.

7. ALL STRUCTURAL ELEMENTS SHALL BE PROTECTED DURING DEMOLITION.

8. REMOVE ONLY NON-LOAD BEARING CONSTRUCTION AND PARTITIONS. CONTRACTOR TO VERIFY, PRIOR TO REMOVAL, THAT NO STRUCTURAL COMPONENTS, I.E. BEARING WALLS, BEAMS, HEADERS, ETC.. SUPPORTING FLOOR, ROOF OR CEILING JOISTS ARE DESIGNATED FOR REMOVAL. CONTACT THE ARCHITECT PRIOR TO REMOVAL OF ANY CONSTRUCTION IN QUESTION OR DEVIATING FROM THE DESIGN INTENT. CONTRACTOR'S NON-CONTACT OF ARCHITECT PRIOR TO REMOVAL OF ANY WORK INDICATES HIS COMPLETE UNDERSTANDING THAT NO LOAD BEARING OR STRUCTURAL WORK IS BEING ALTERED UNDER THIS CONTRACT.

9. WHERE APPLICABLE LEVEL ALL EXISTING FLOORS AS REQUIRED TO RECEIVE NEW FLOOR FINISHES. INSTALL REQUIRED TRANSITION PIECES BETWEEN VARIOUS FLOOR FINISHES SUITABLE FOR CONDITIONS AND ACCEPTABLE TO THE OWNER.

10. PROTECT ALL EXISTING STRUCTURE, SYSTEMS, FINISHES AND GENERAL CONSTRUCTION THAT ARE TO REMAIN THROUGHOUT THE COURSE OF THE WORK TO PREVENT DAMAGE OR LOSS. ANY SUCH DAMAGE CAUSED DURING THE COURSE OF THIS WORK WILL BE REPAIRED AT THE CONTRACTOR'S EXPENSE BEFORE THIS WORK IS CONCLUDED.

11. CONTRACTOR IS TO VERIFY UTILITY LINE LOCATIONS AND MAINTAIN THOSE THAT SERVE OTHER PARTS OF THE BUILDING THAT ARE NOT AFFECTED BY THE DEMOLITION.

12. ALL WORK WILL BE PERFORMED IN THE BEST WORKMANSHIP

POSSIBLE IN ACCORDANCE WITH THAT TRADE'S BEST INDUSTRY

STANDARDS.

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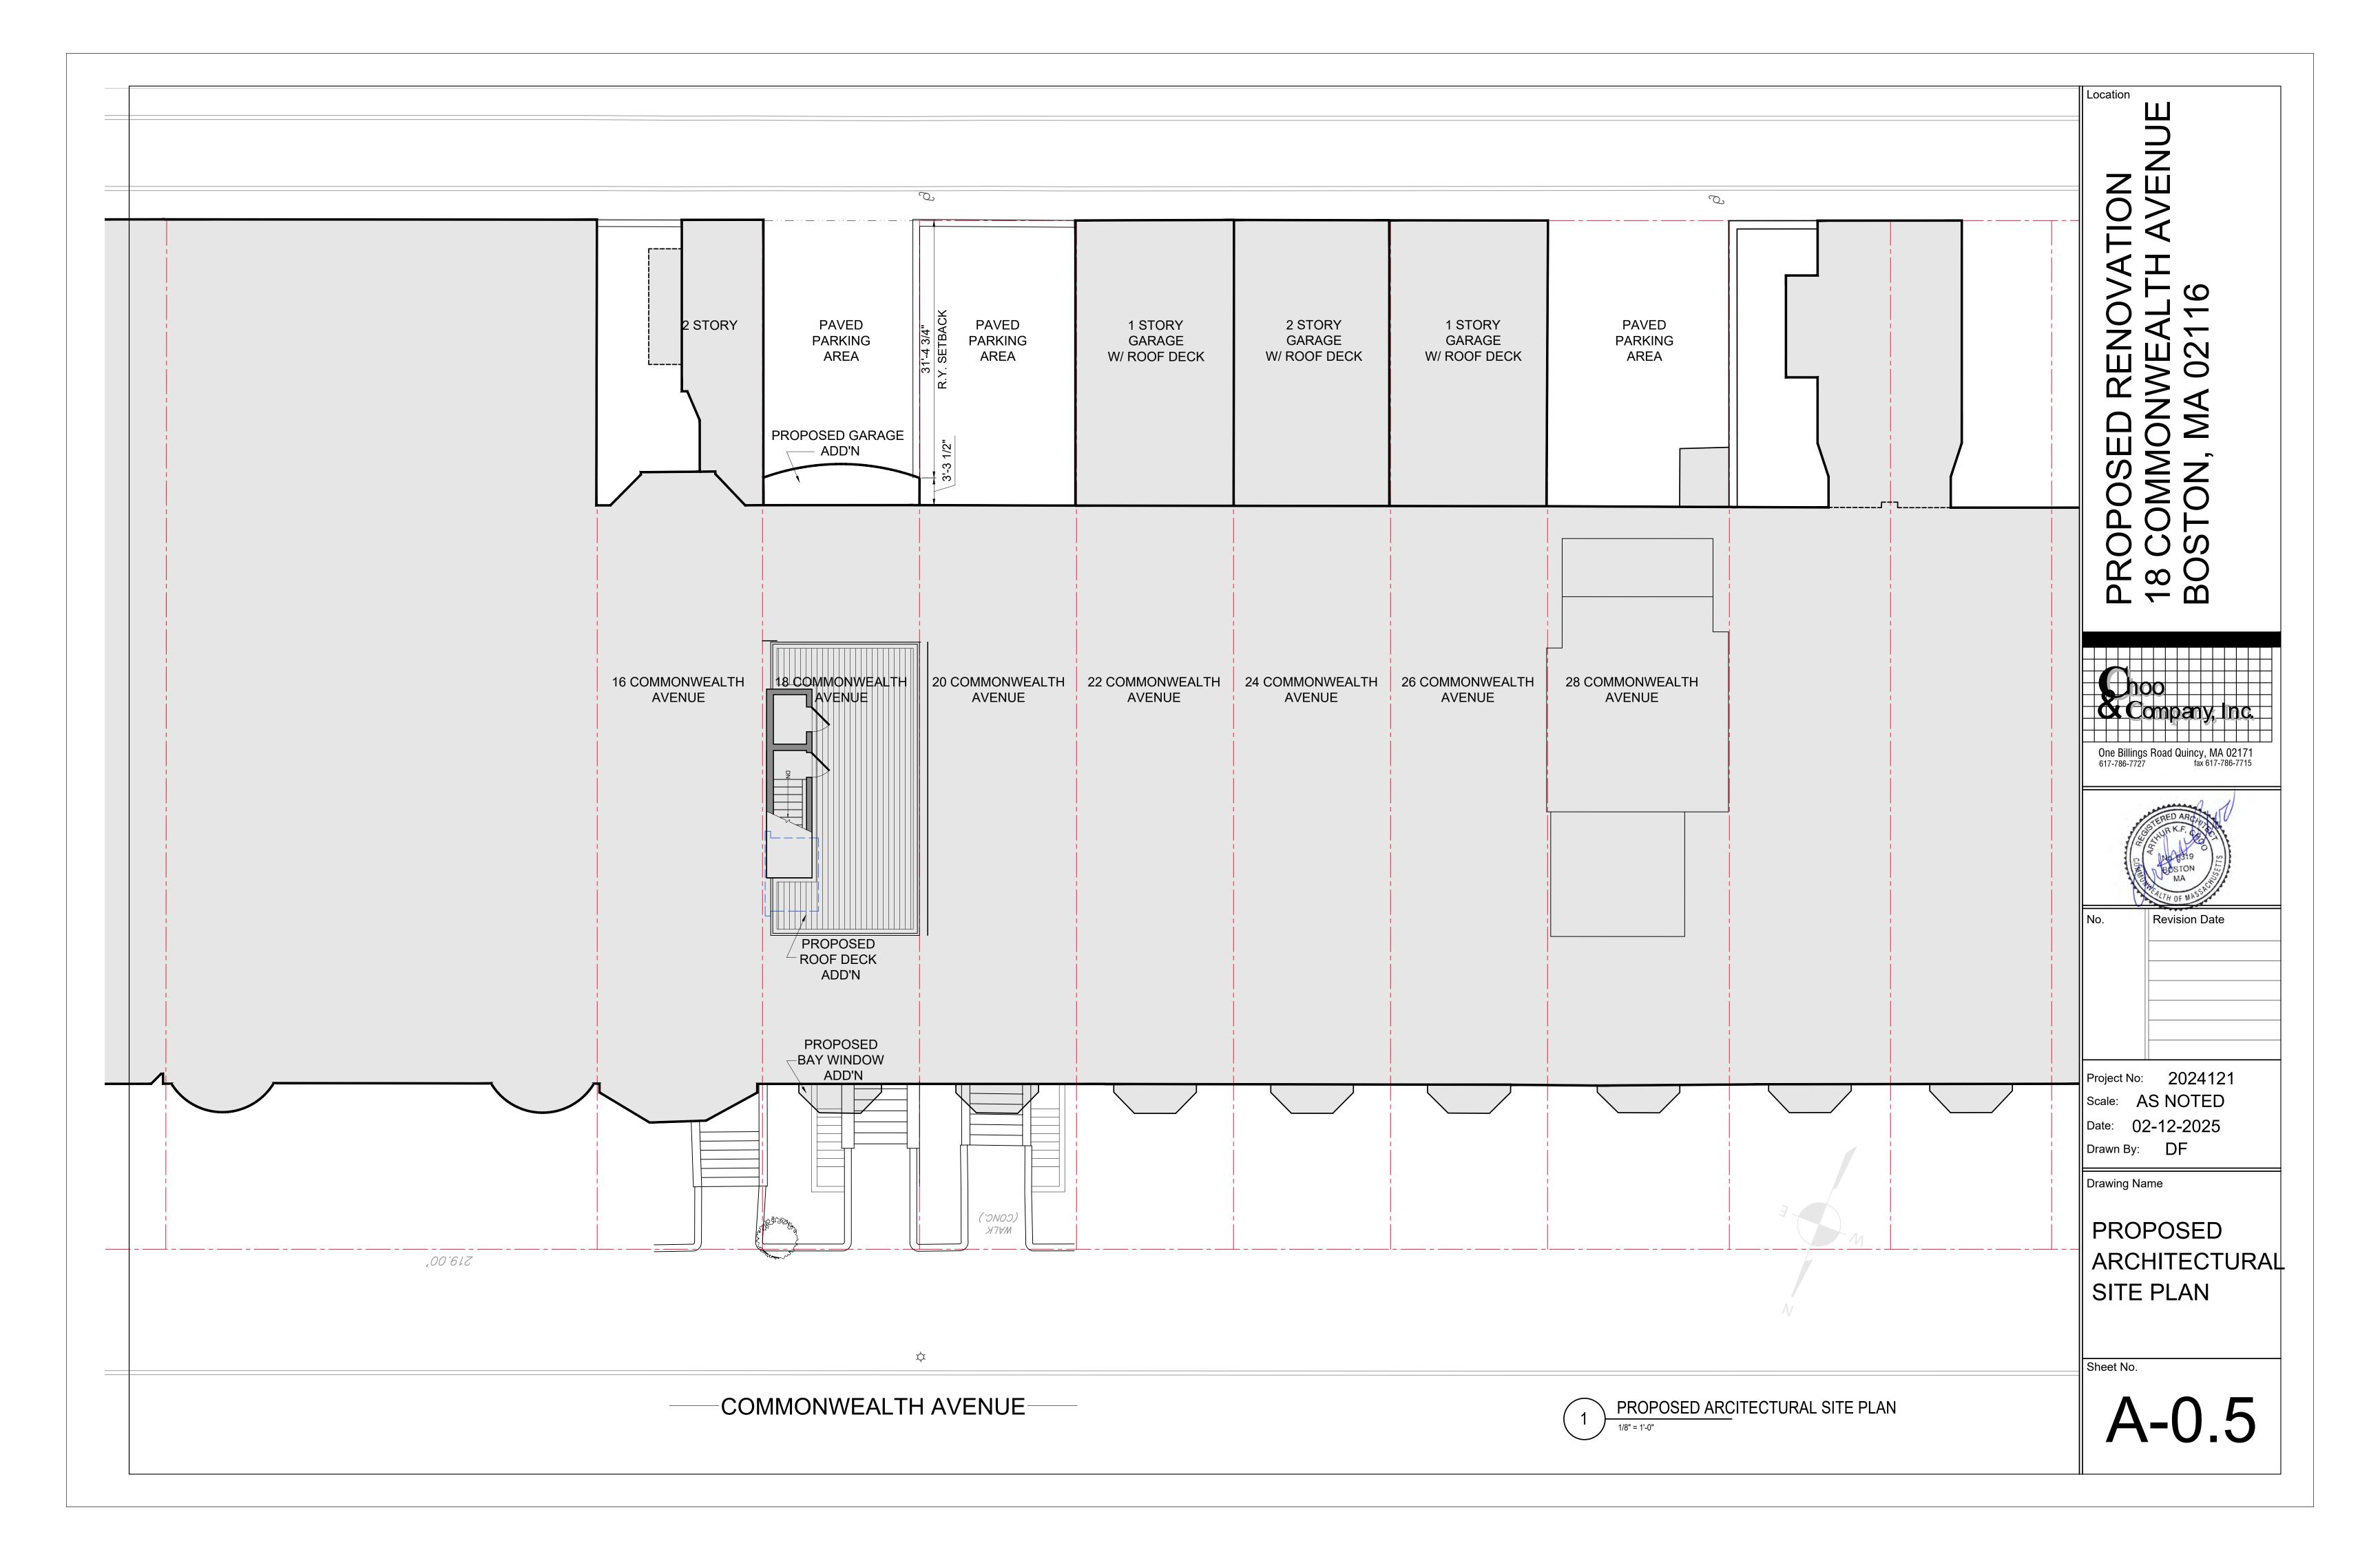
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Project No: 2024121 Scale: AS NOTED Date: 02-12-2025 Drawn By:

GENERAL NOTES

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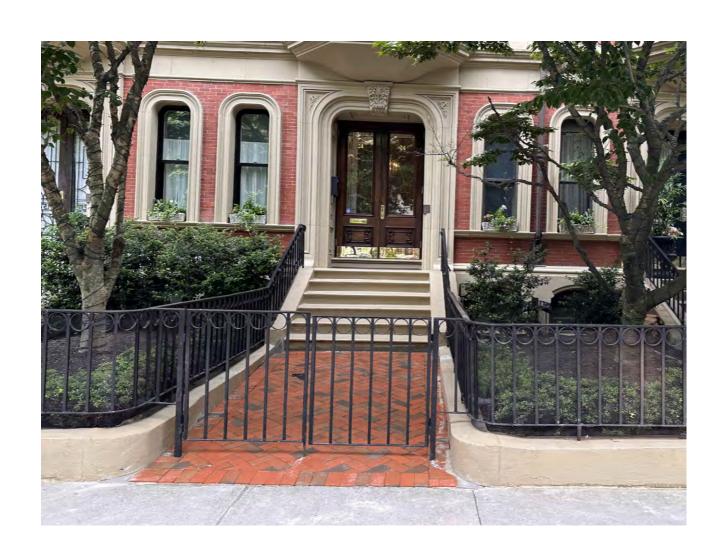





EXISTING FRONT ENTRANCE & GARDEN




20 COMMONWEALTH FRONT ENTRANCE & GARDEN




TYPICAL FRONT GARDEN, FENCING & PAVING

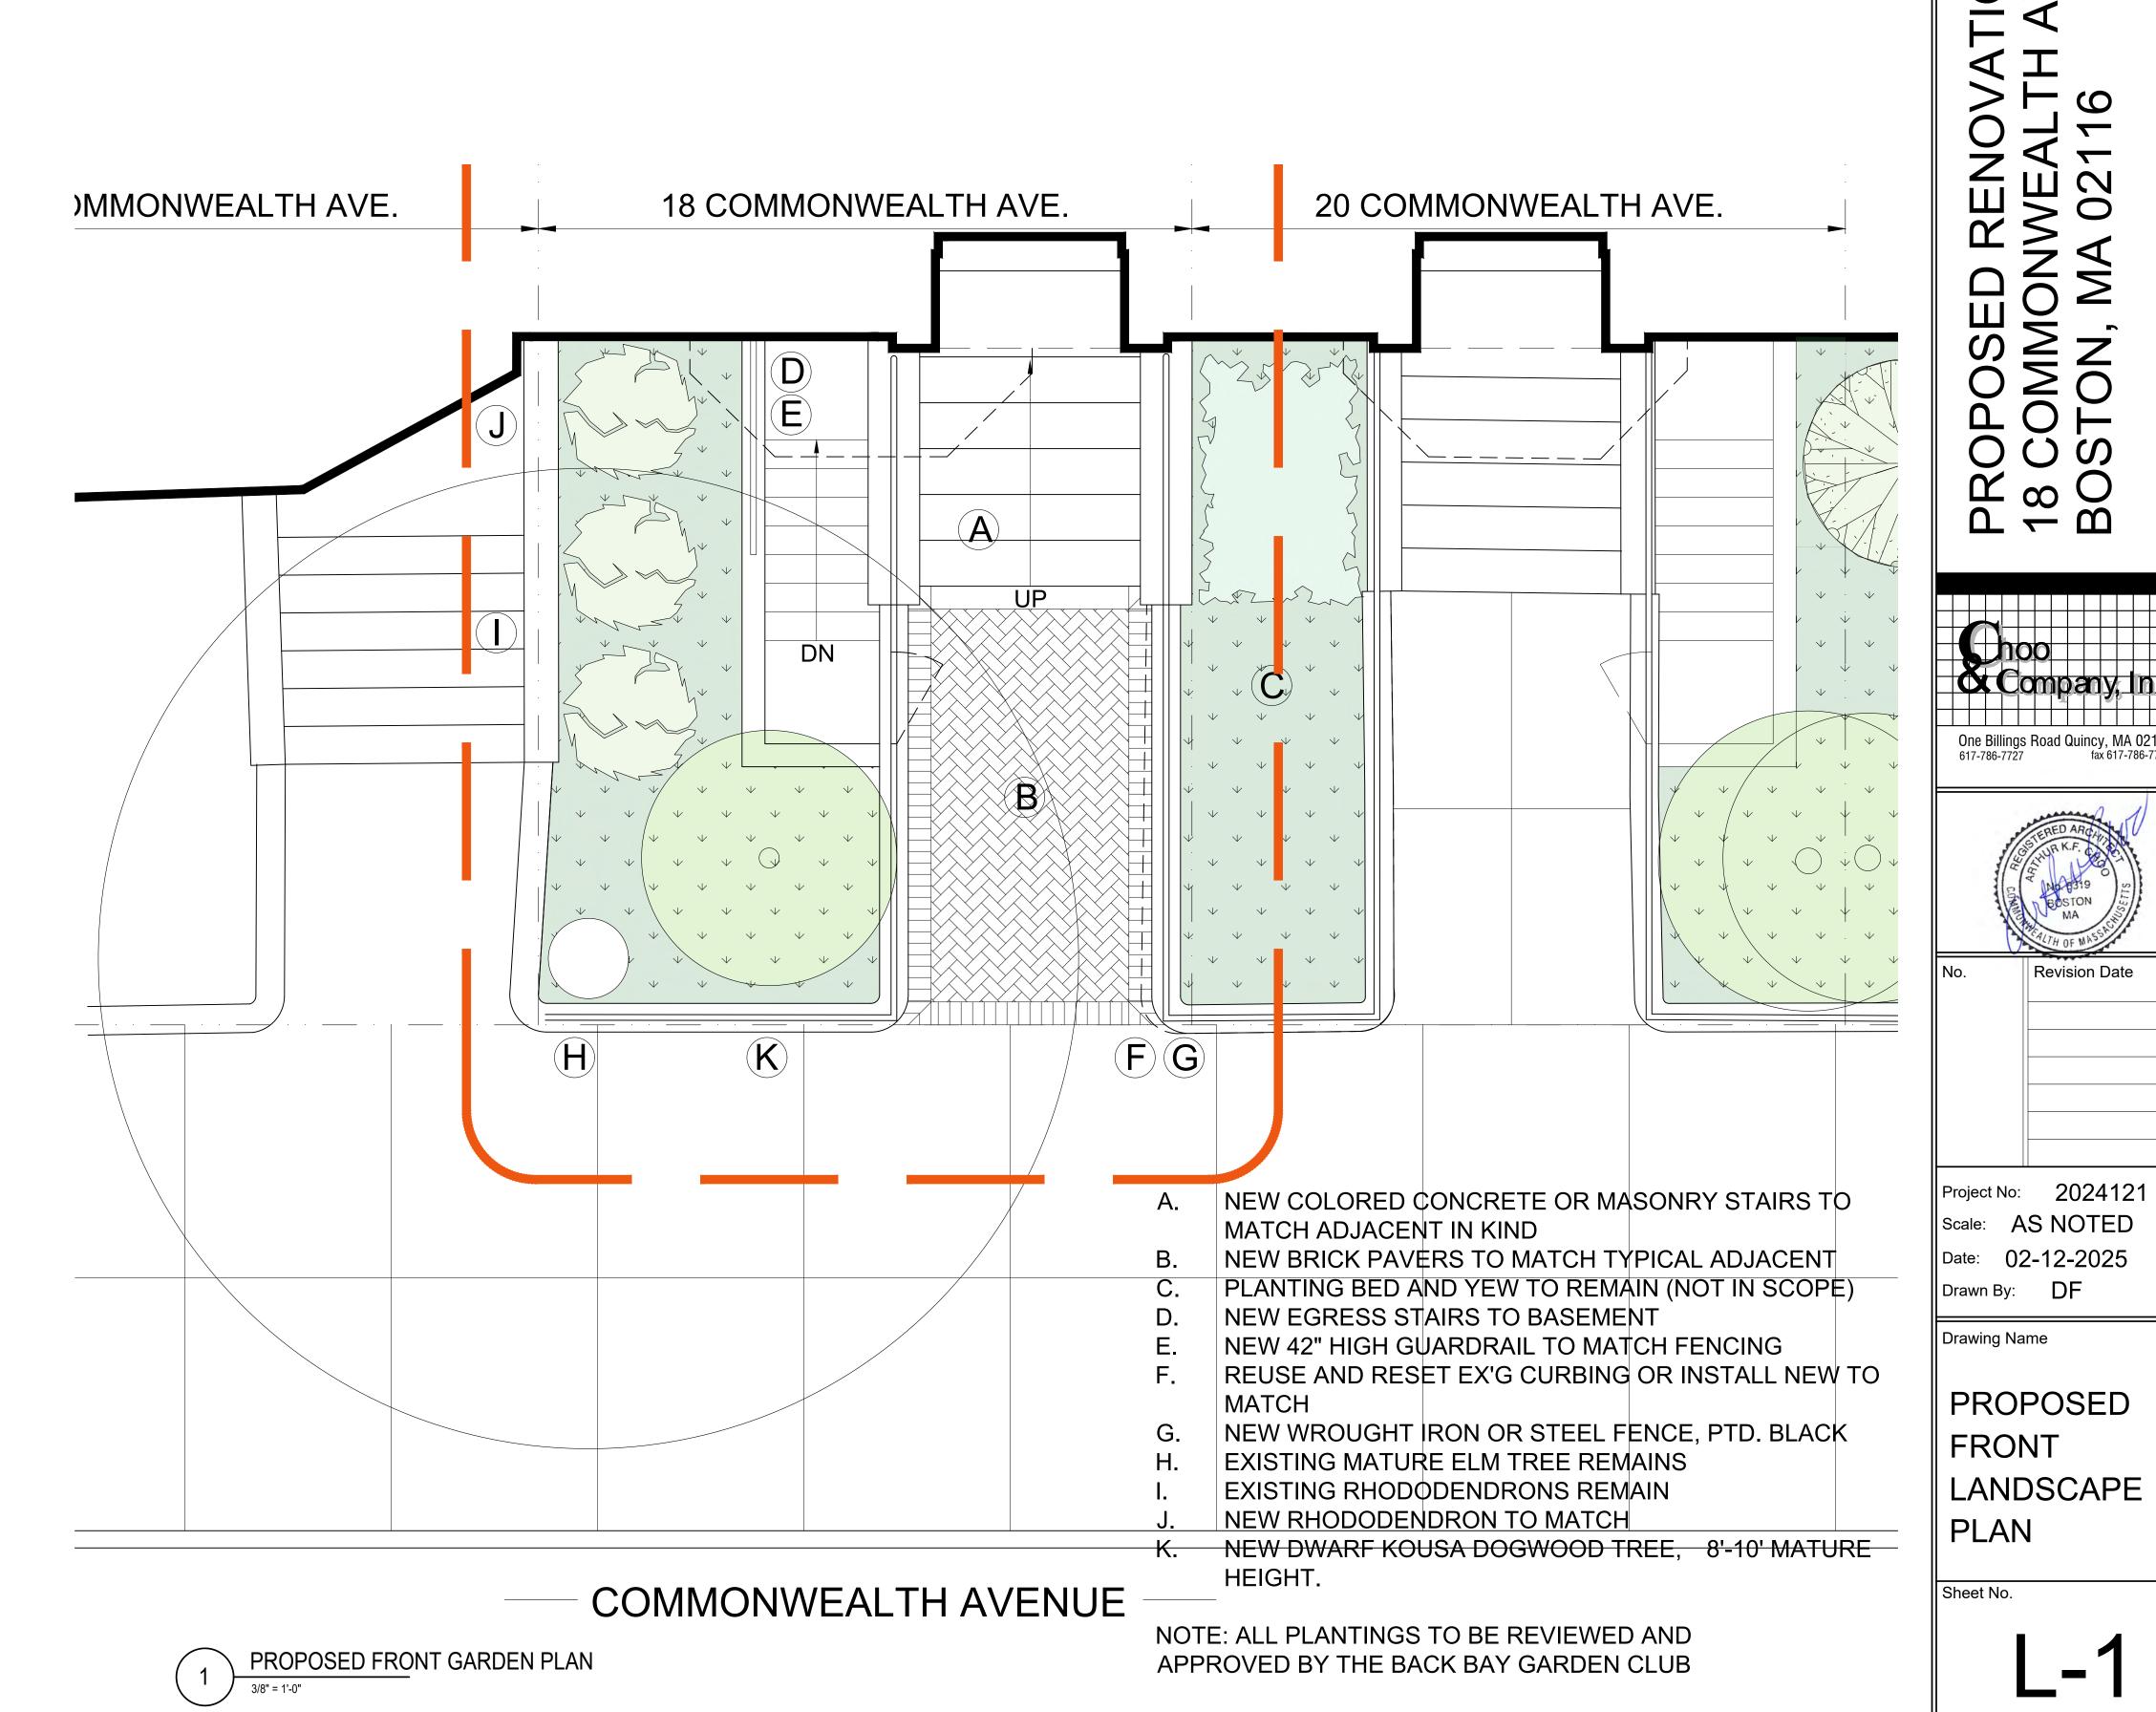

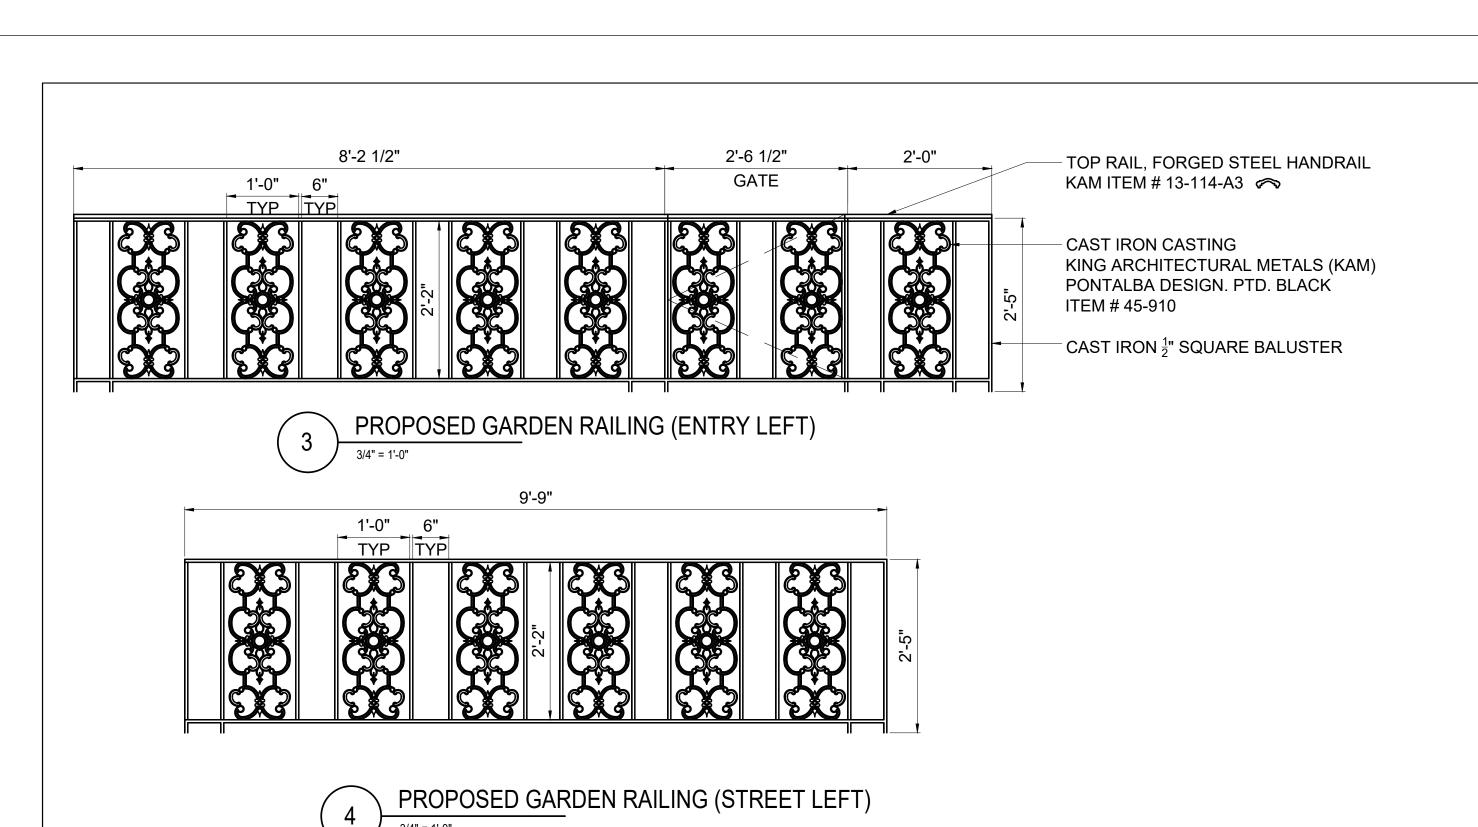


ALL NEW RAILING COMPONENTS TO MATCH EX'G ADJACENT. GC TO INFORM ARCHITECT IF ANY OF THESE SPECIFIED COMPONENTS ARE NOT AN EXACT MATCH

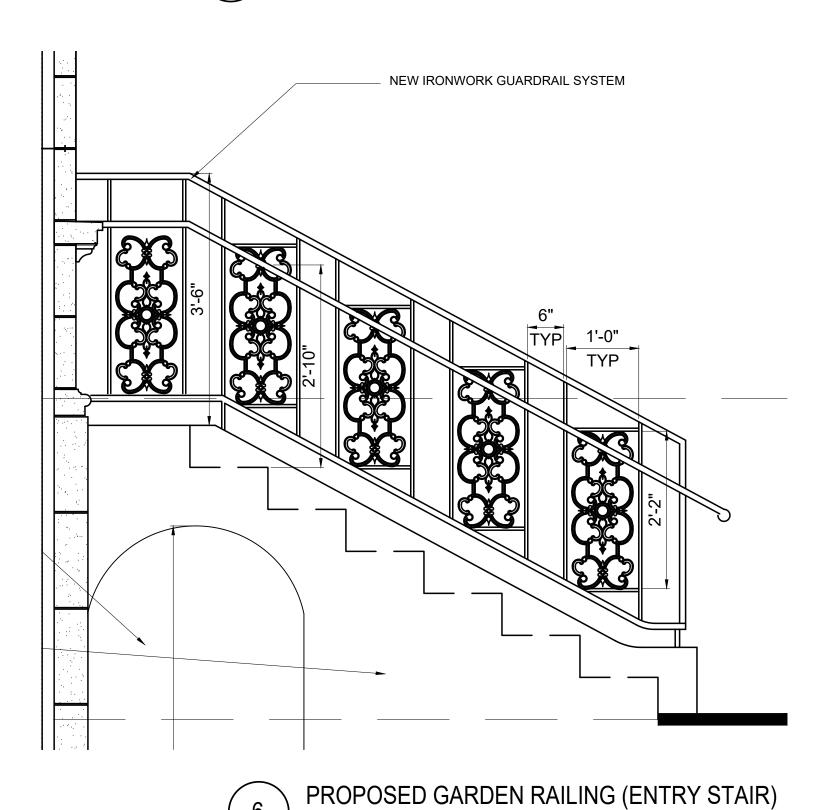


1'-0" 6" TYP TYP


PROPOSED GARDEN RAILING (STREET RIGHT)

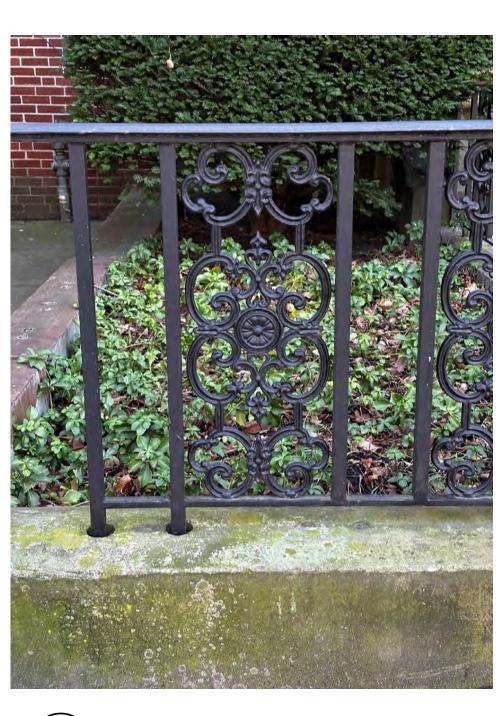


PROPOSED GARDEN RAILING EXAMPLE

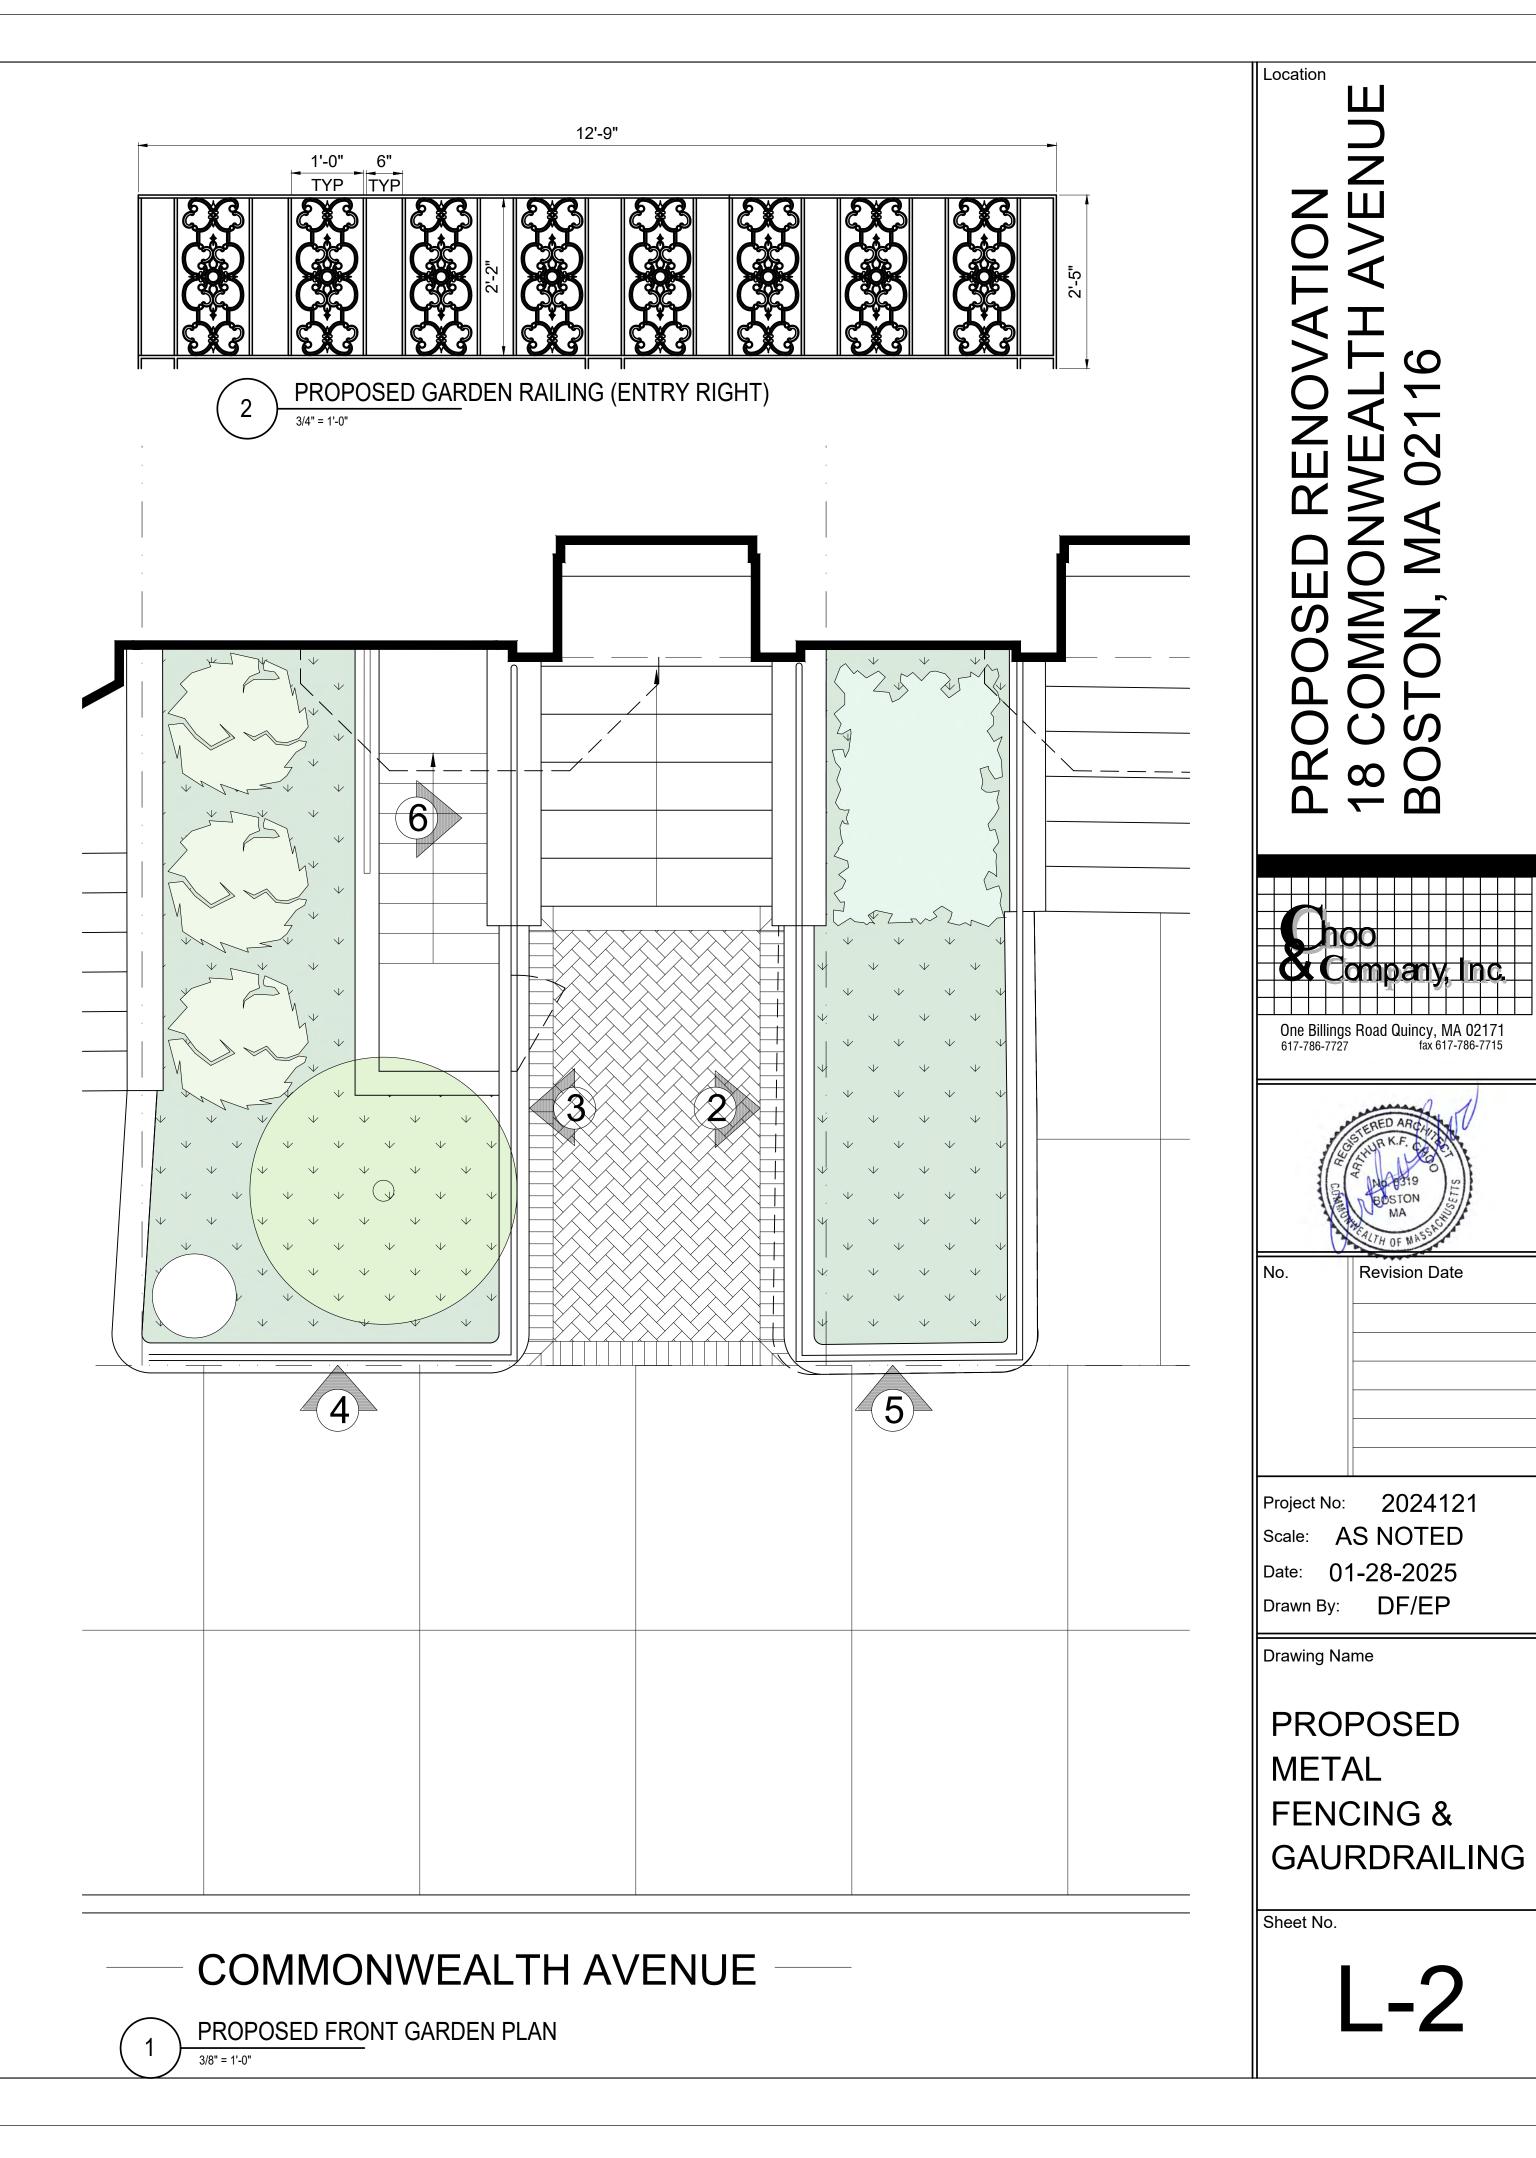


02

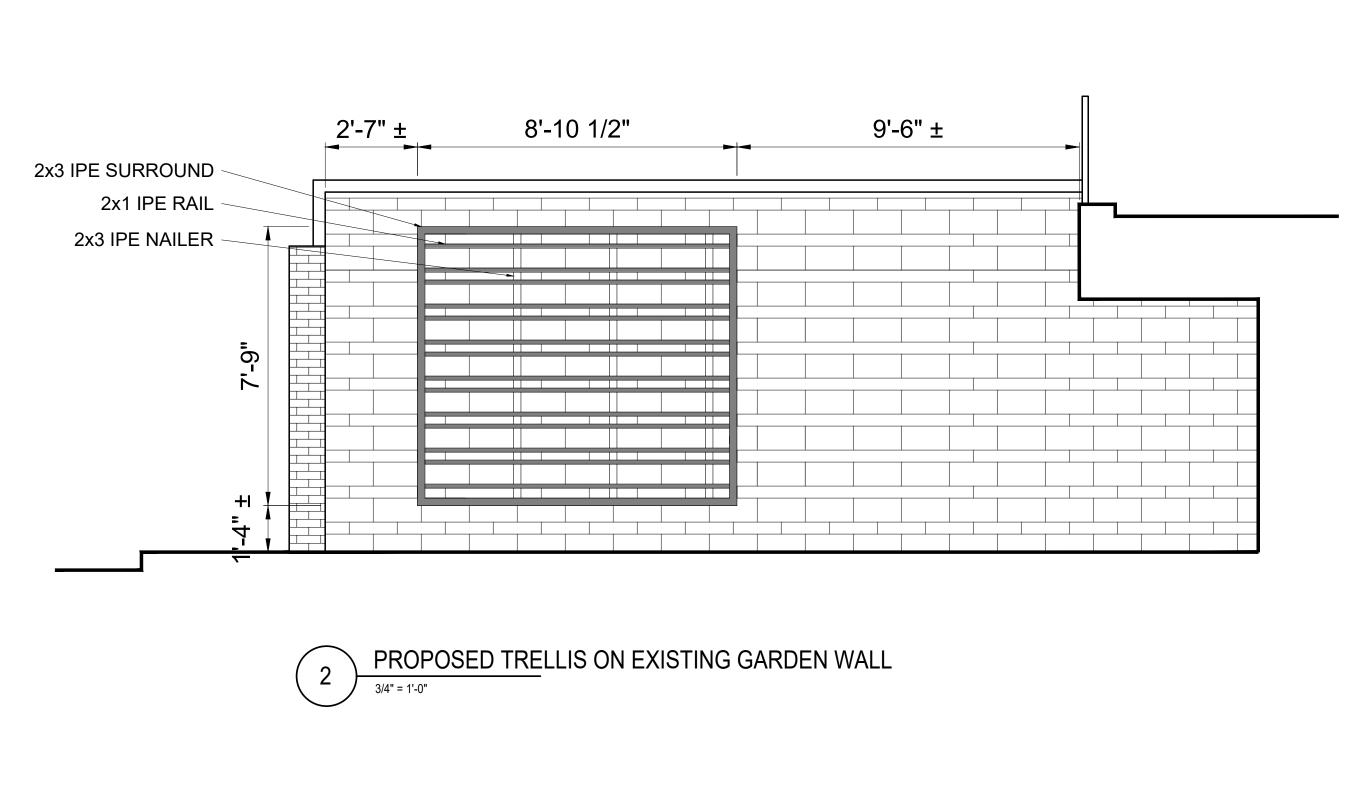

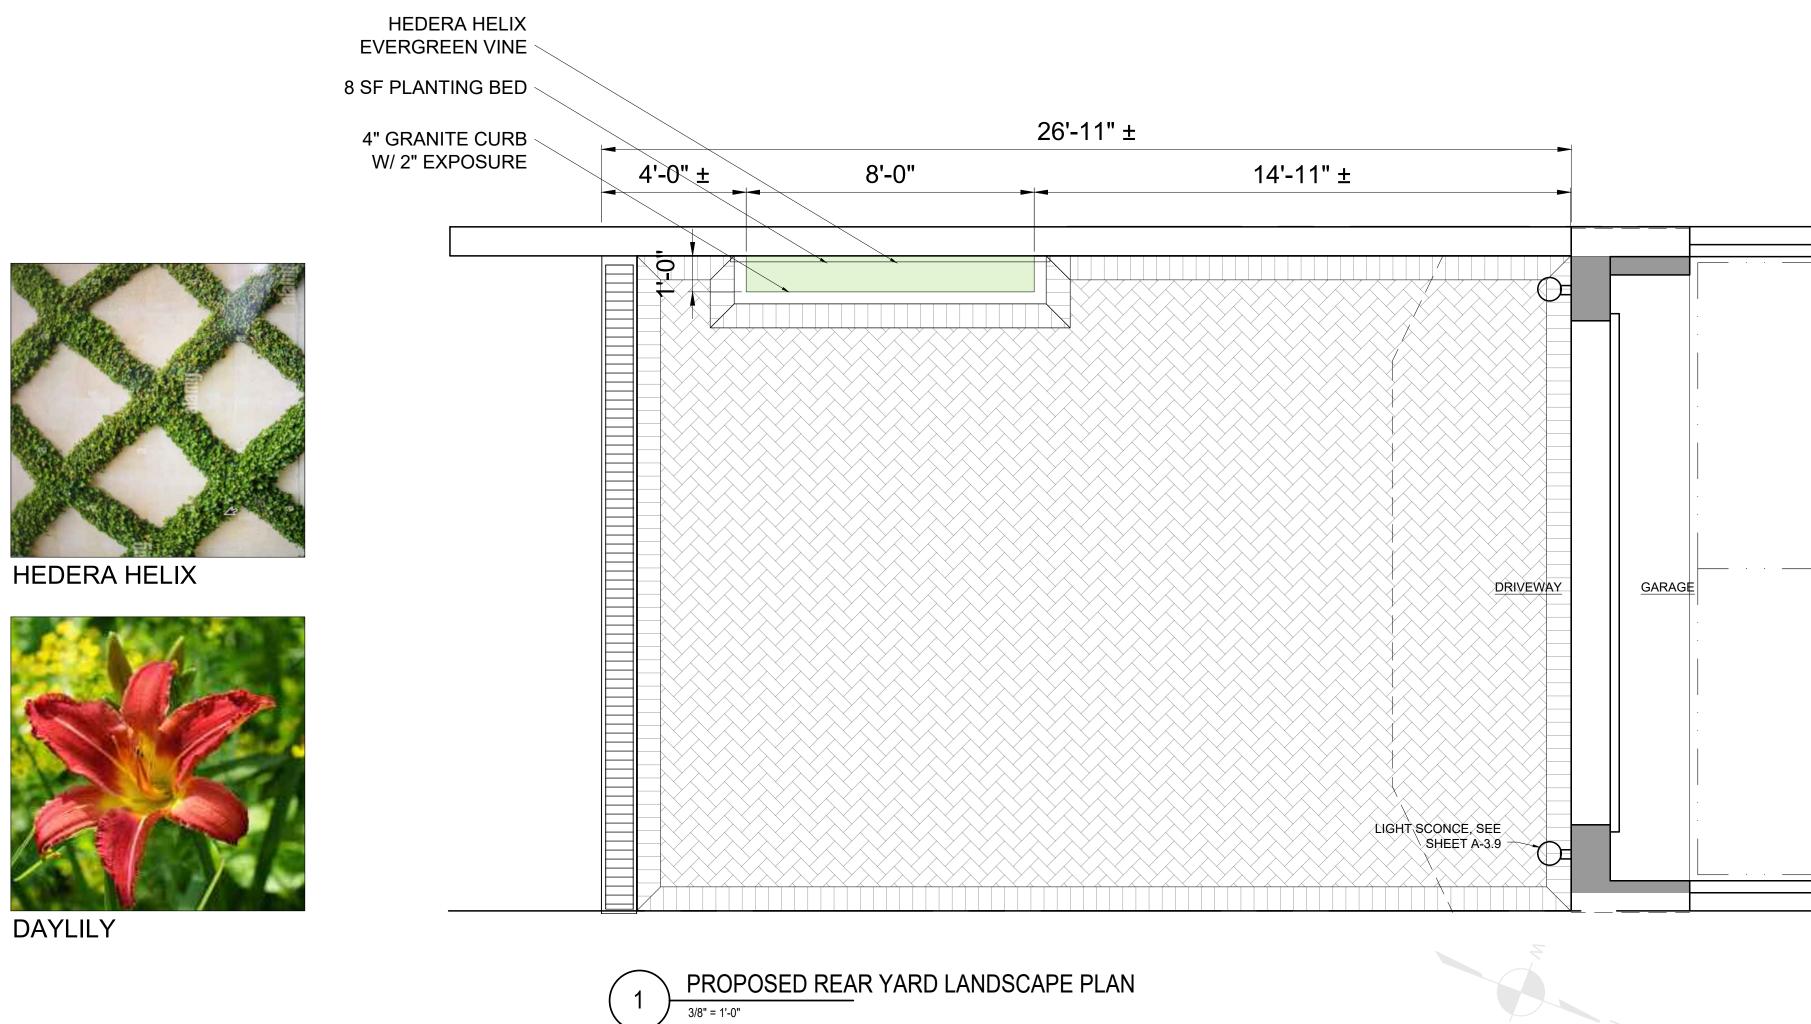

One Billings Road Quincy, MA 02171 617-786-7727 fax 617-786-7715

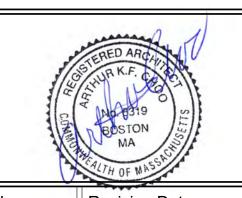

Revision Date


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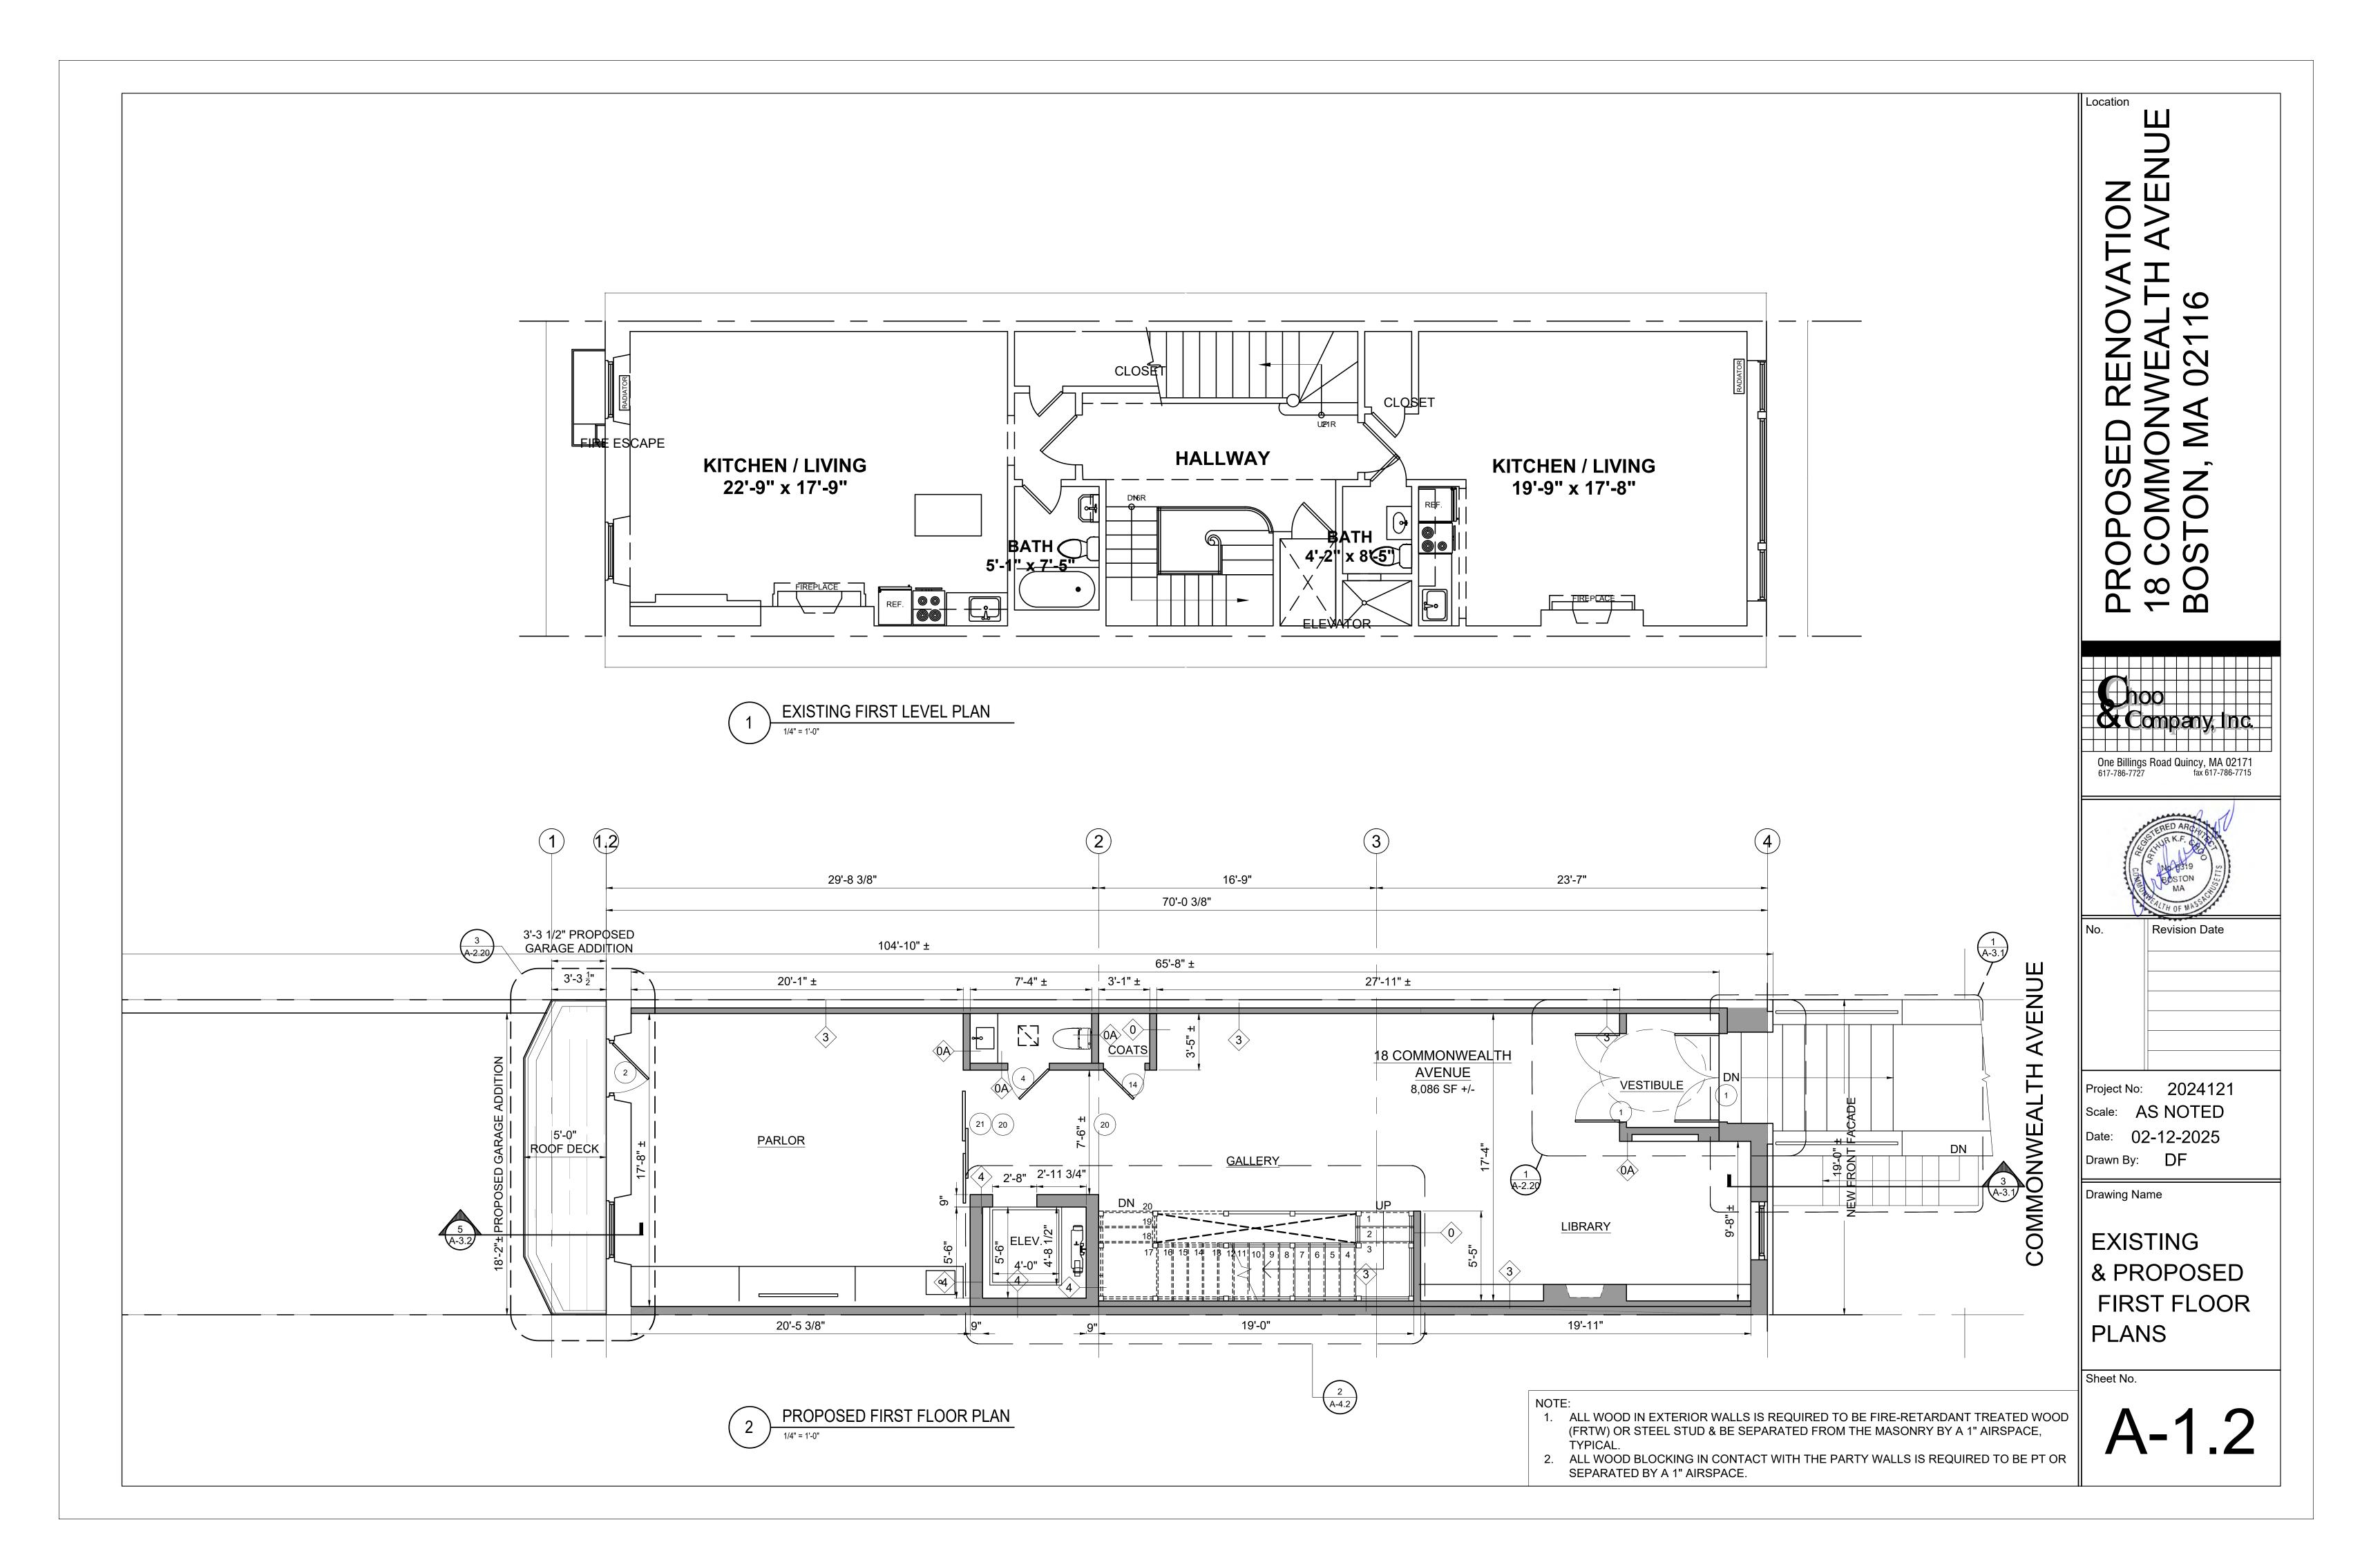
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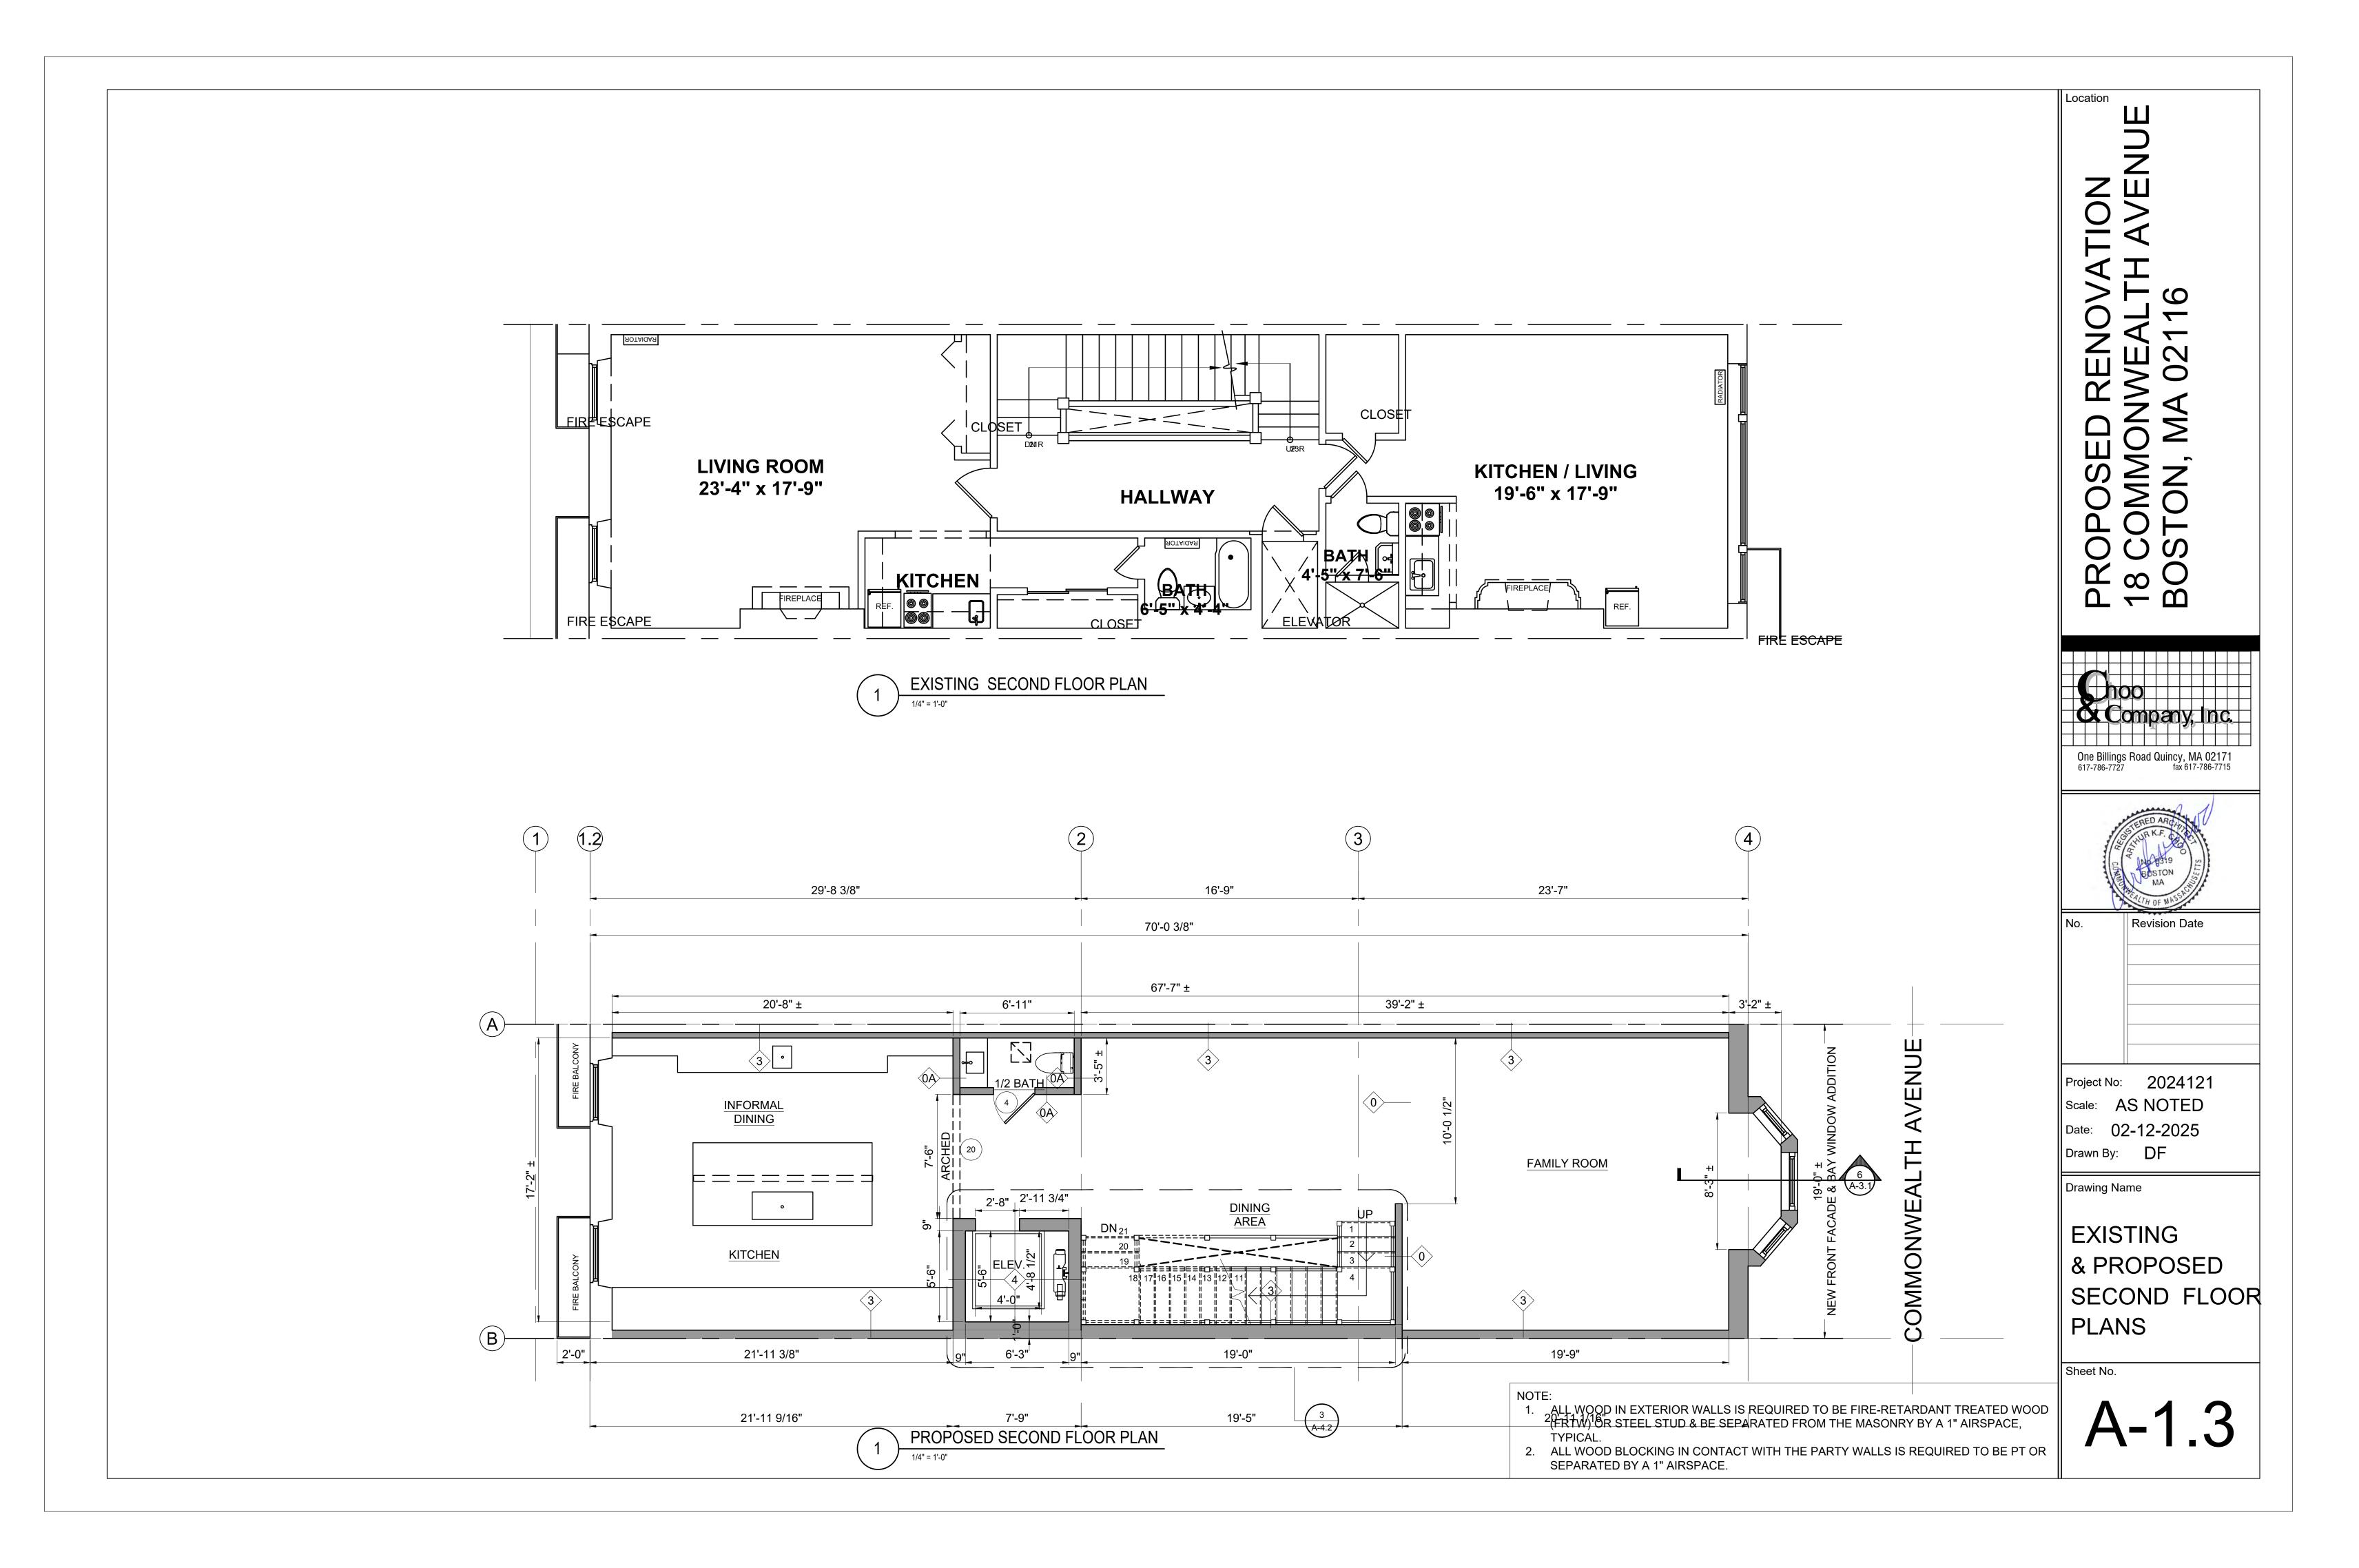
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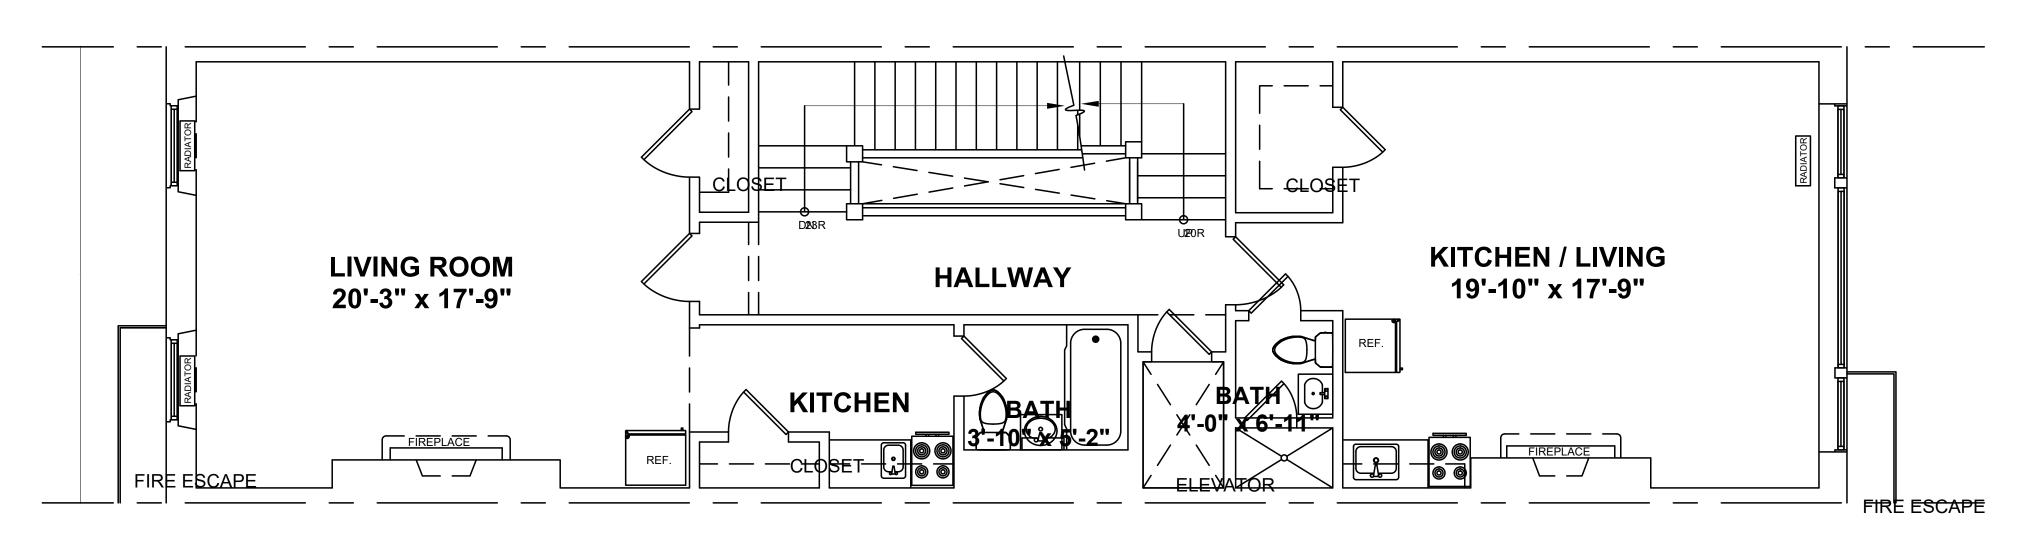
PROPOSED REAR YARD LANDSCAPE PLAN & ELEV.

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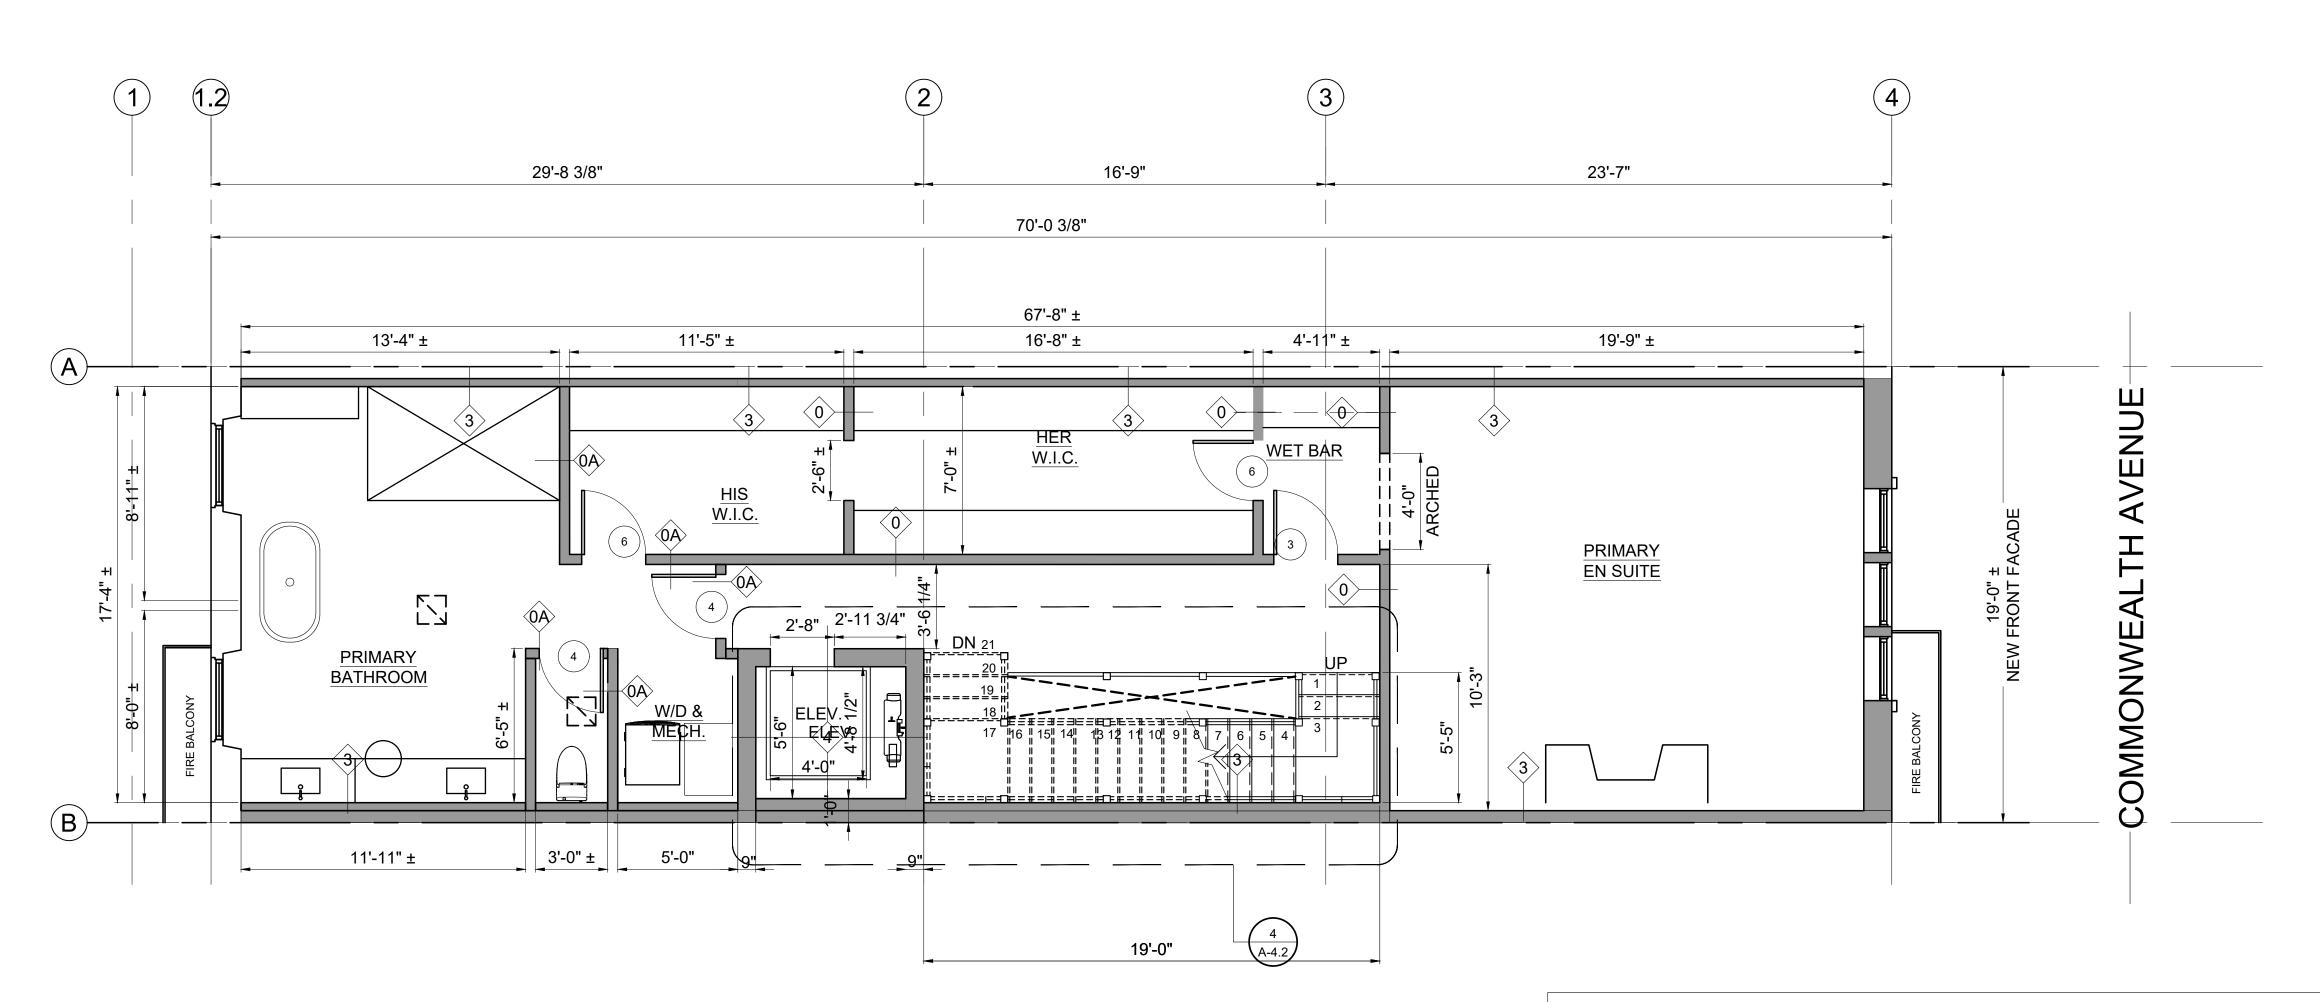






2 EXISTING THIRD FLOOR PLAN

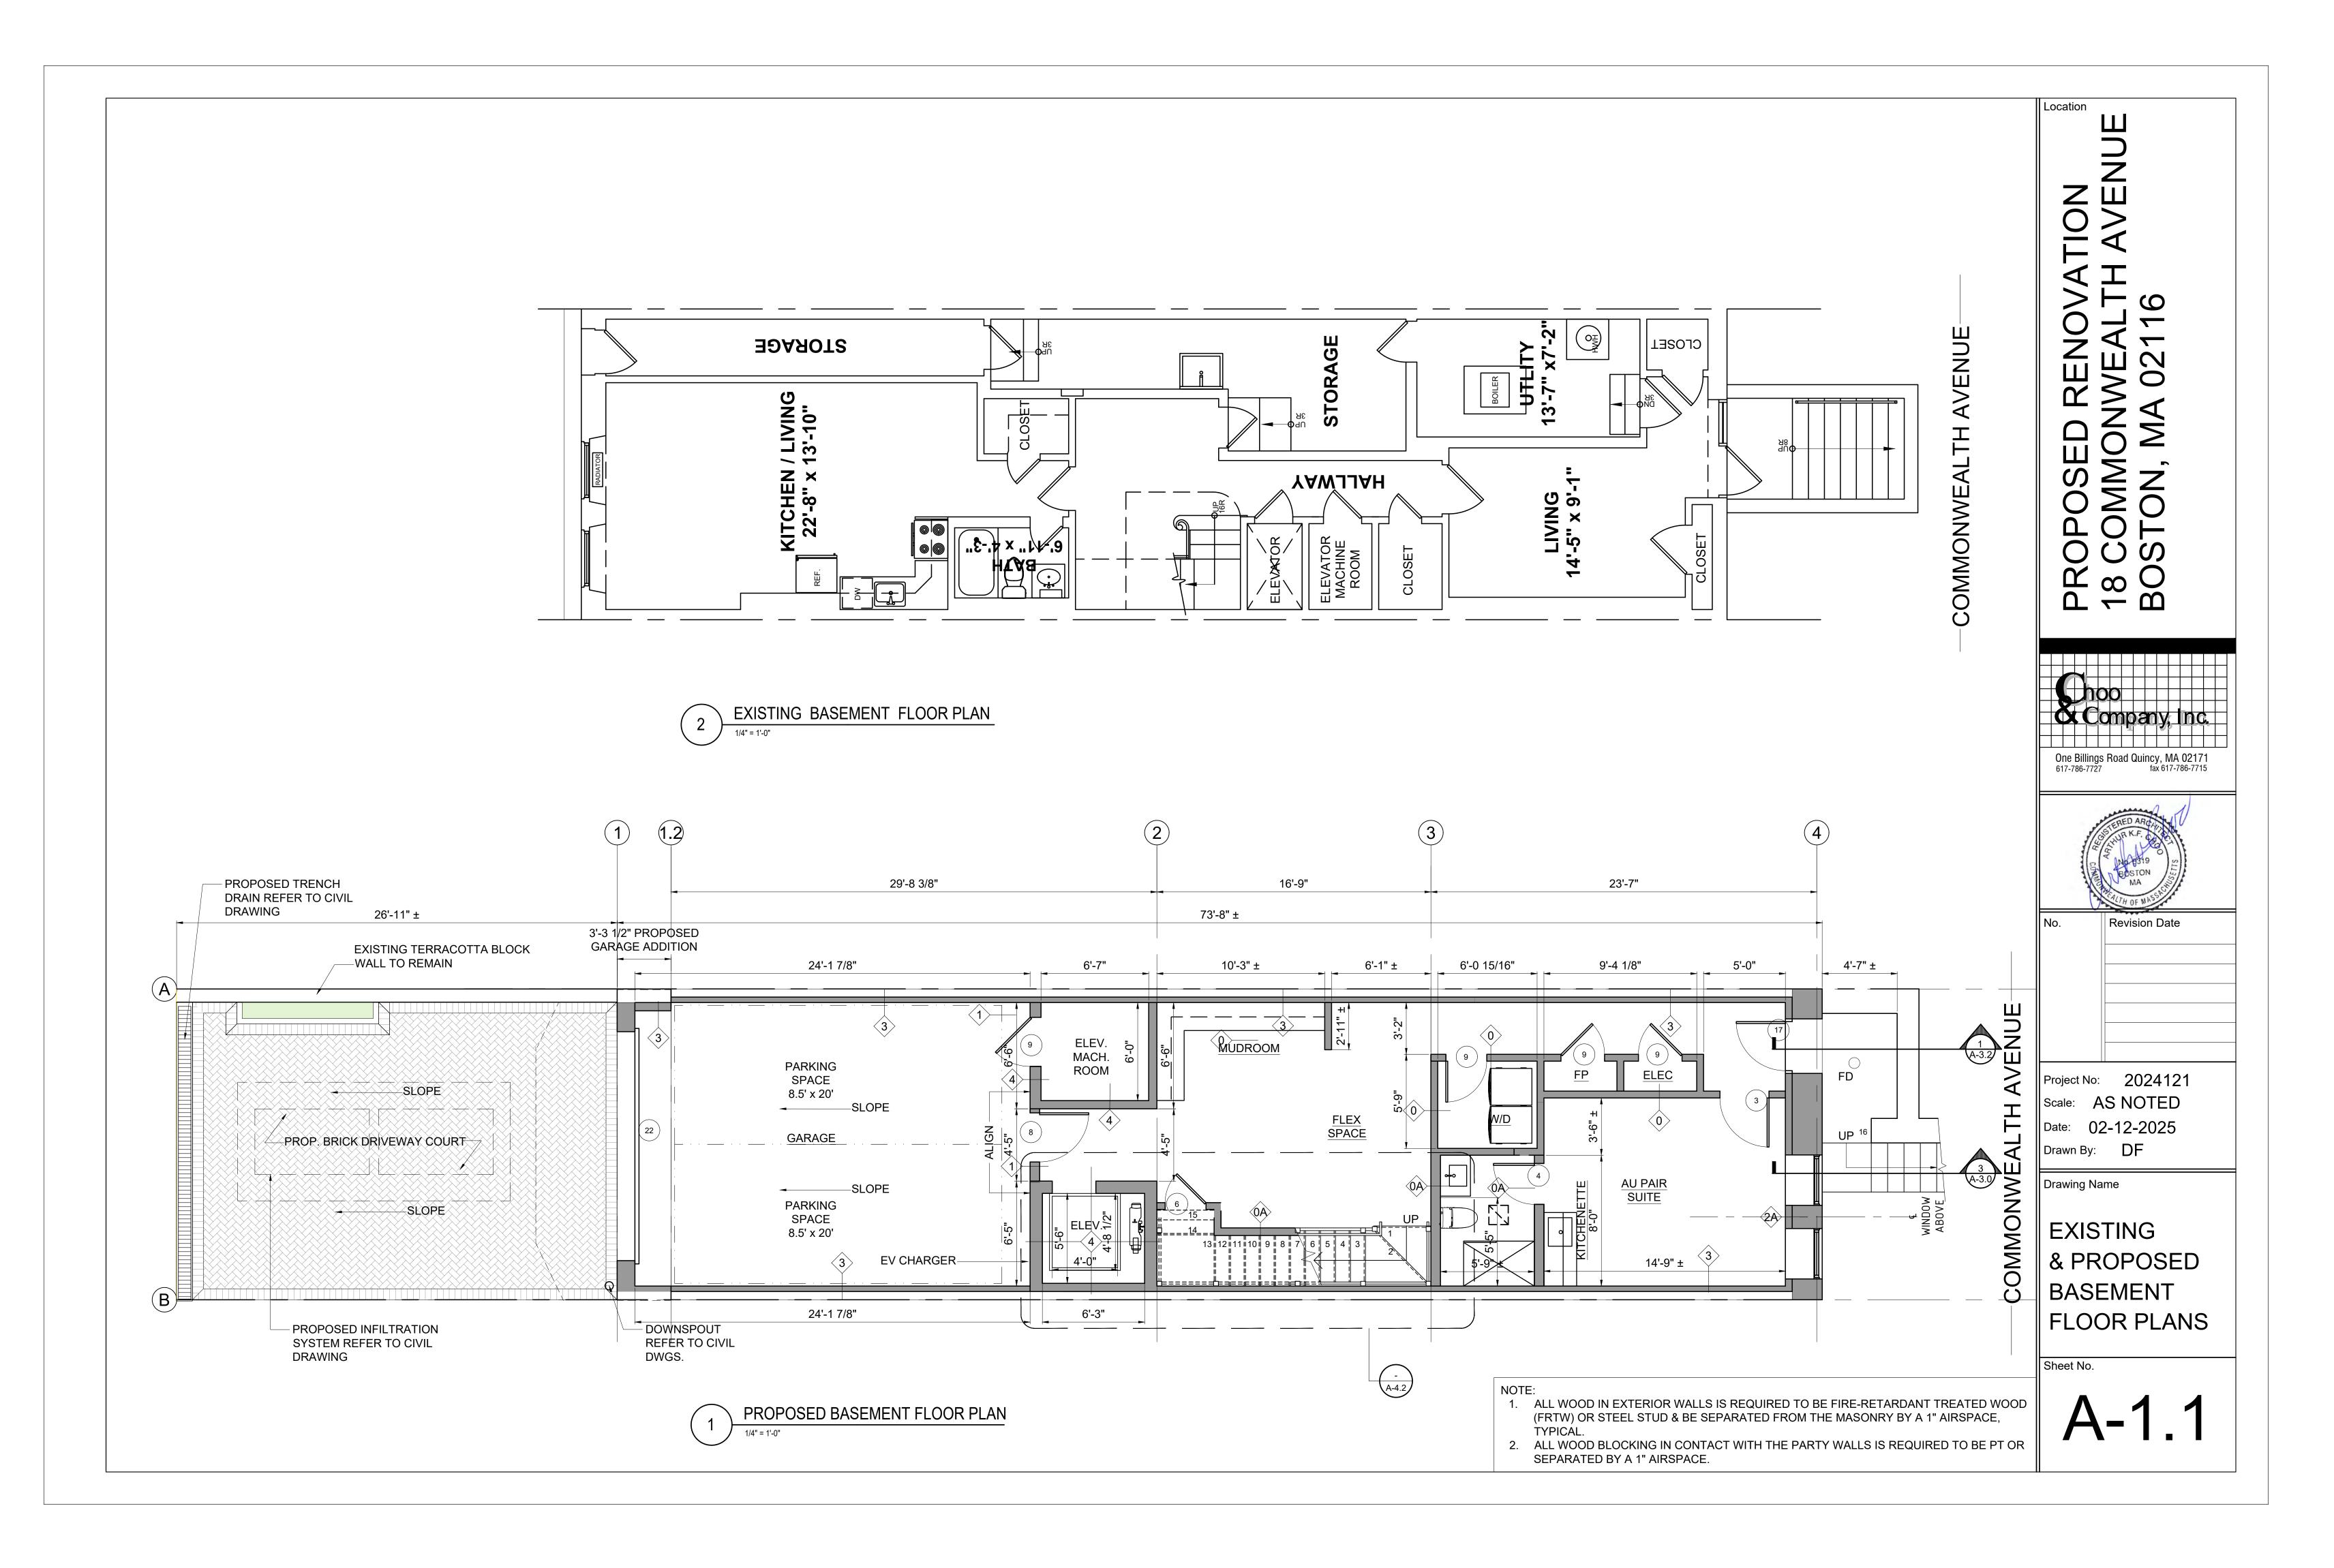PROPOSED THIRD FLOOR PLAN



NOTE:

 ALL WOOD IN EXTERIOR WALLS IS REQUIRED TO BE FIRE-RETARDANT TREATED WOOD (FRTW) OR STEEL STUD & BE SEPARATED FROM THE MASONRY BY A 1" AIRSPACE, TYPICAL.

2. ALL WOOD BLOCKING IN CONTACT WITH THE PARTY WALLS IS REQUIRED TO BE PT OR SEPARATED BY A 1" AIRSPACE.

PROPOSED RENOVATION 18 COMMONWEALTH AVENU BOSTON, MA 02116

One Billings Road Quincy, MA 02171
617-786-7727 fax 617-786-7715



No. Revision Date


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Scale: AS NOTED
Date: 02-12-2025
Drawn By: DF

Drawing Name

EXISTING
& PROPOSED
THIRD FLOOR
PLANS


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2 EXISTING FOURTH FLOOR PLAN

1/4" = 1'-0"

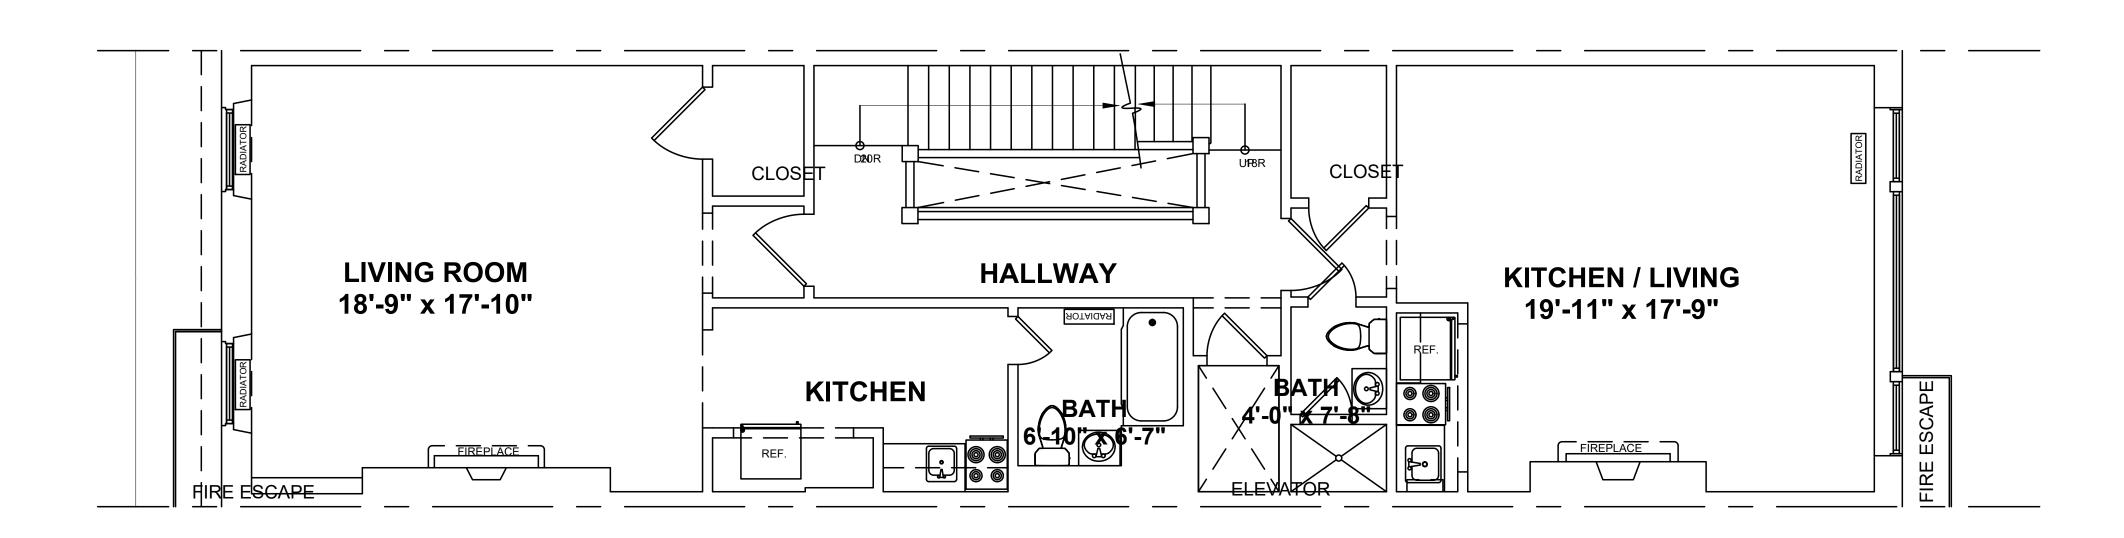

NOTE:


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 TYPICA
- 2. ALL WOOD BLOCKING IN CONTACT WITH THE PARTY WALLS IS REQUIRED TO BE PT OR SEPARATED BY A 1" AIRSPACE.

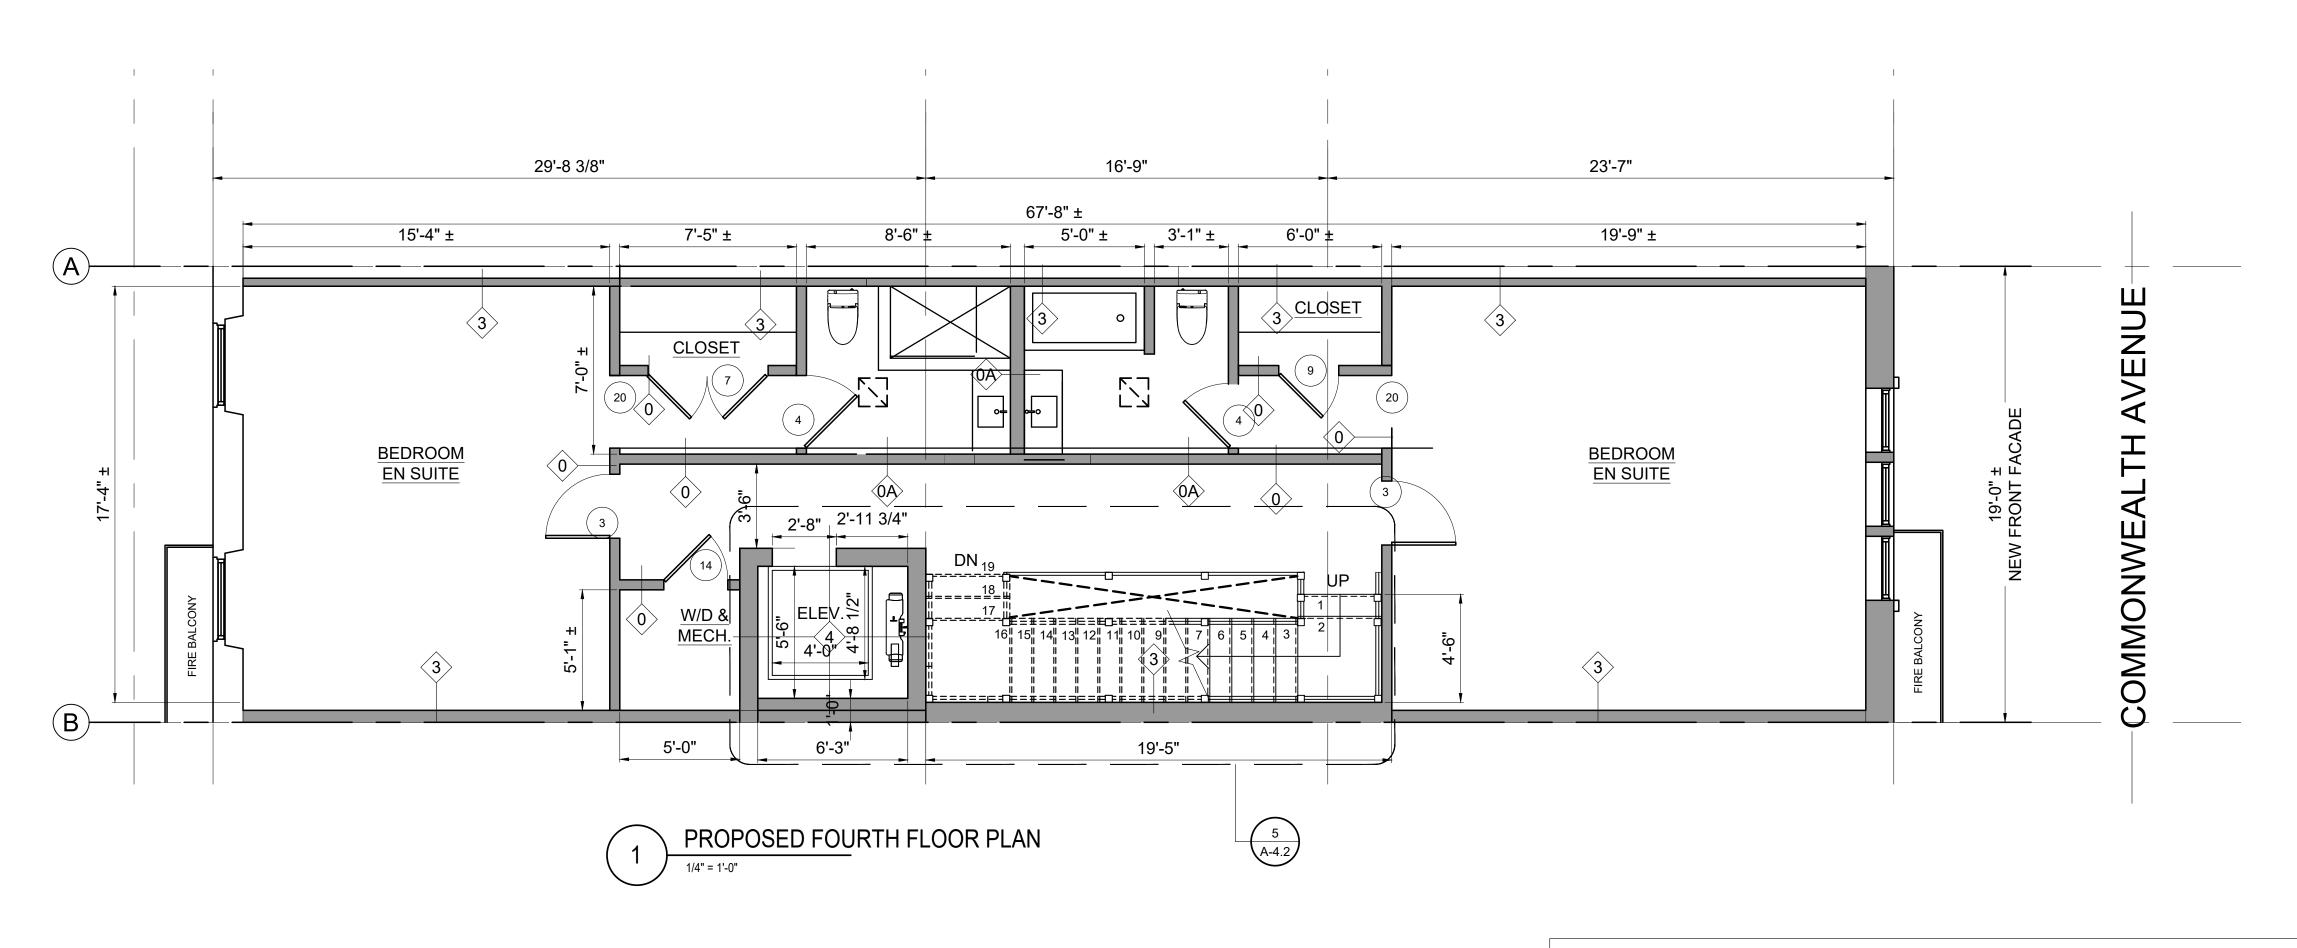PROPOSED RENOVATION
18 COMMONWEALTH AVENUE
BOSTON, MA 02116

One Billings Road Quincy, MA 02171 617-786-7727 fax 617-786-7715



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Project No: 2024121
Scale: AS NOTED
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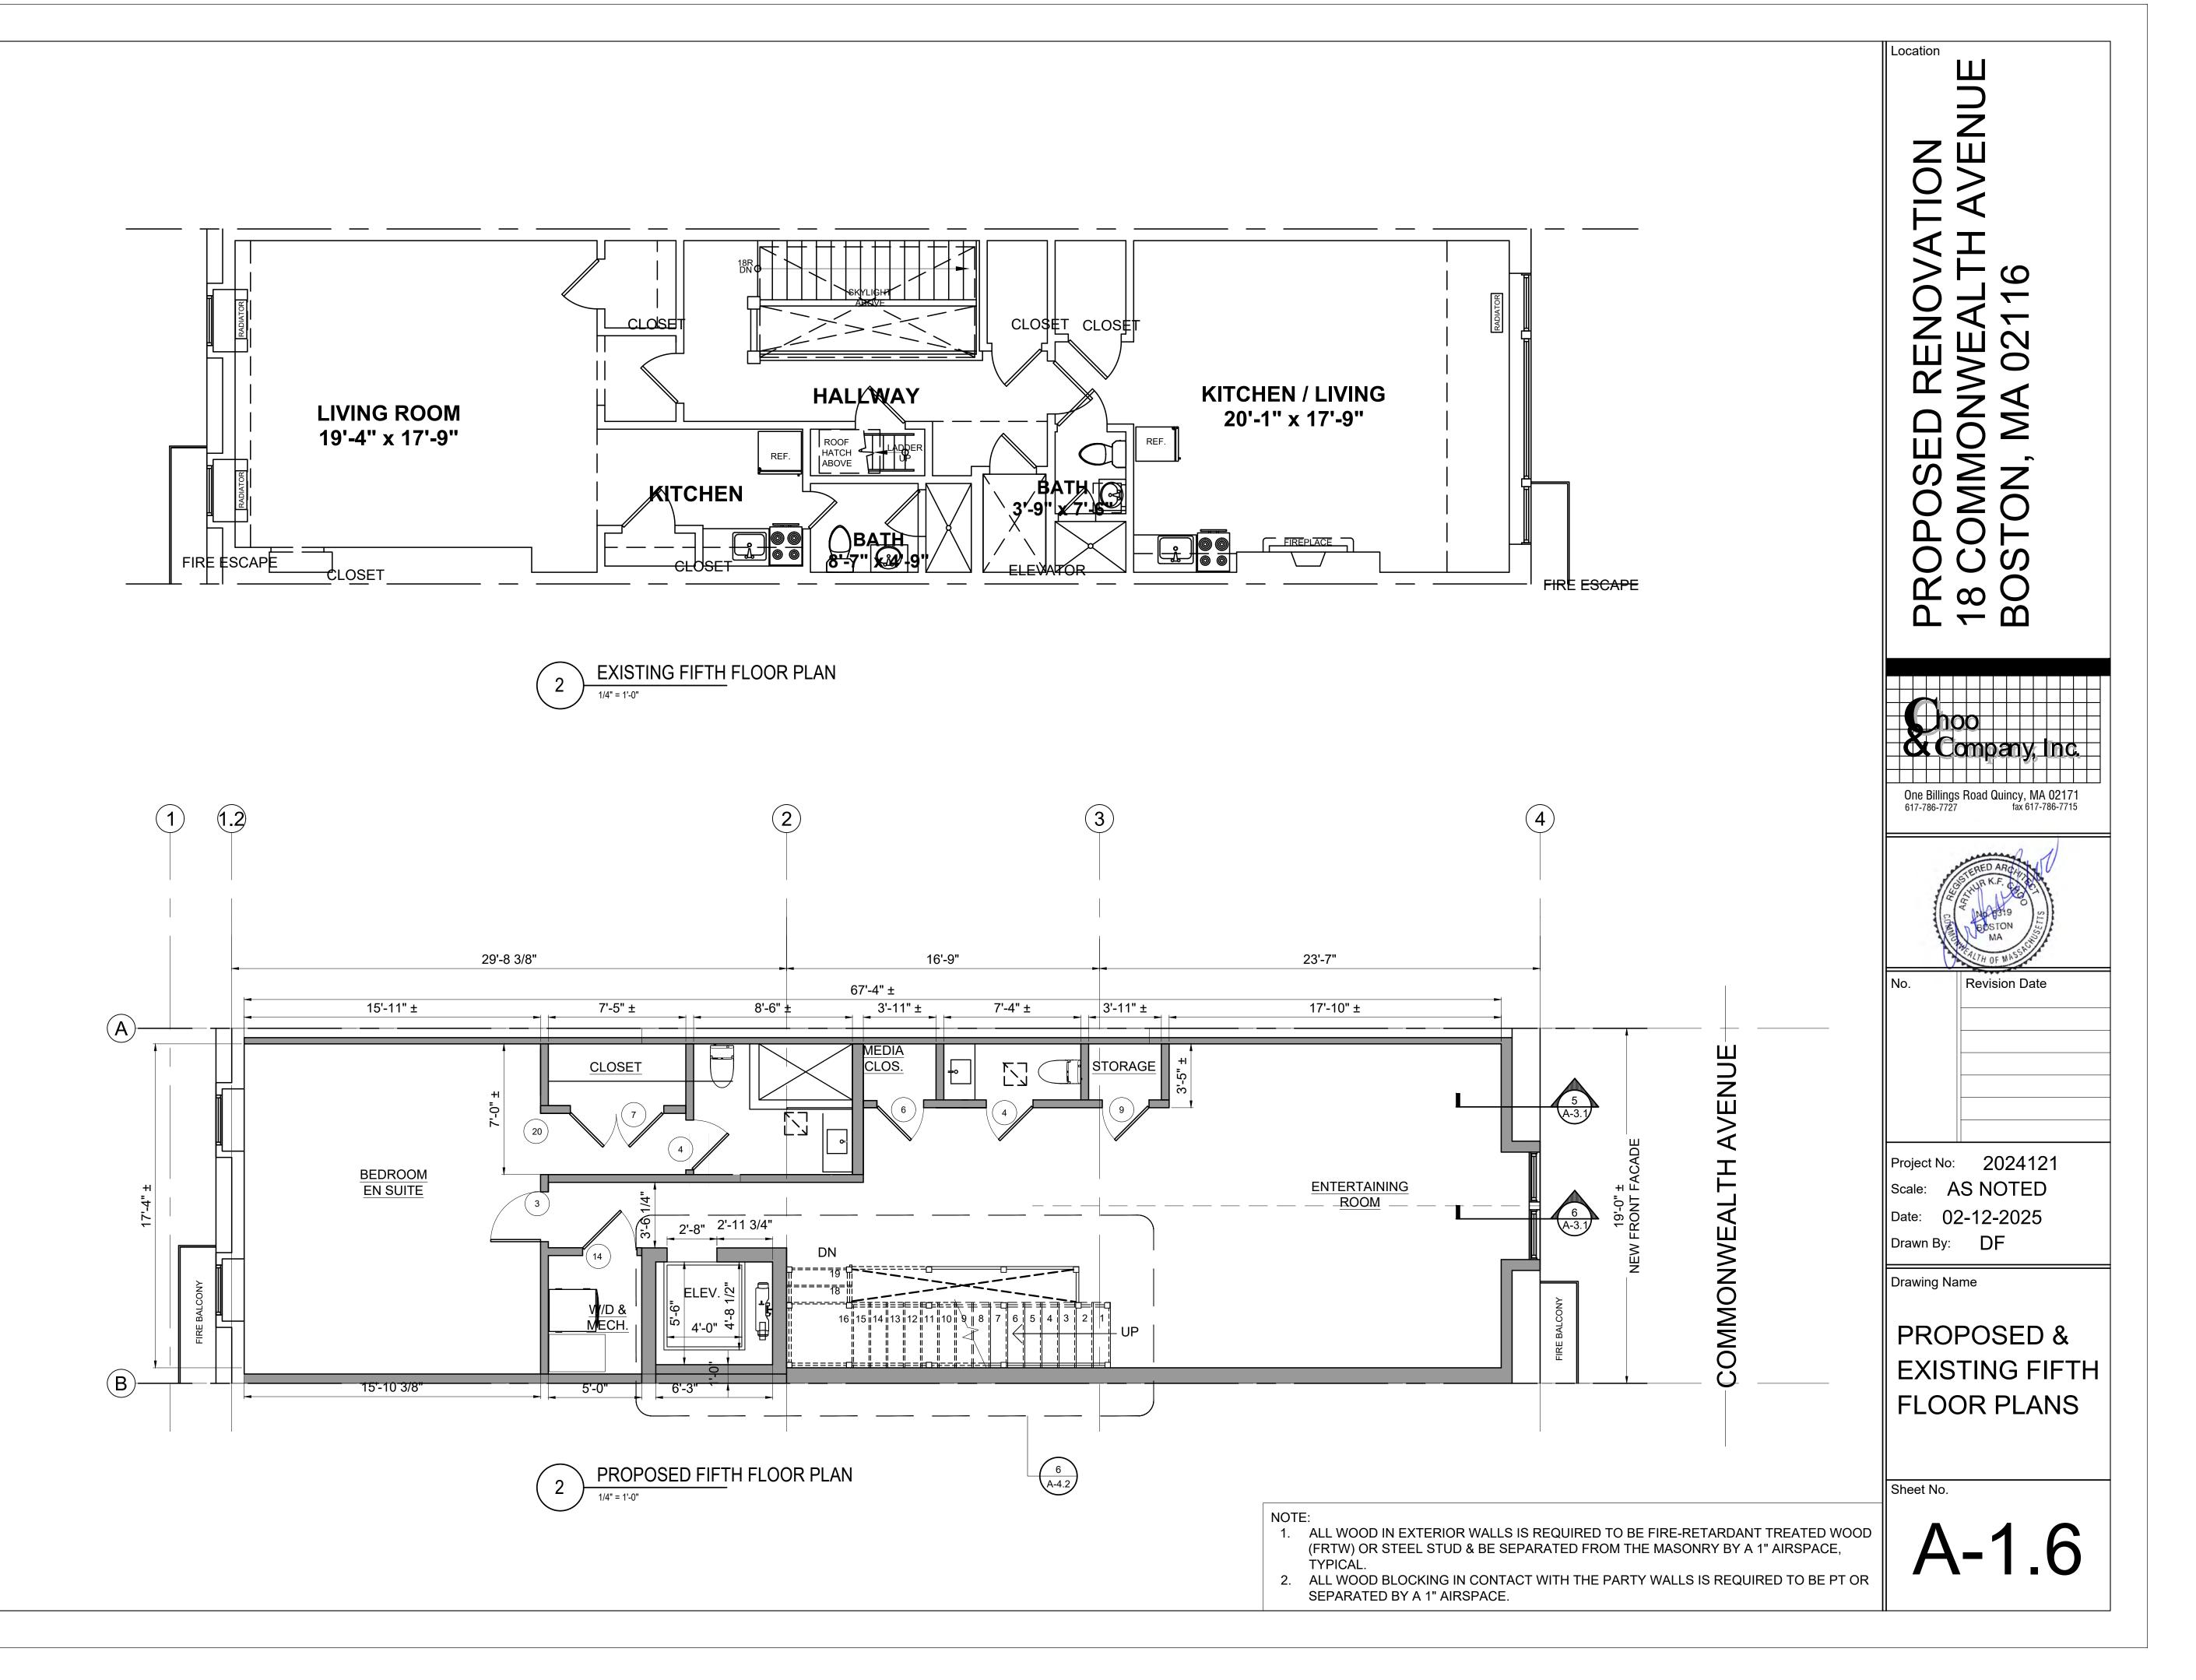
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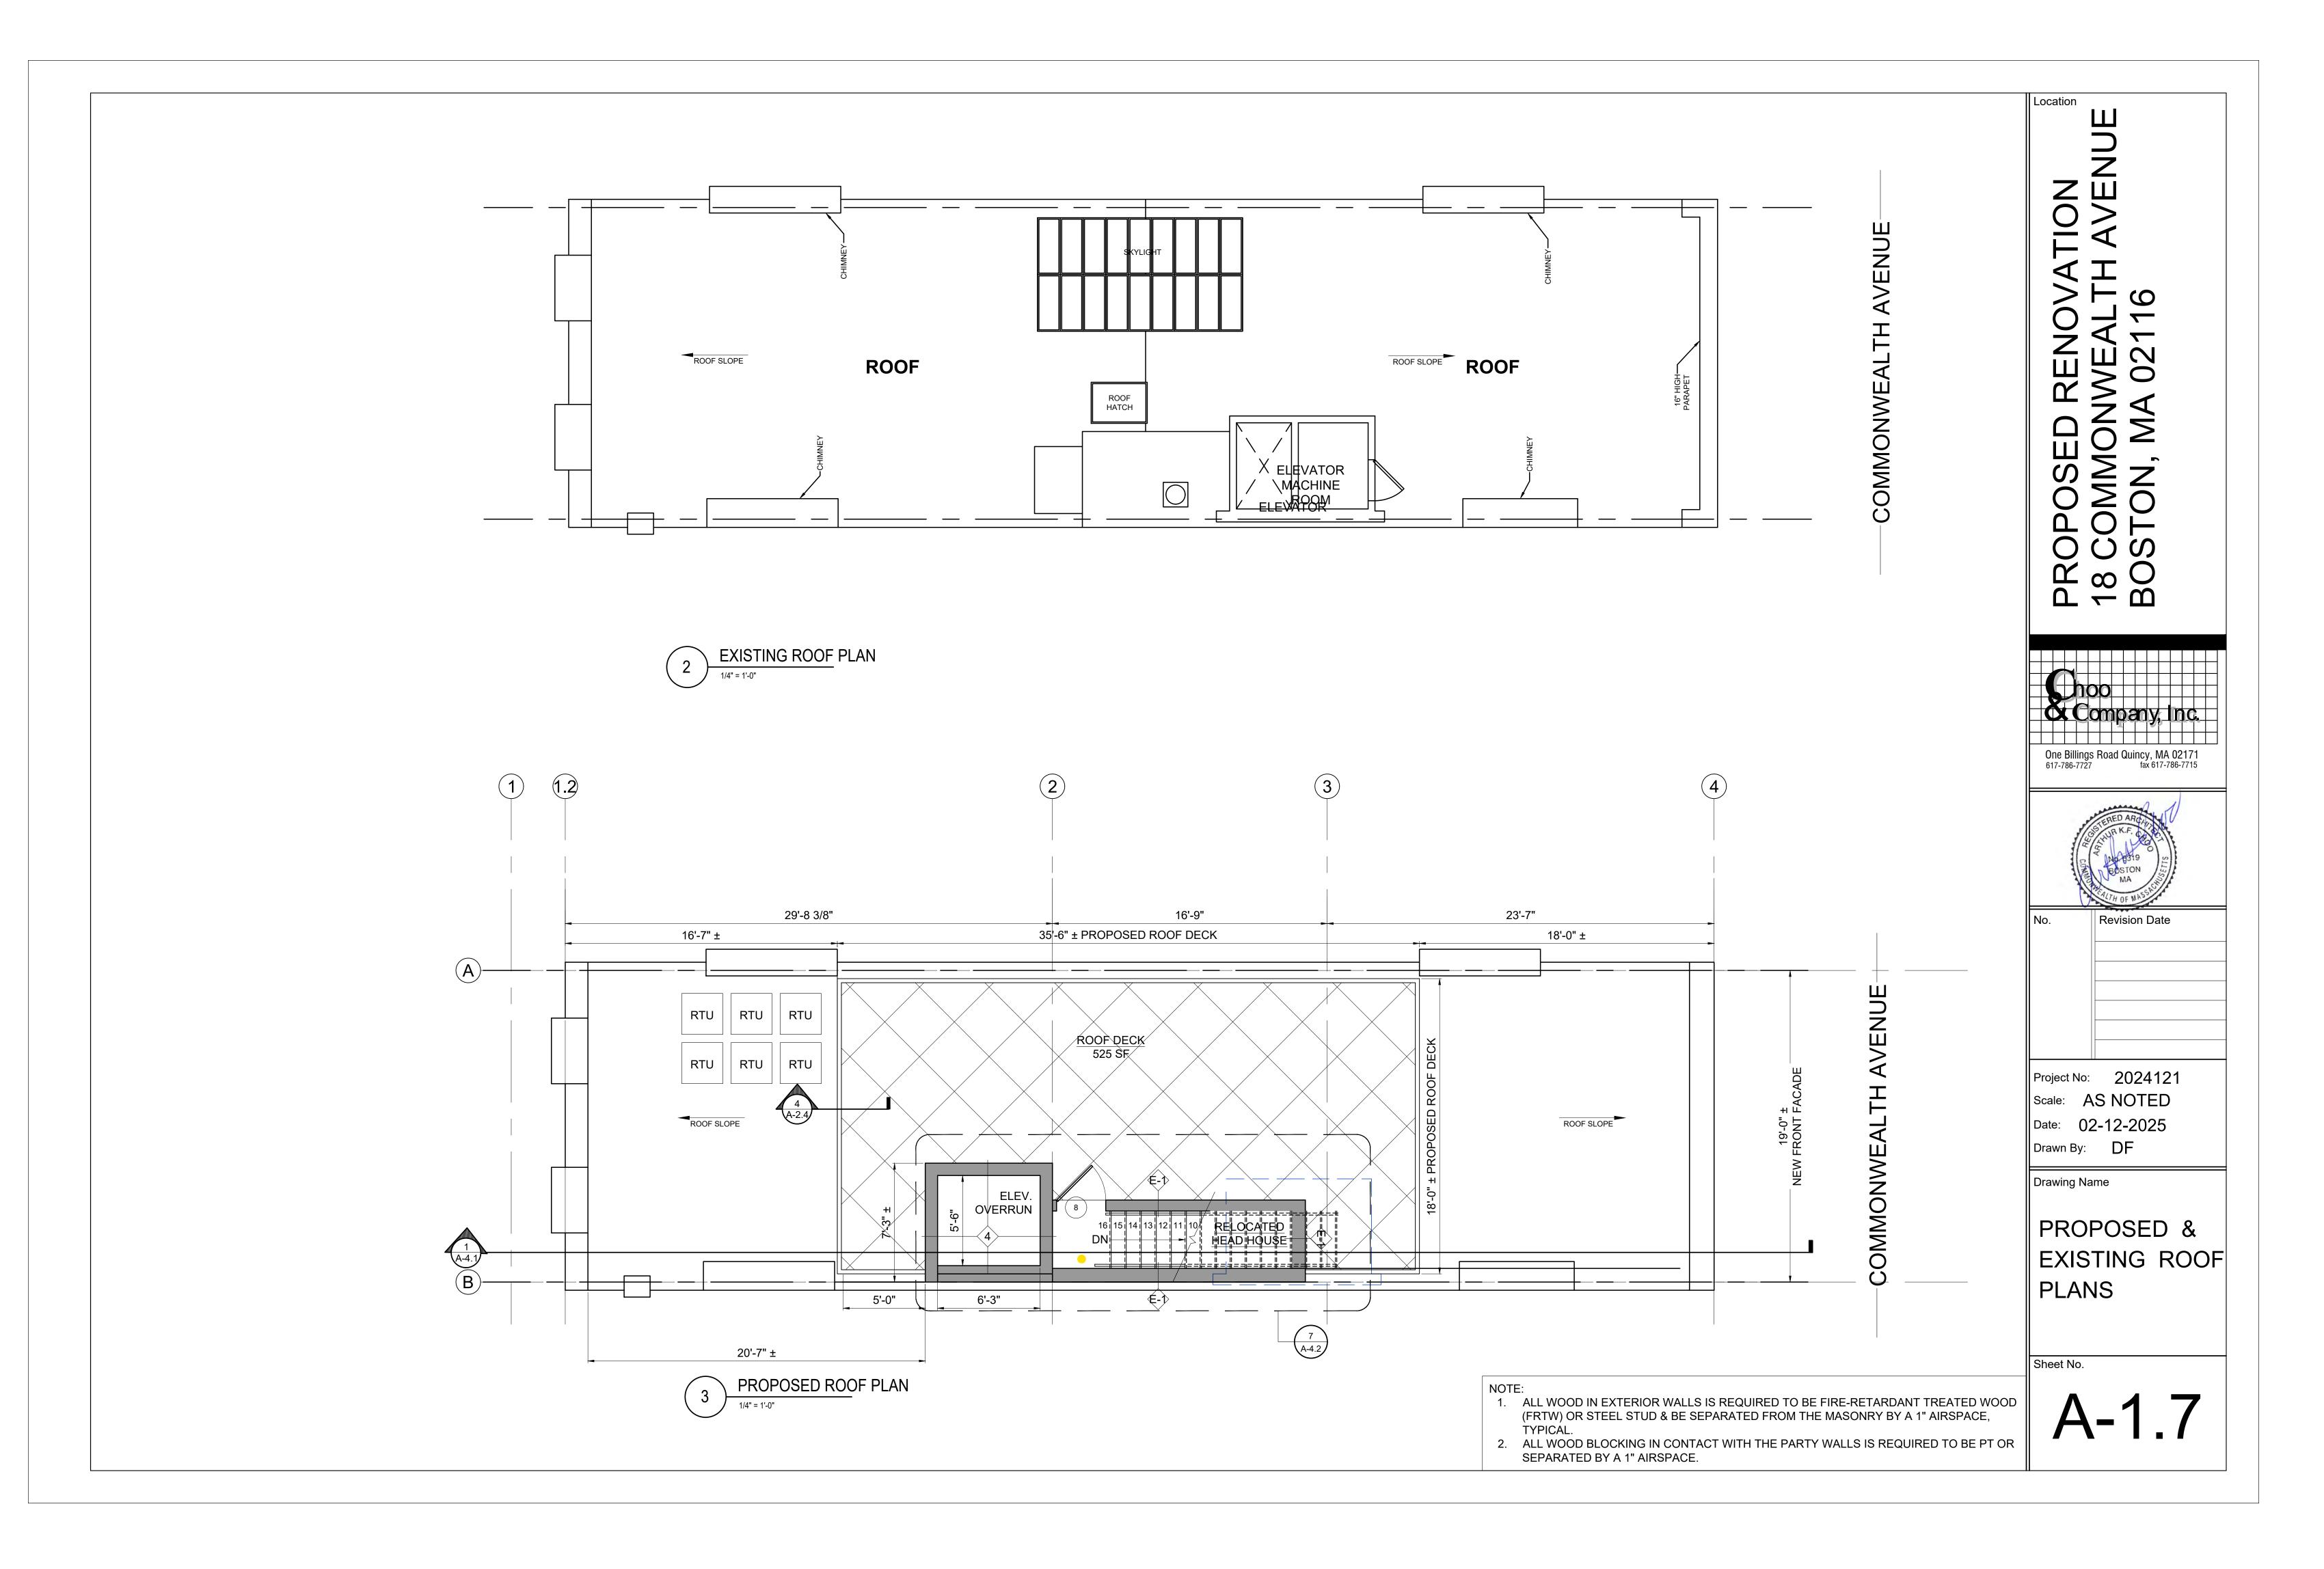
Drawn By: DF

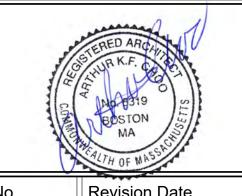& PROPOSED FLOOR PLANS

Sheet No.


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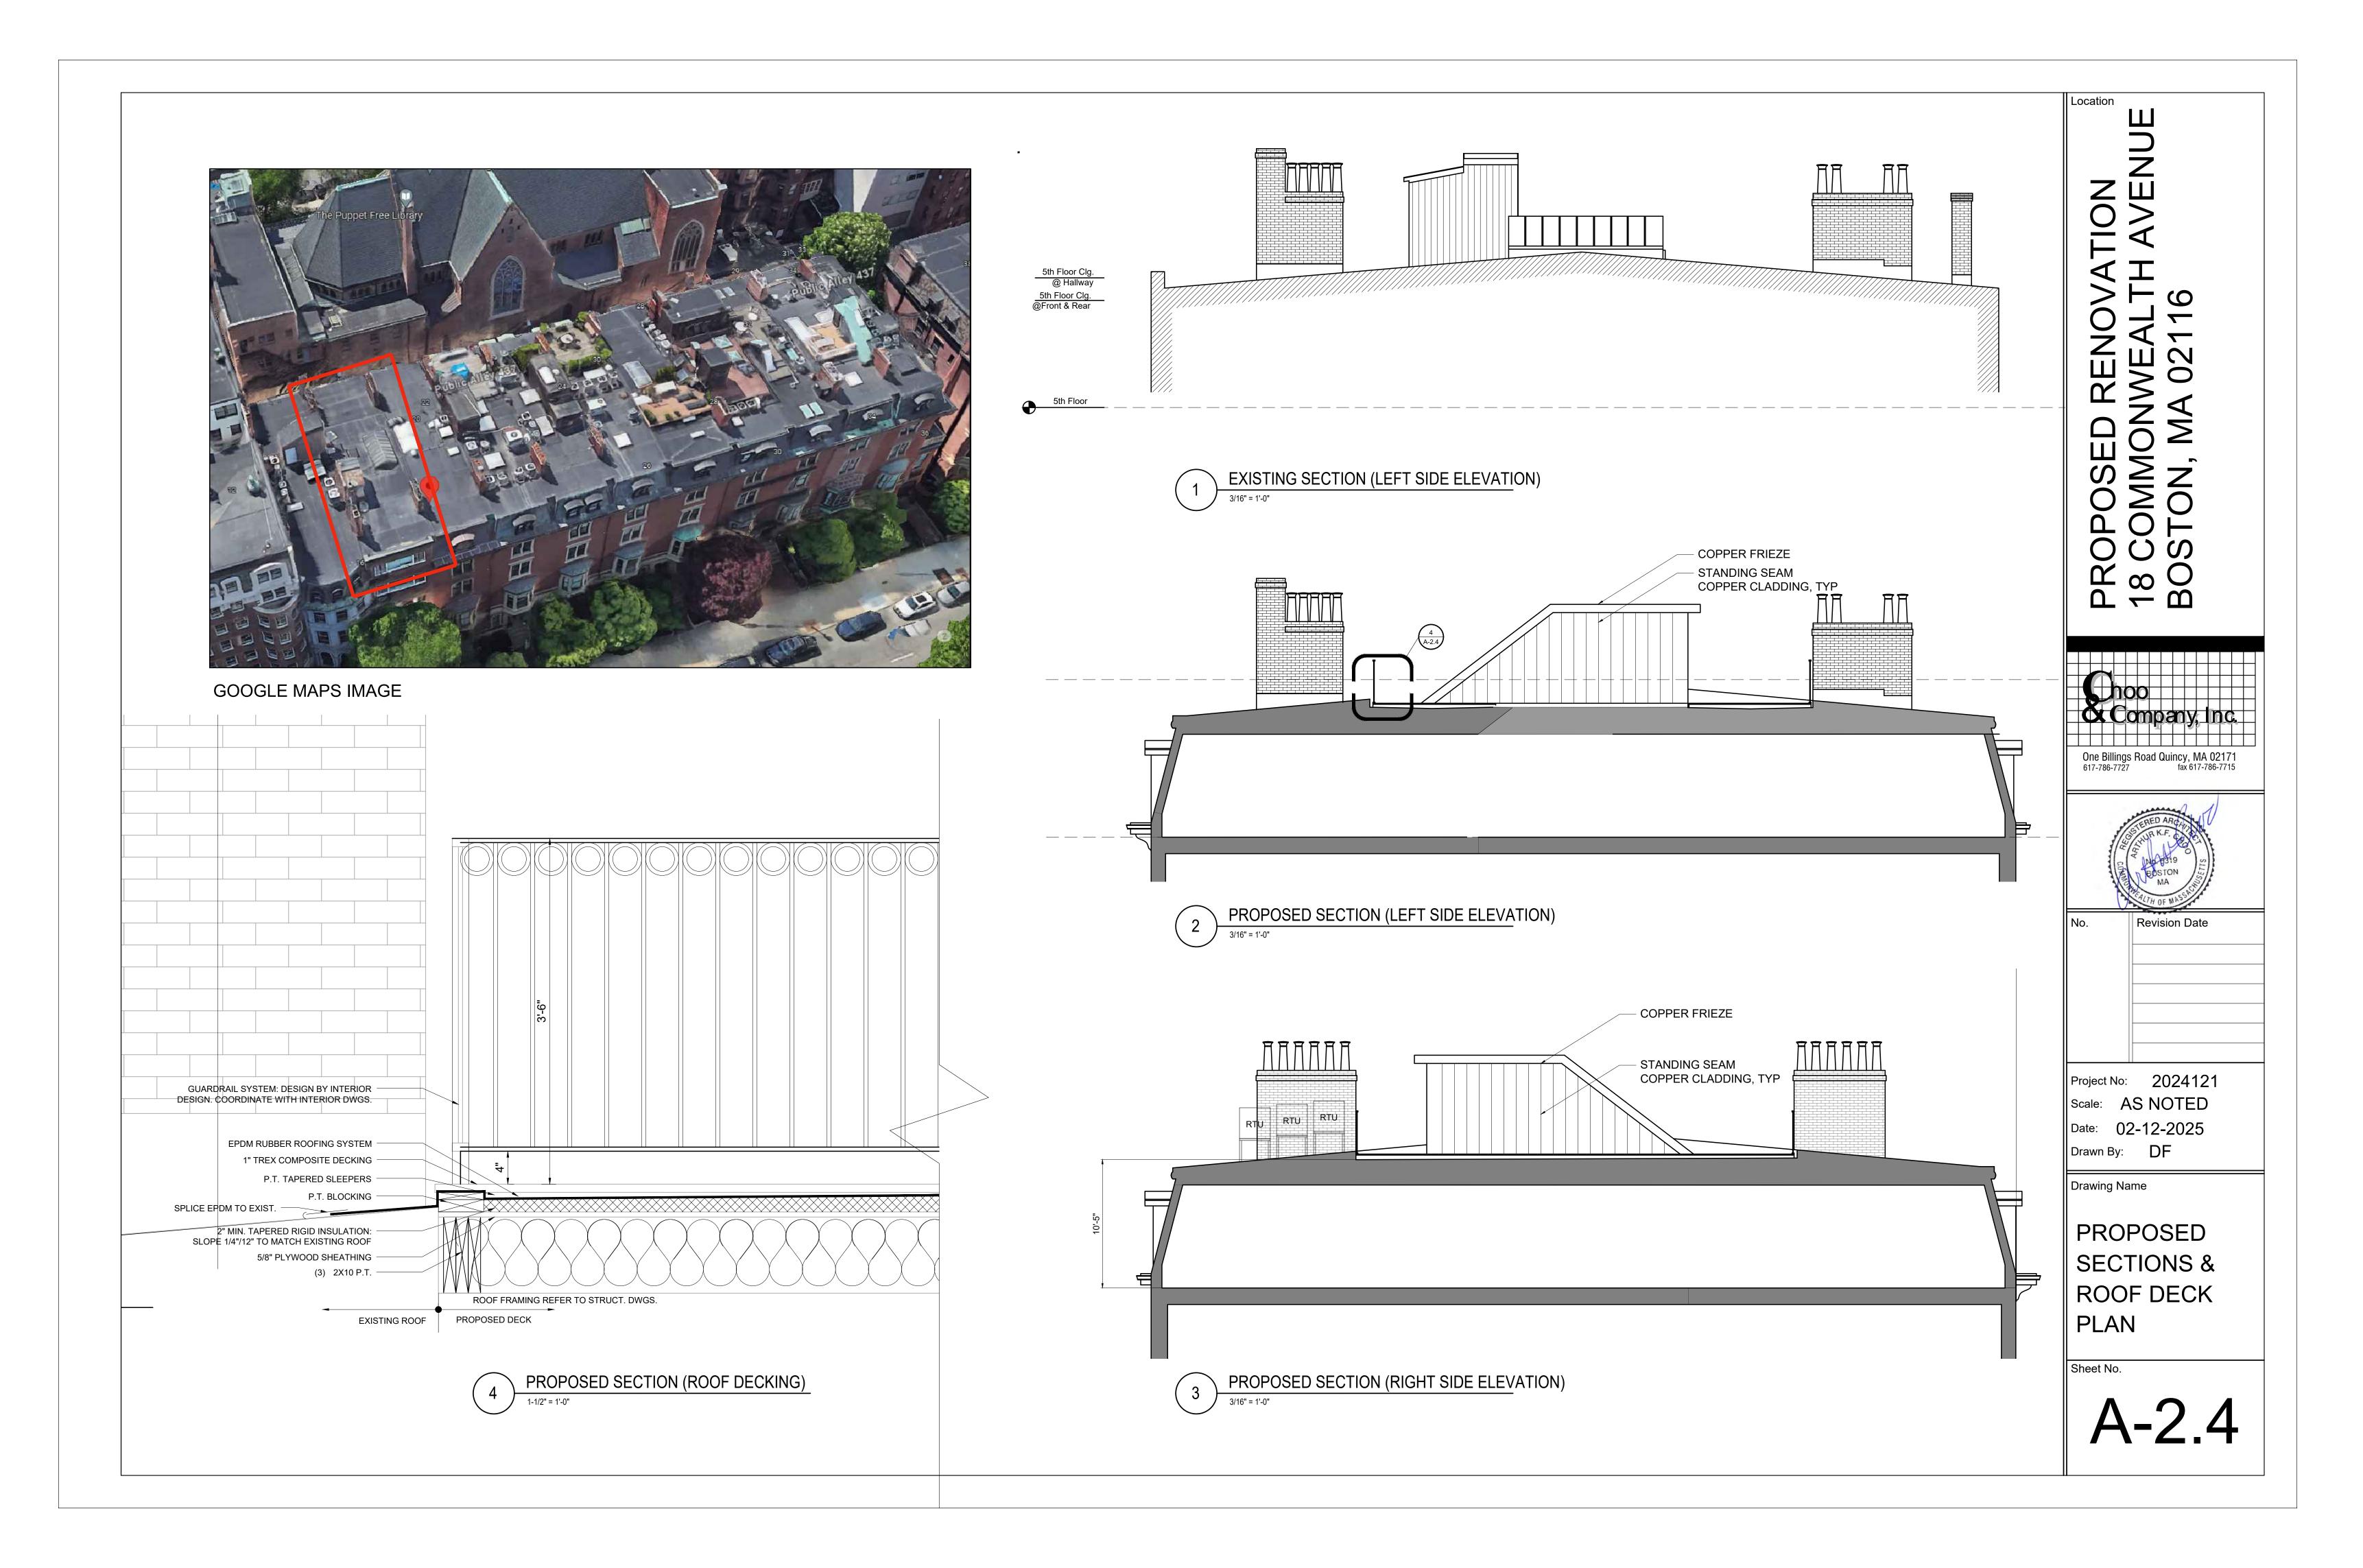














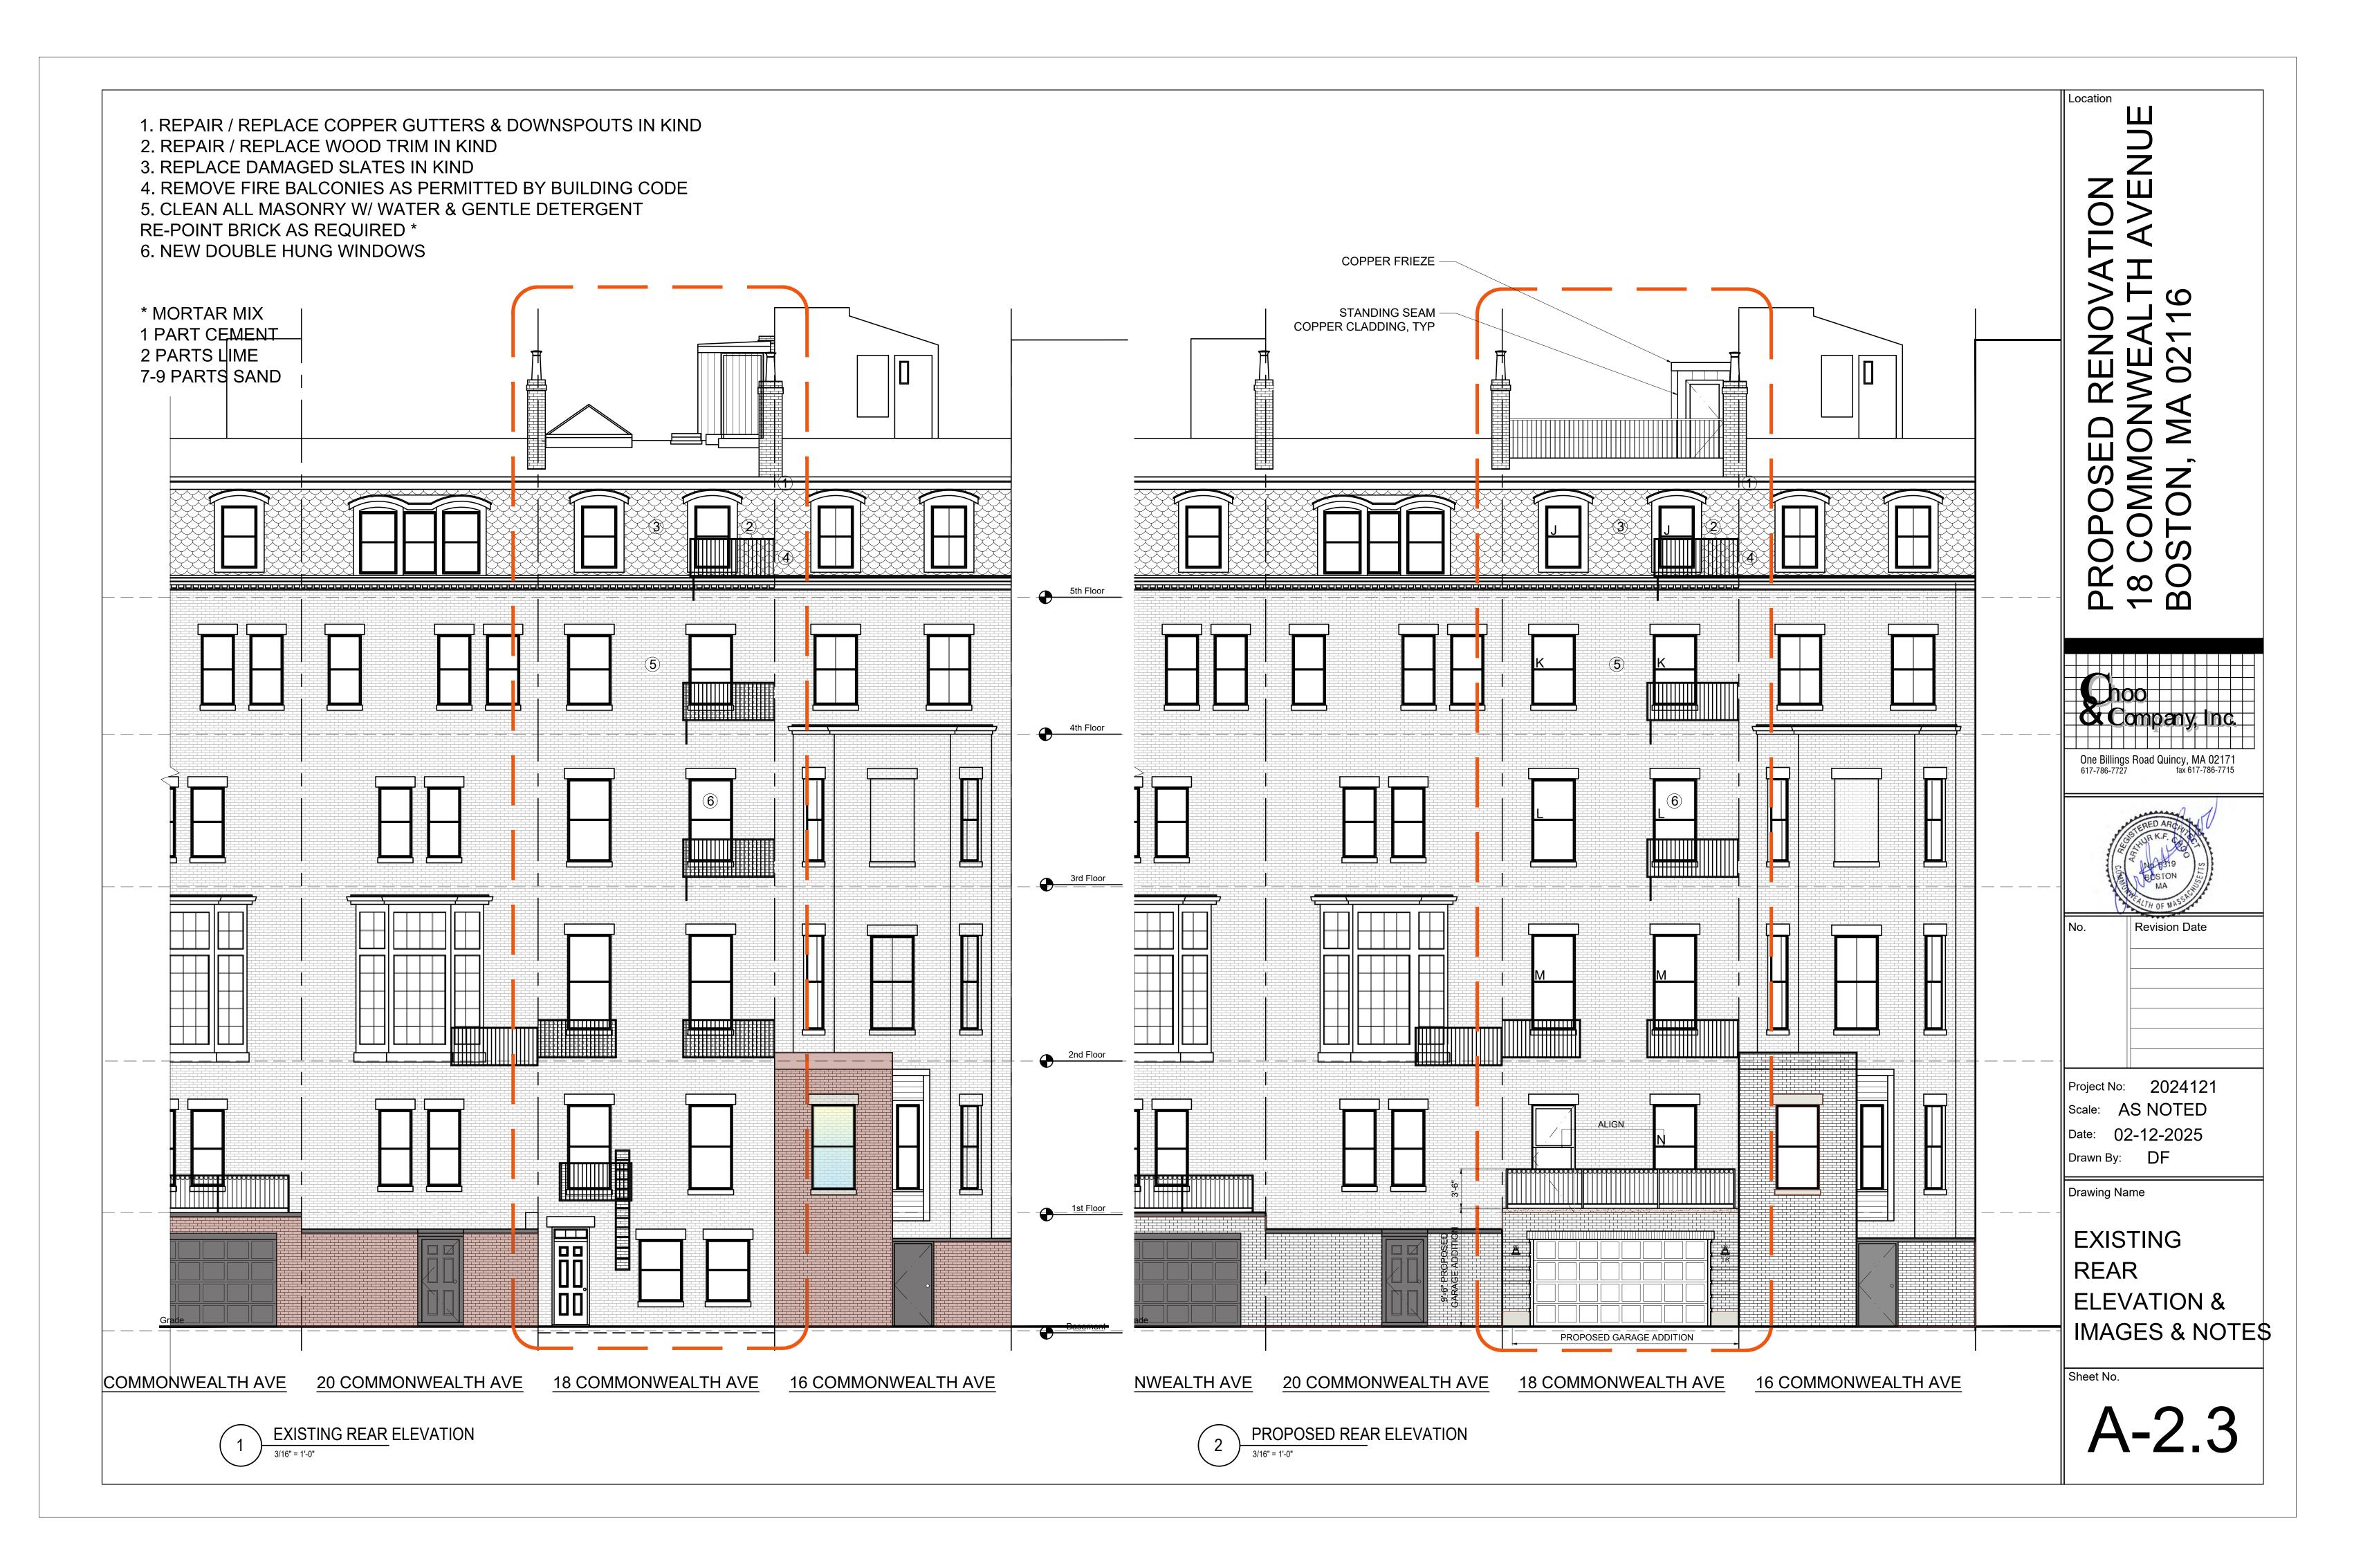


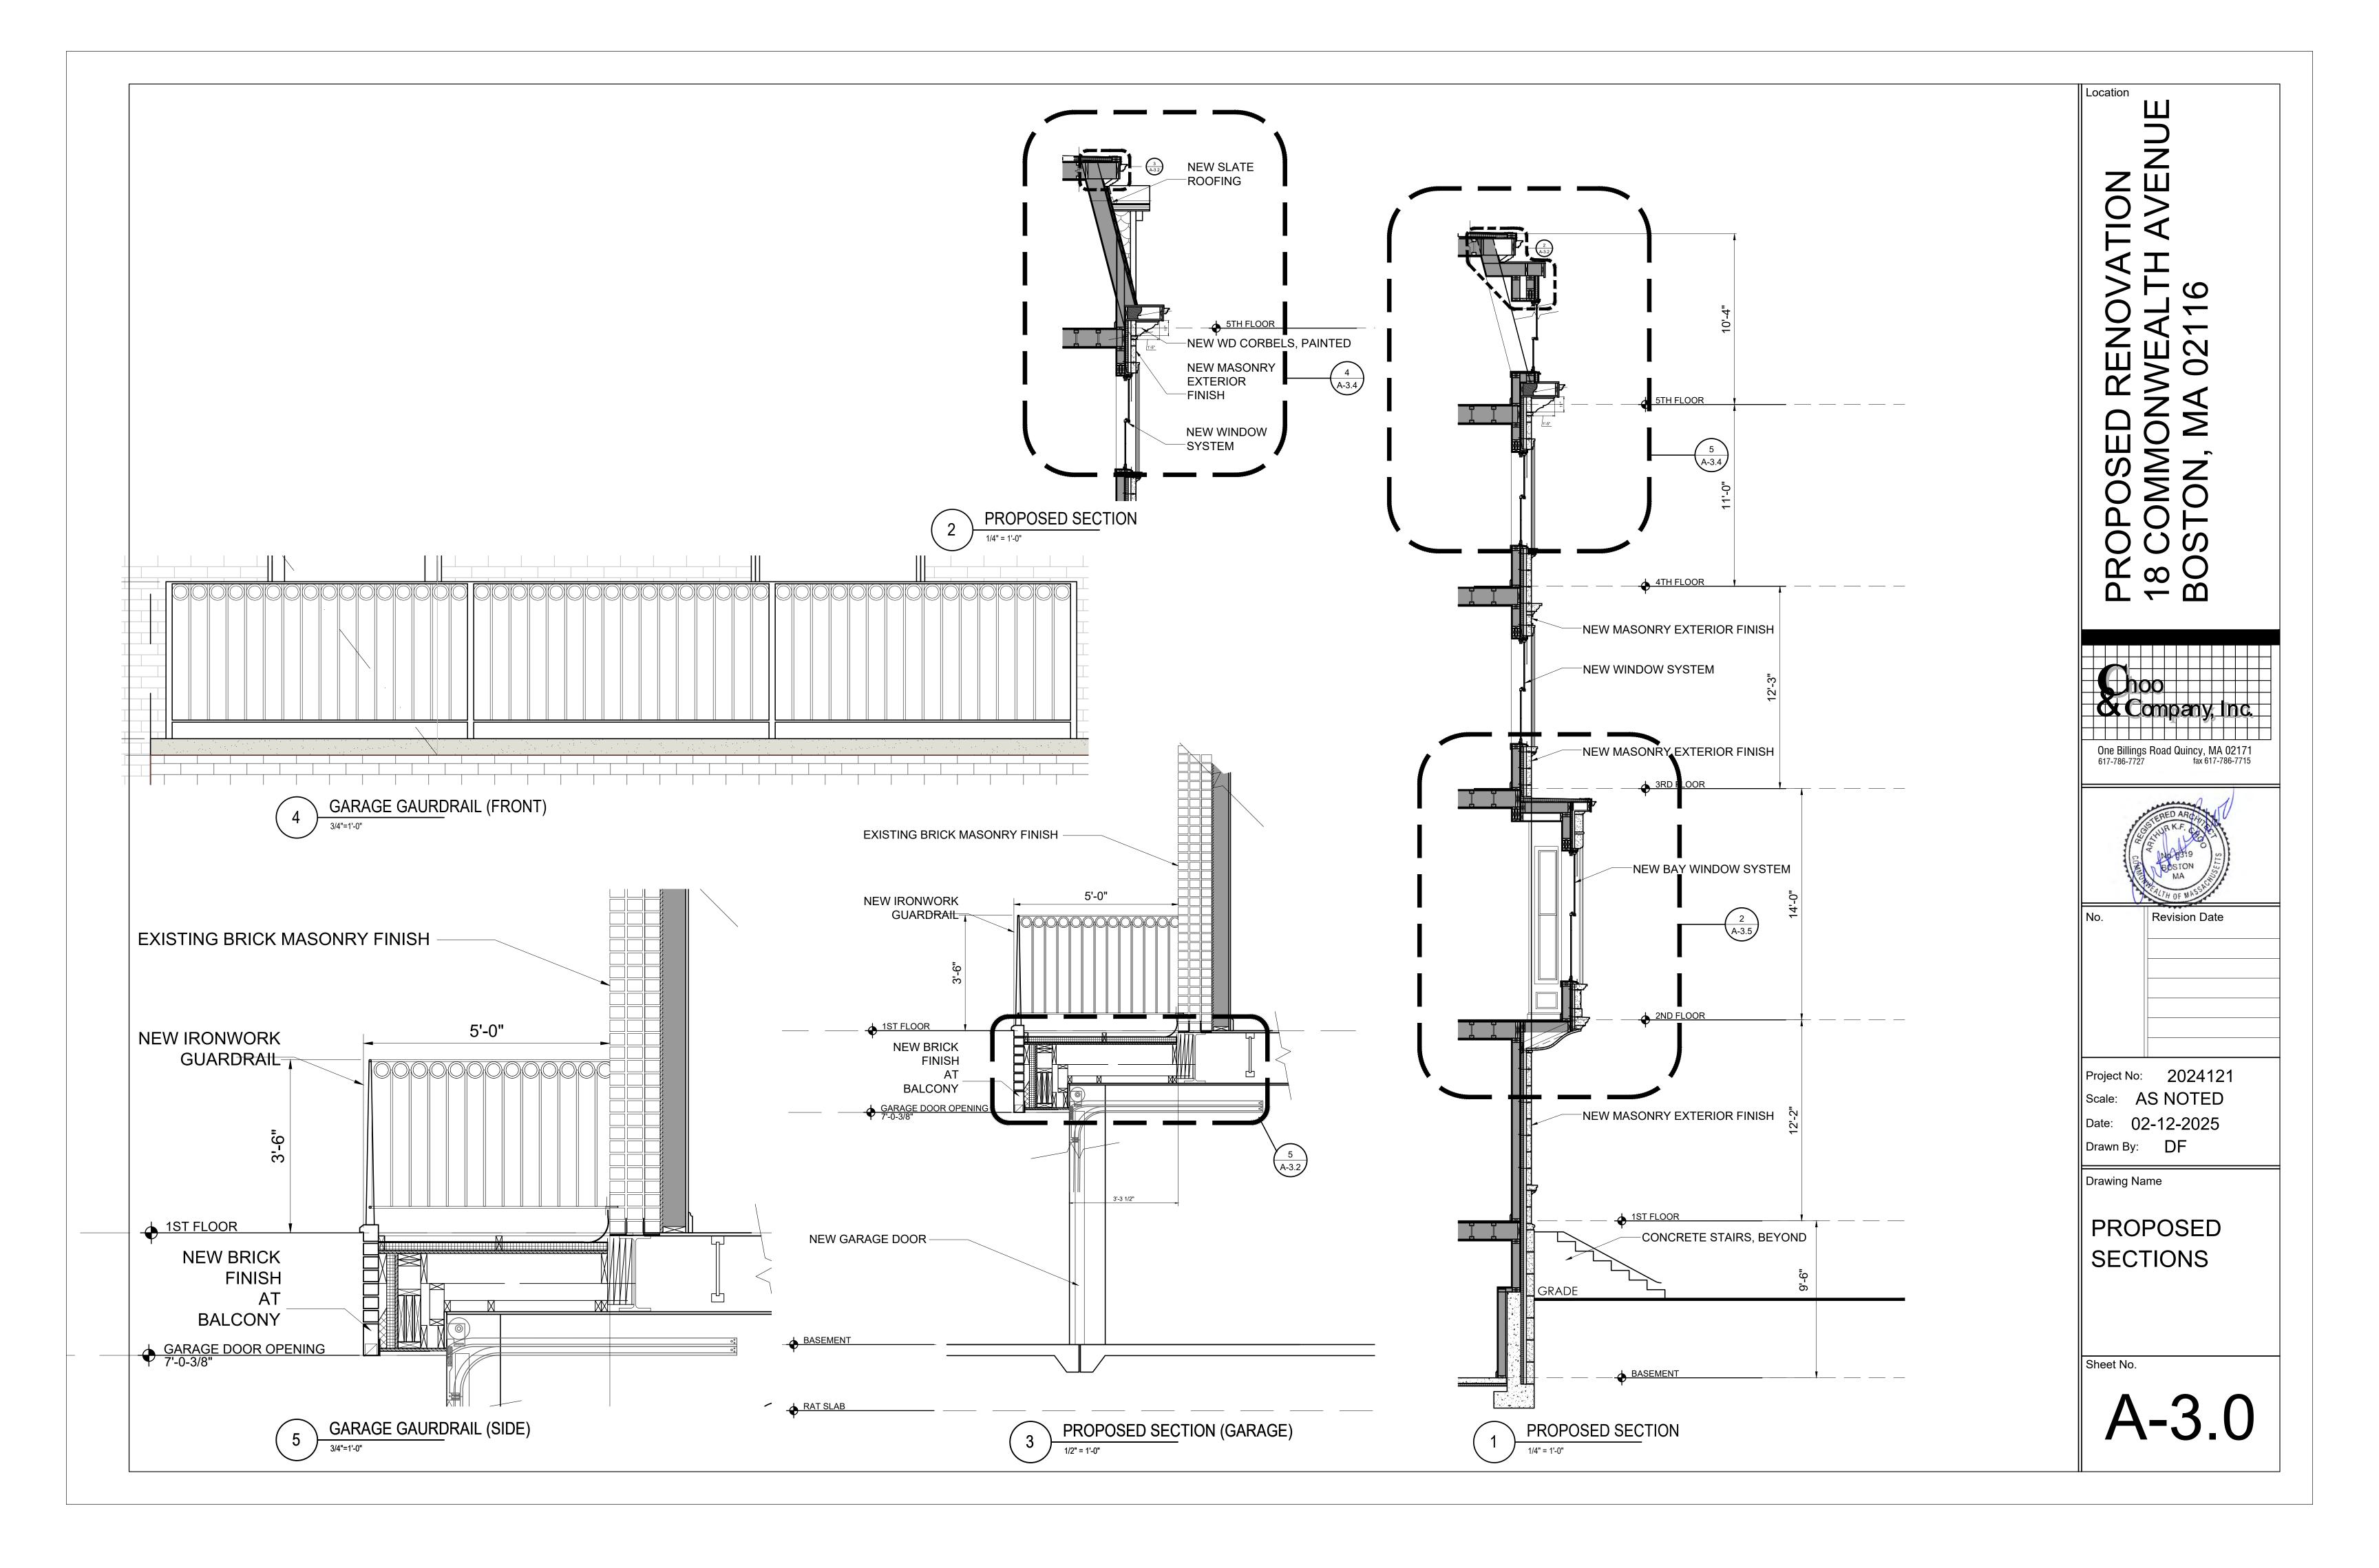

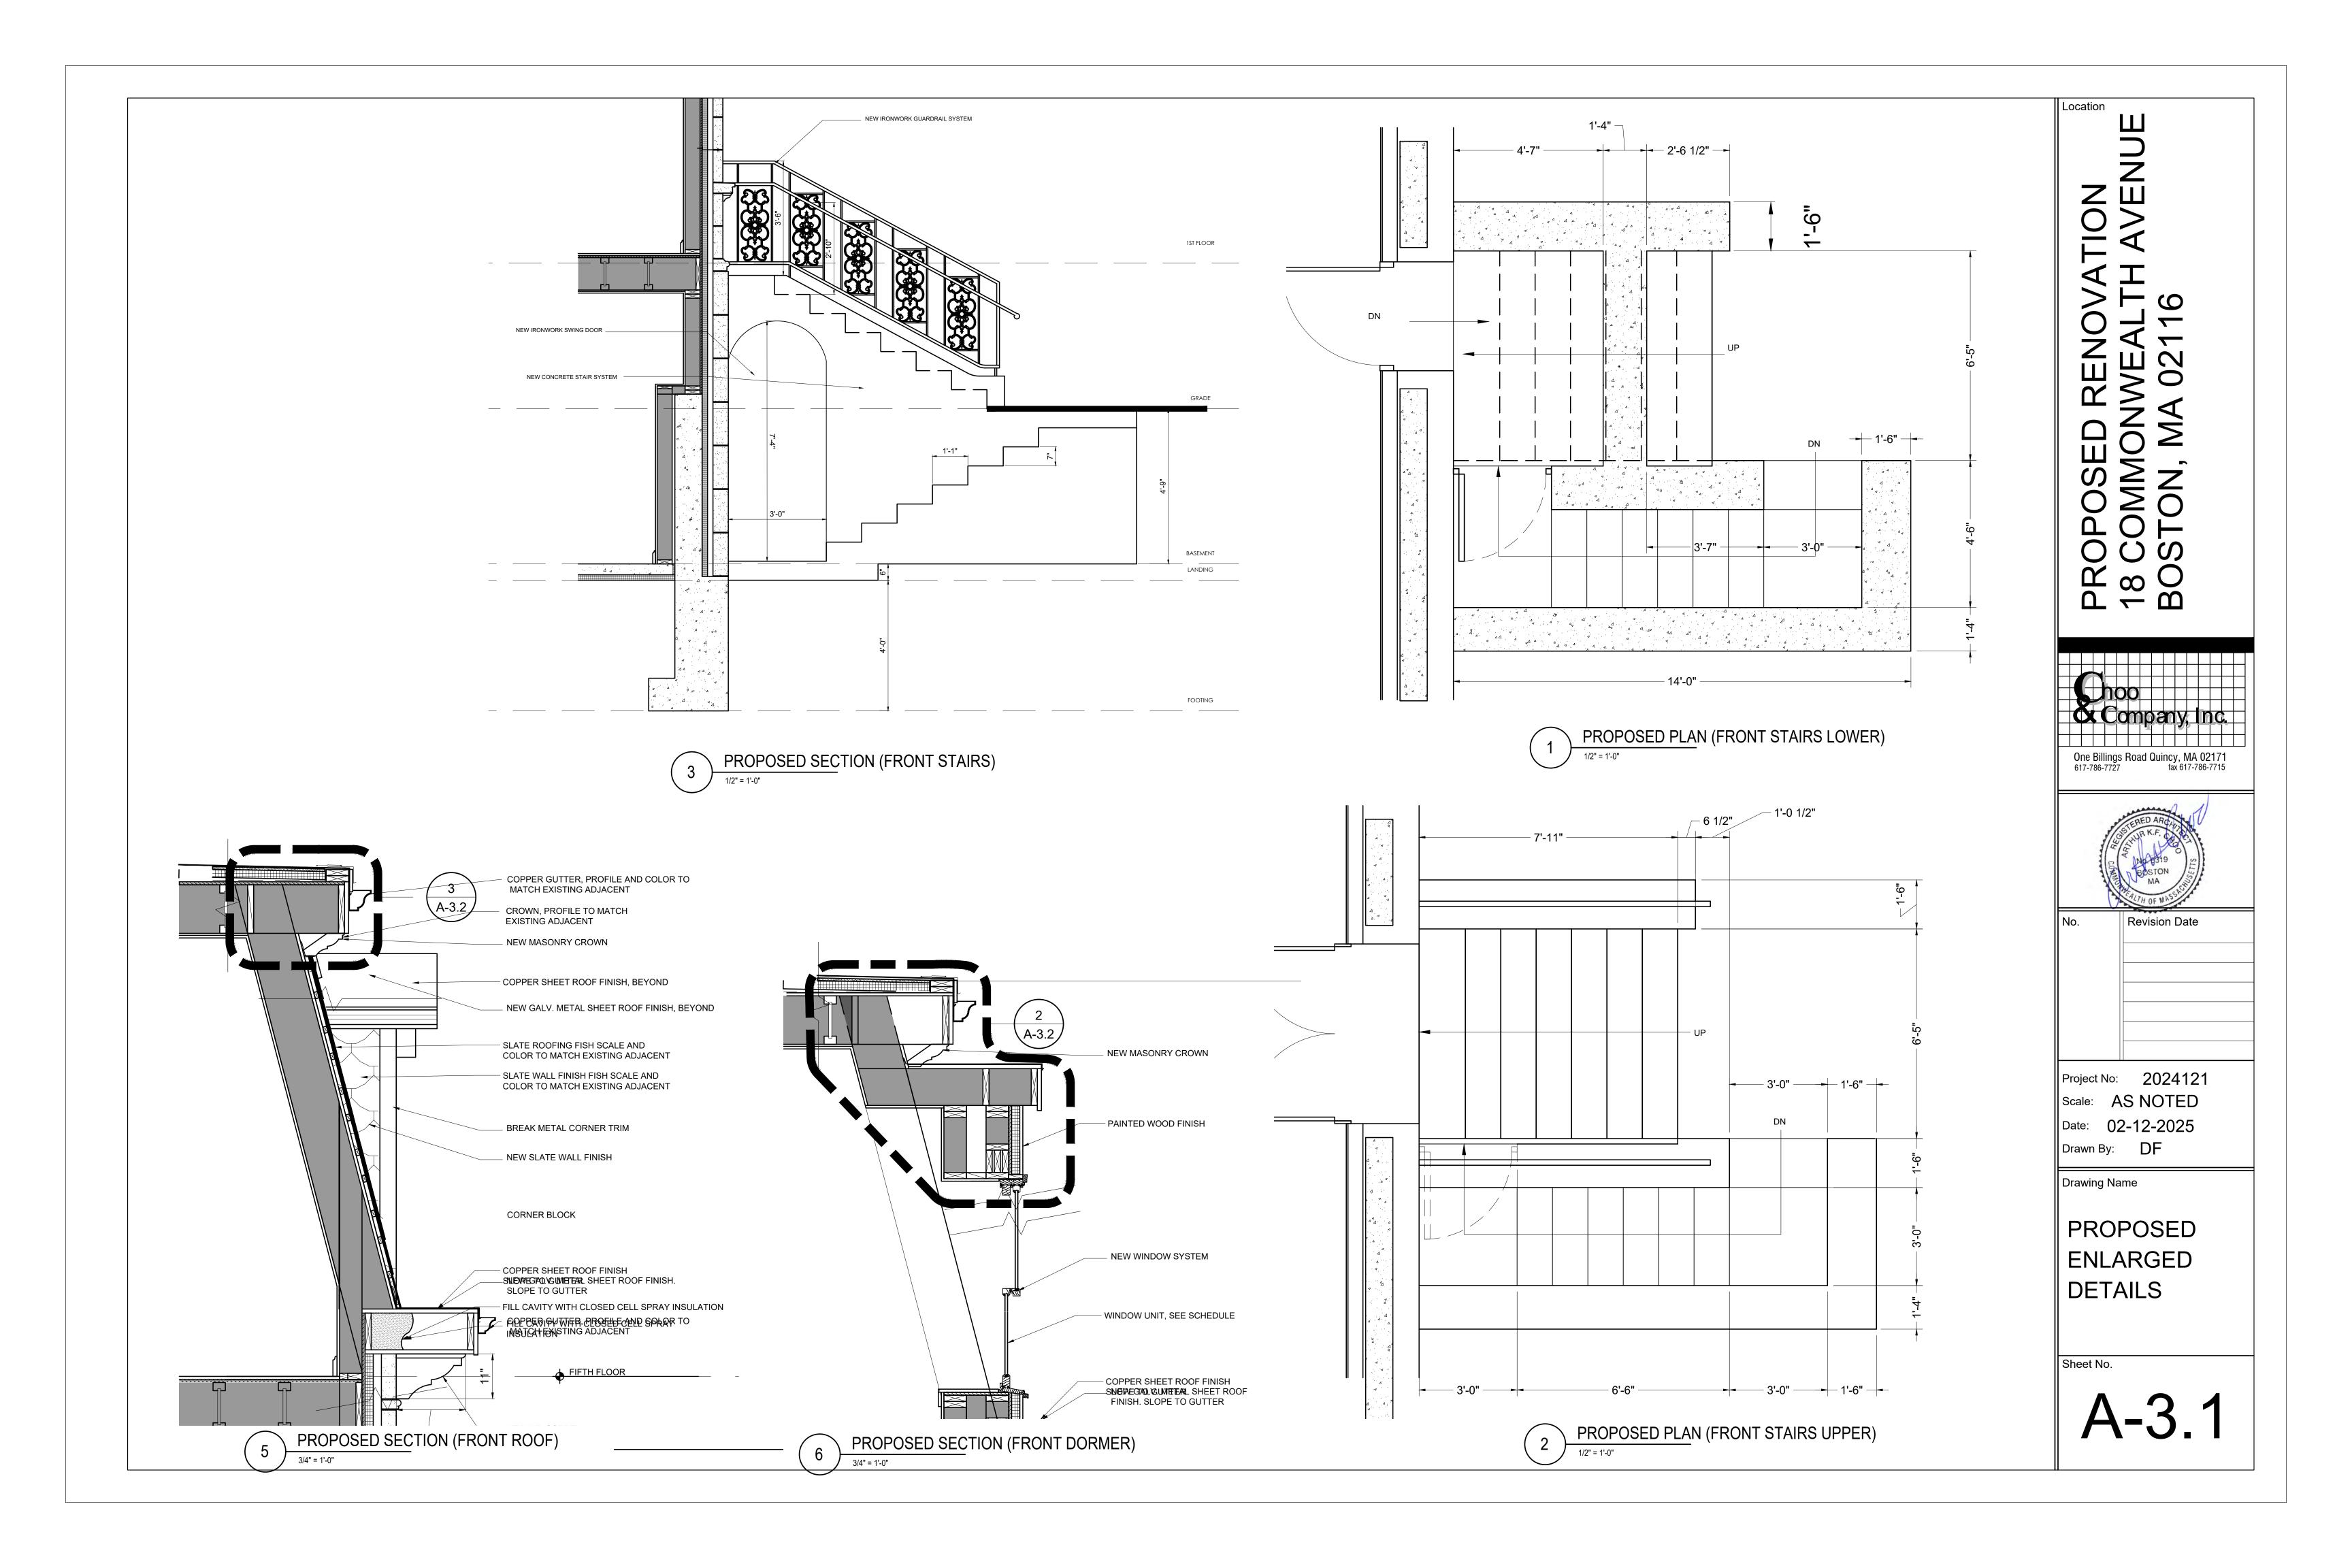

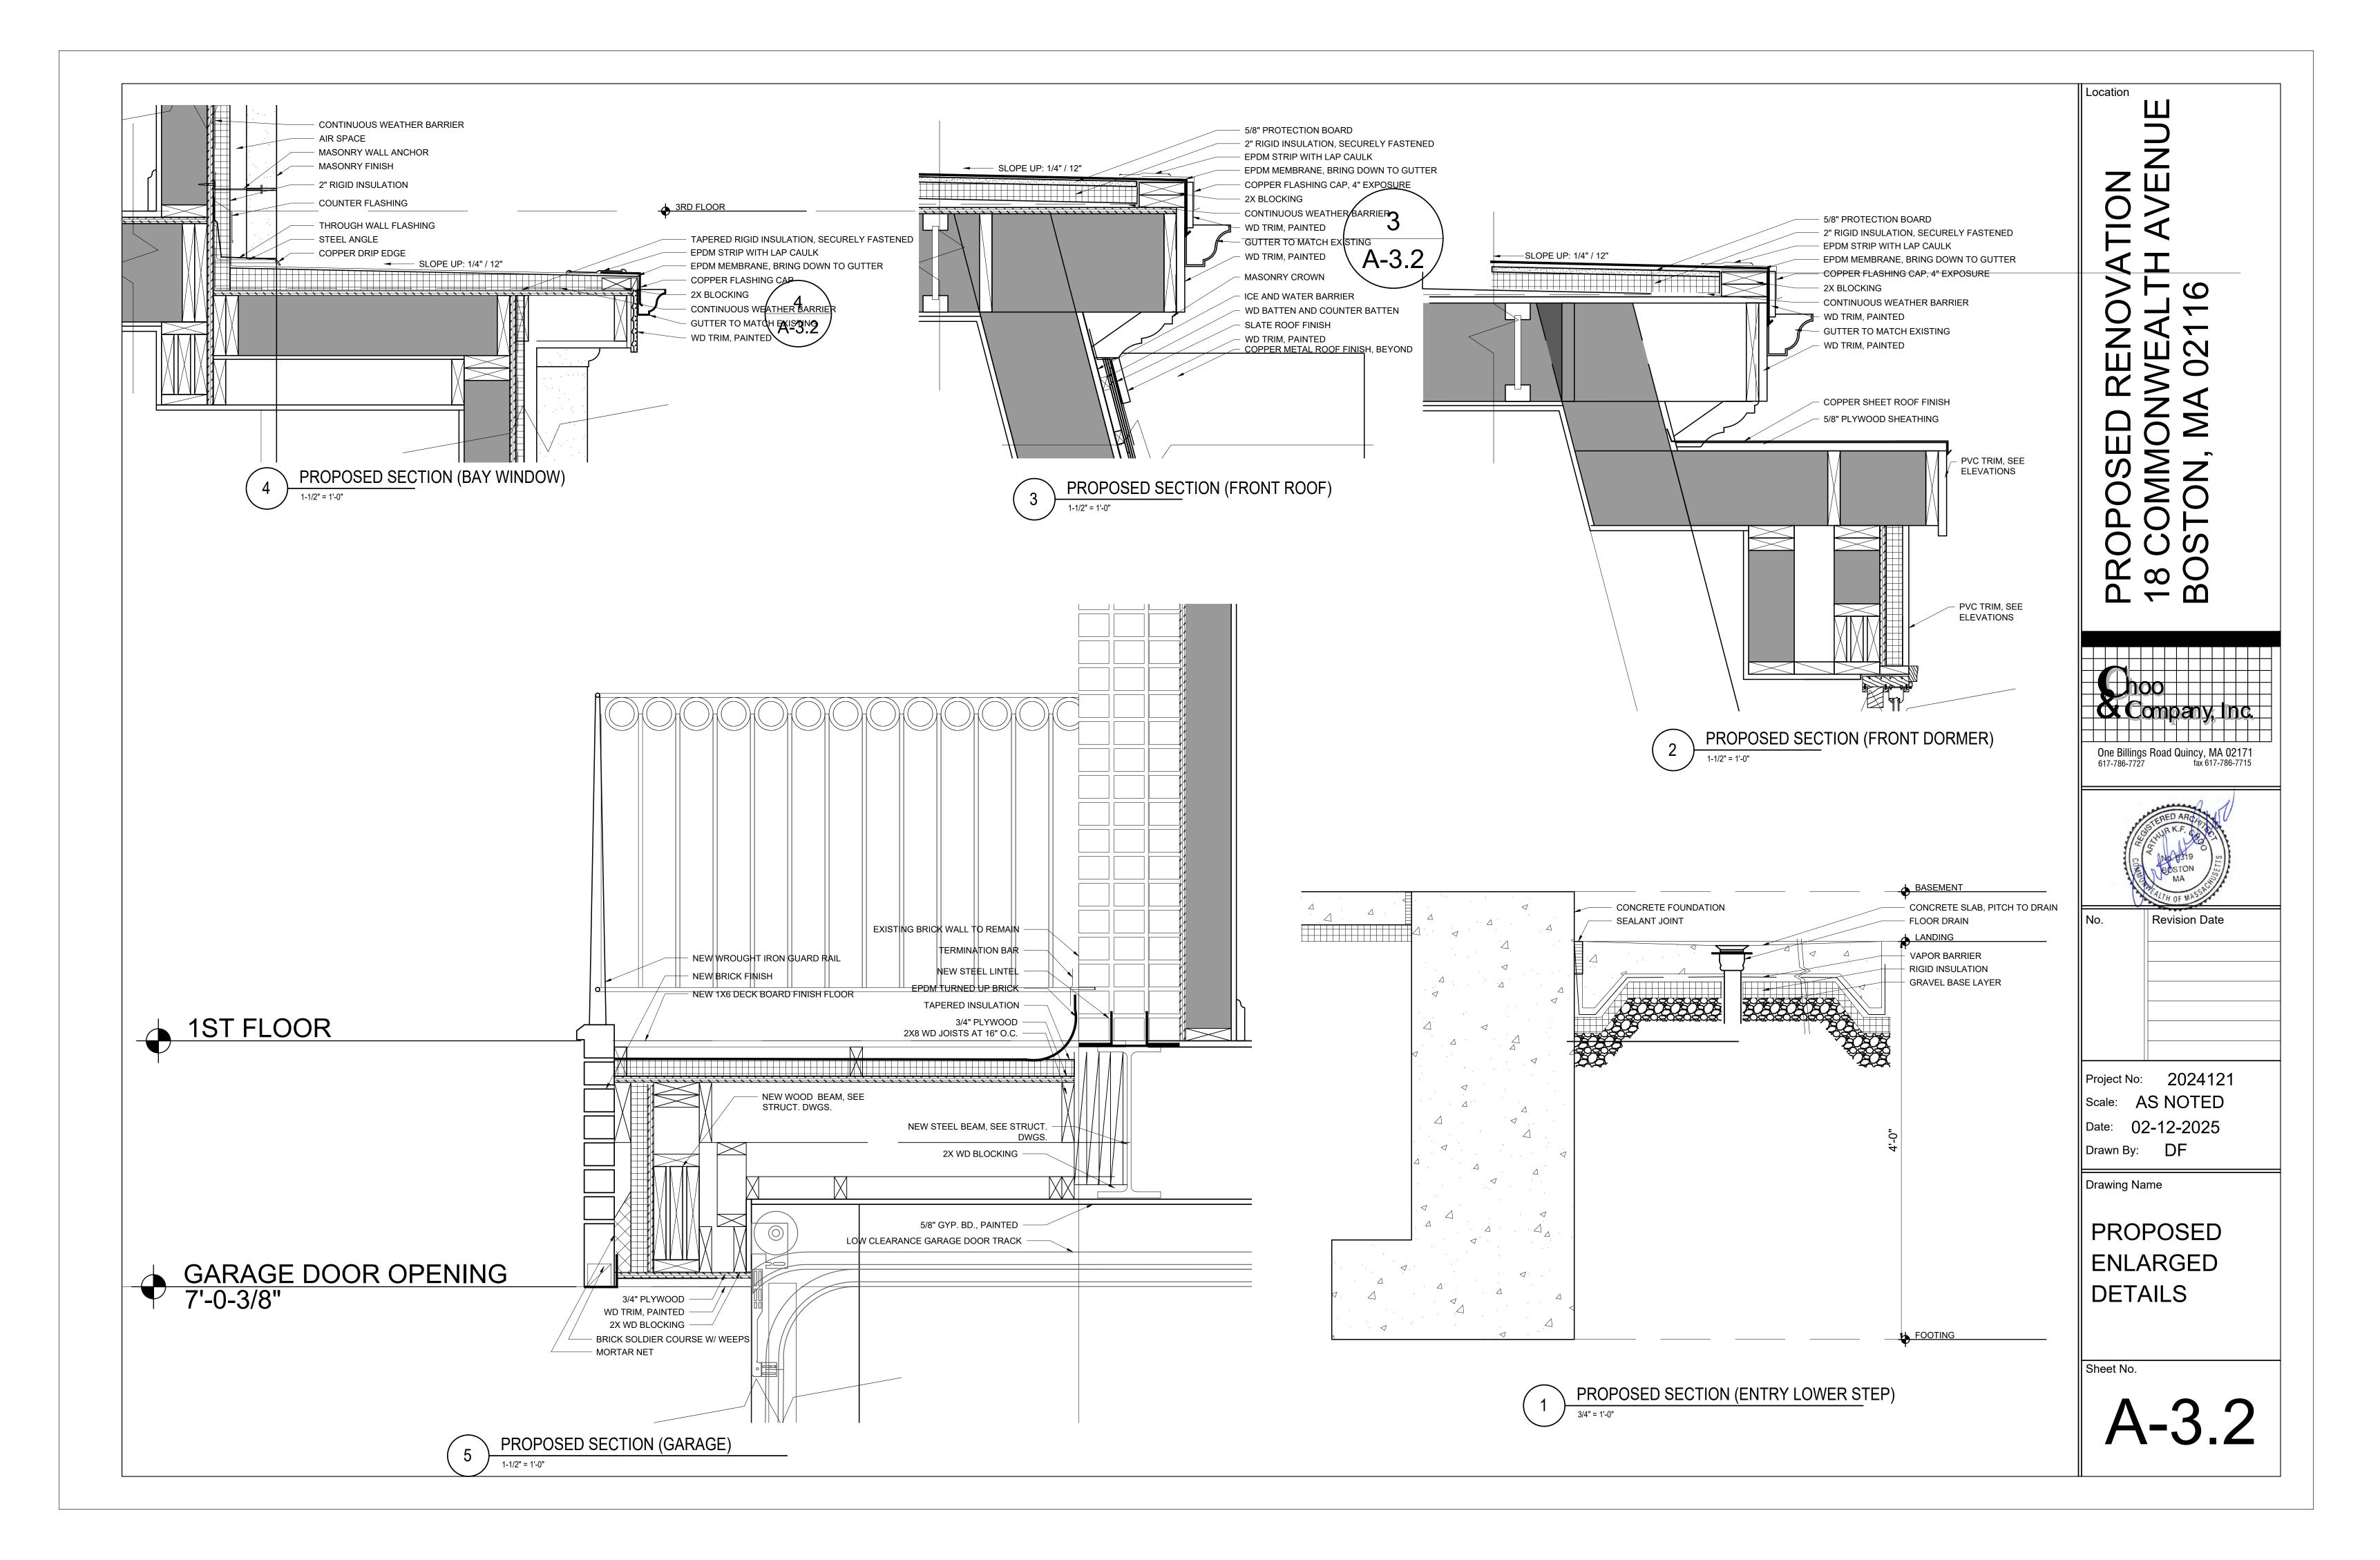

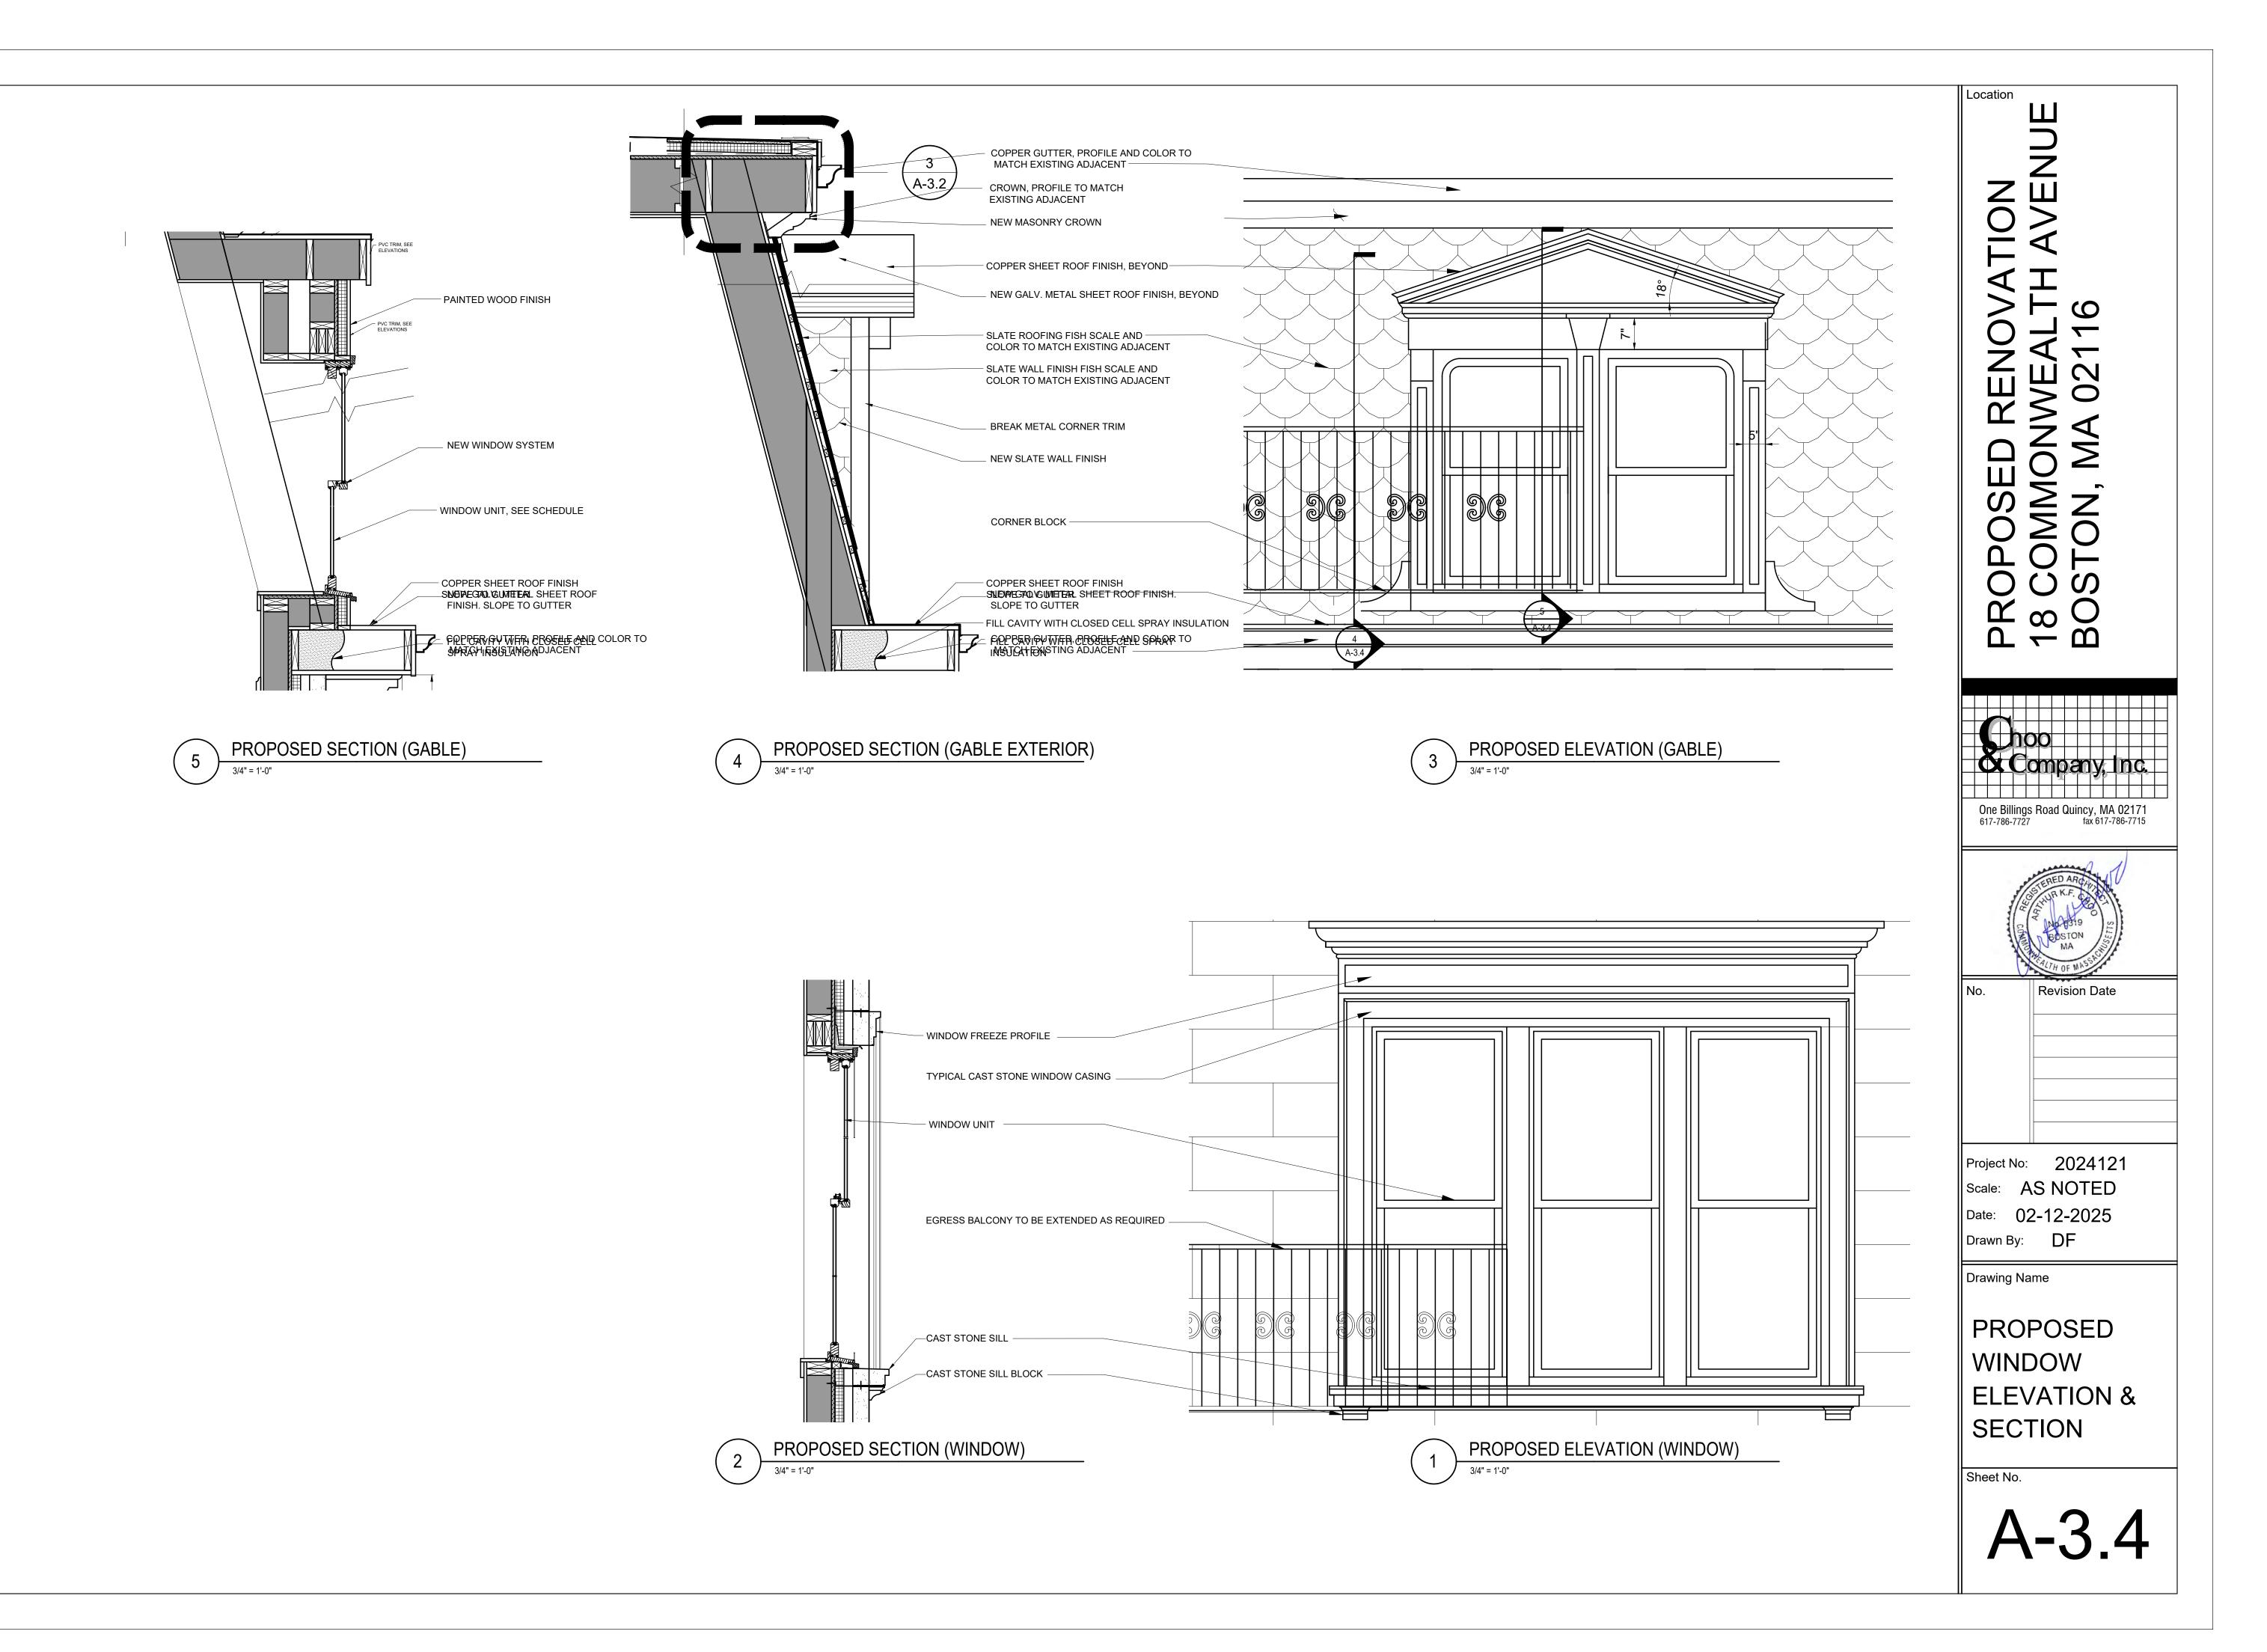

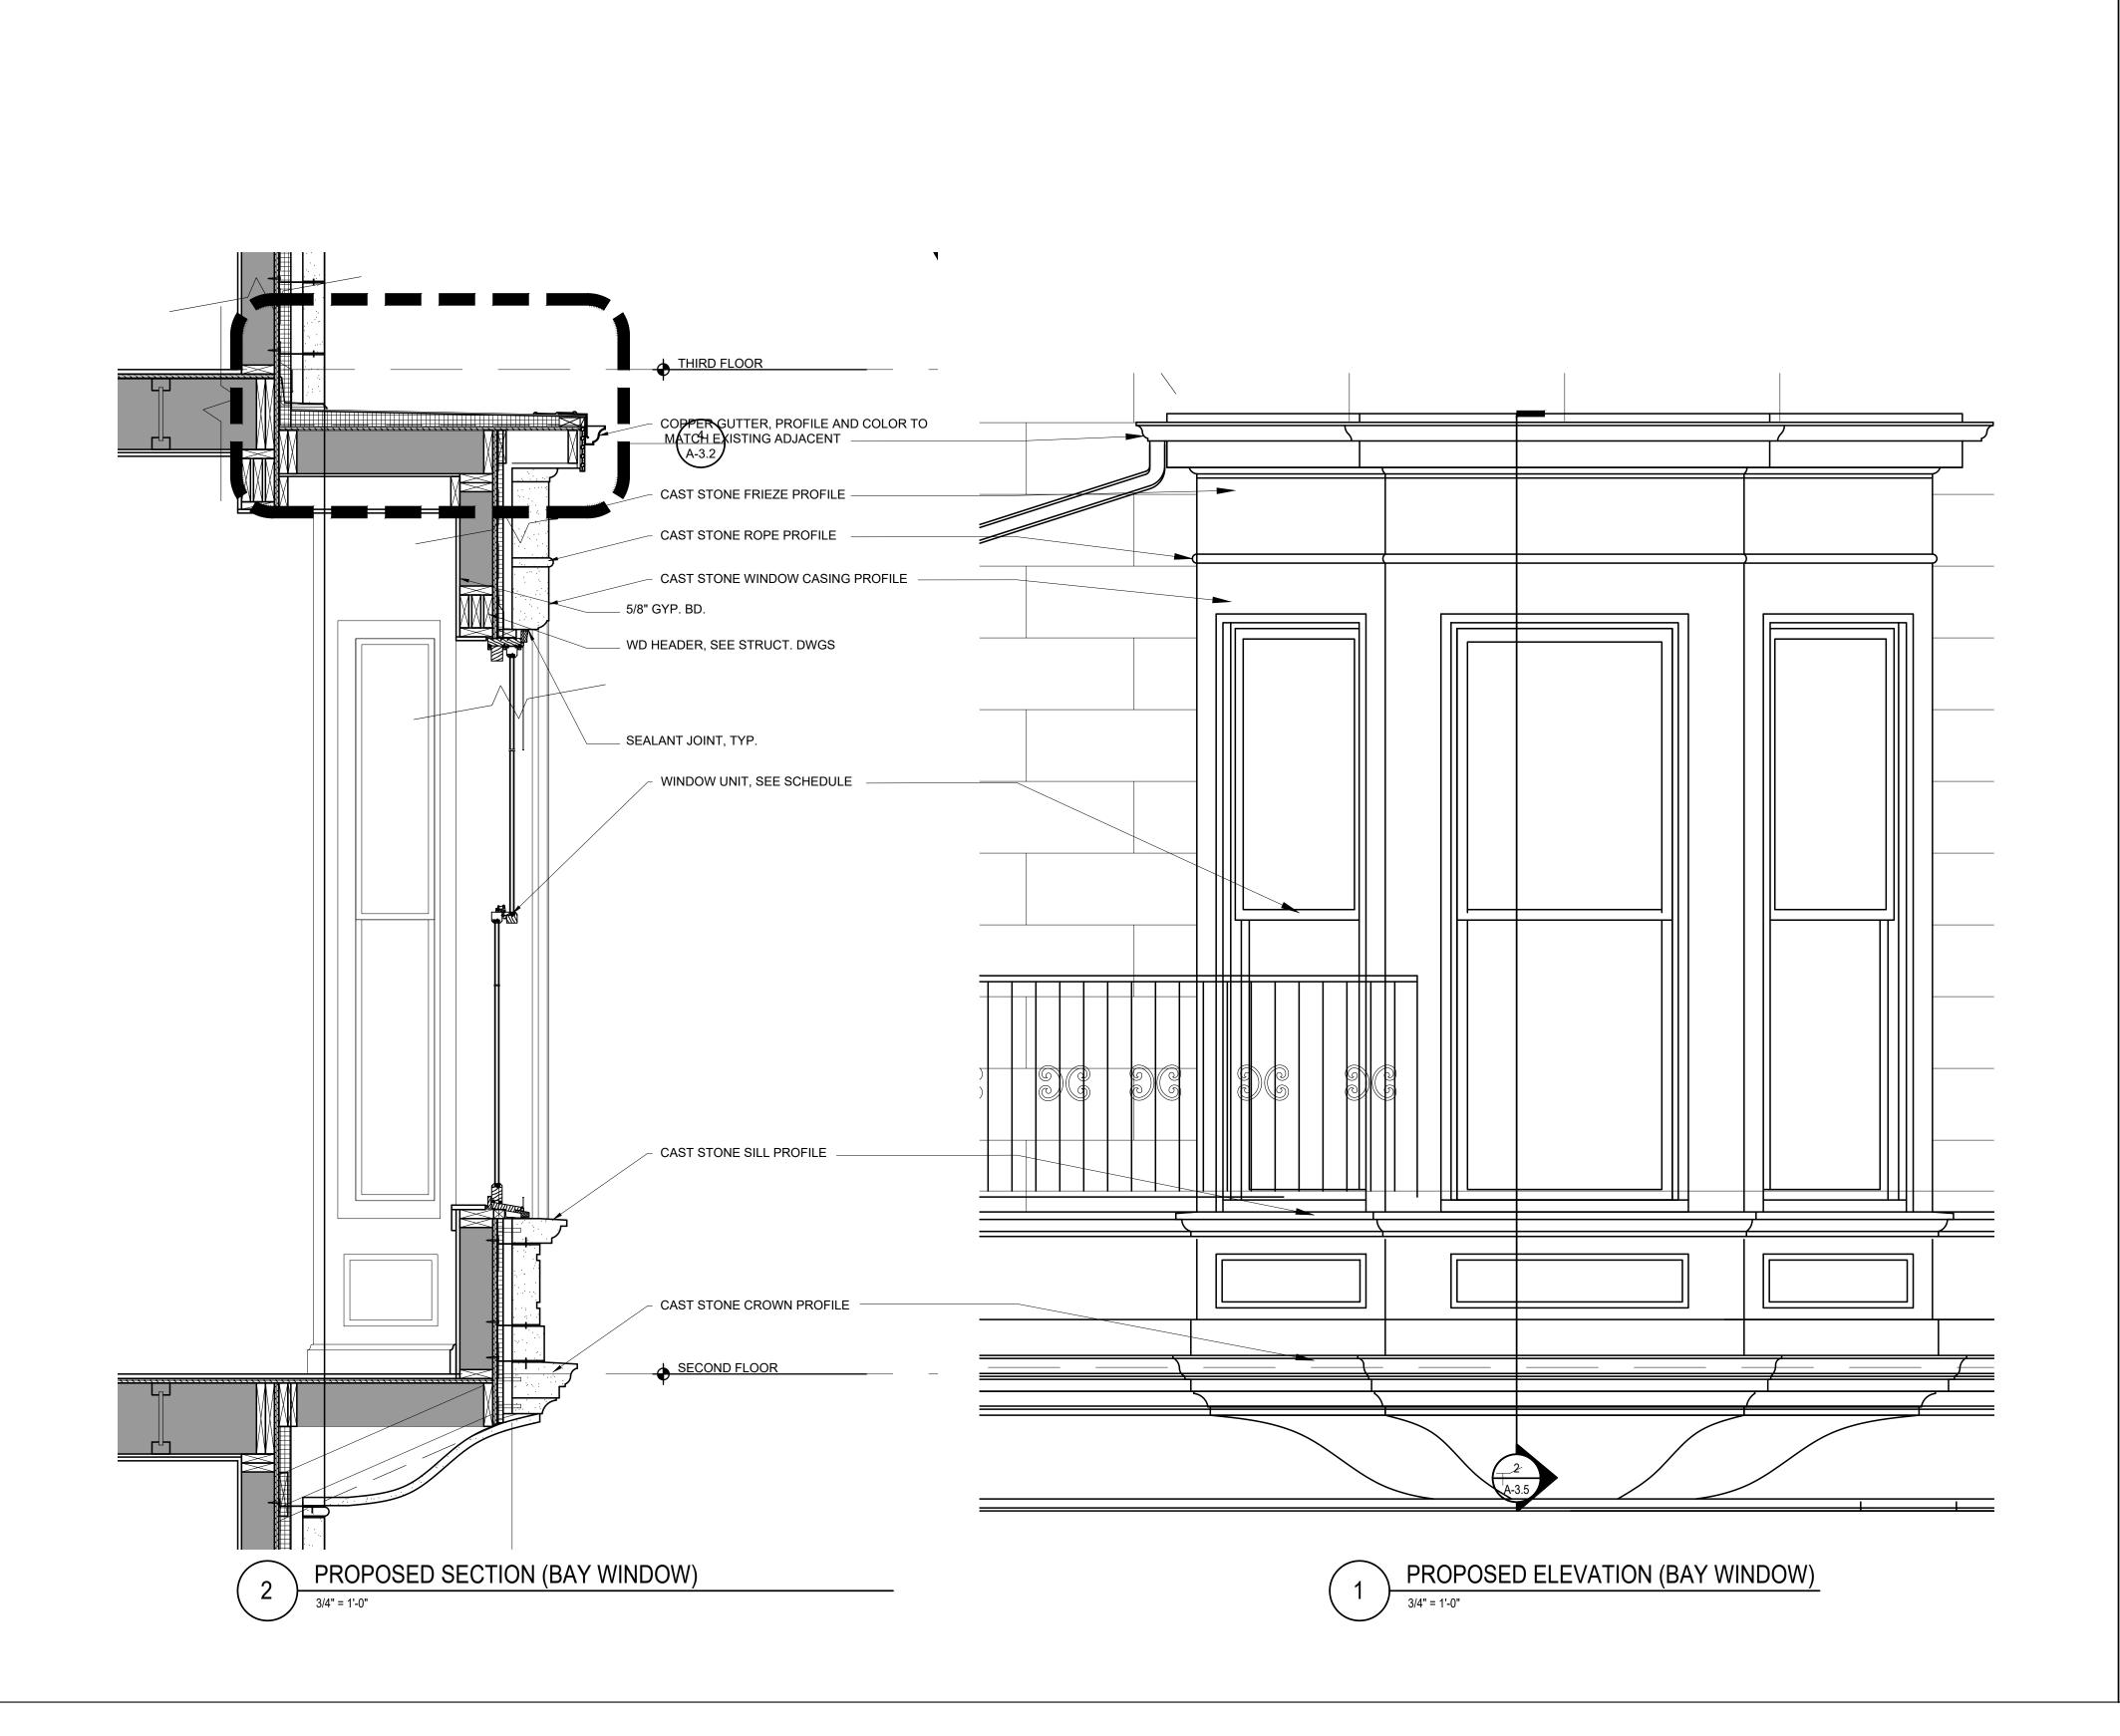

18 COMMONWEALTH AVENUI BOSTON, MA 02116

One Billings Road Quincy, MA 02171
617-786-7727 fax 617-786-7715



Revision Date


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Date: 02-12-2025
Drawn By: DF


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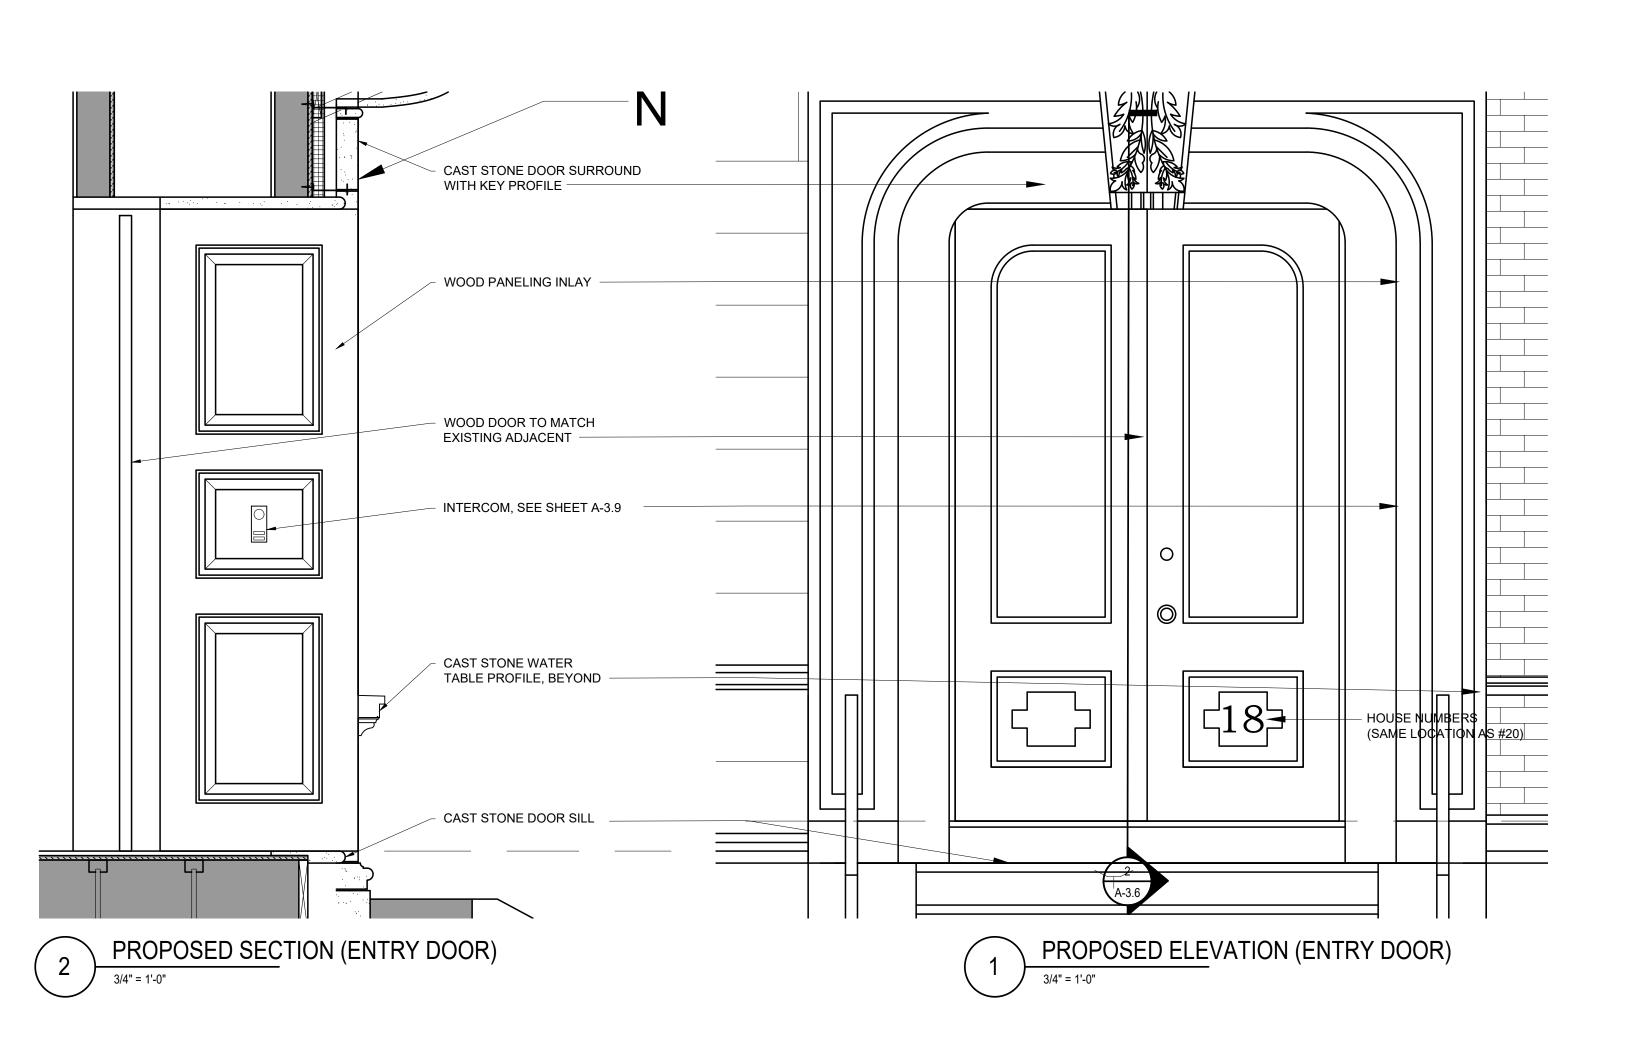
PROPOSED
WINDOW
ELEVATION &
SECTION

Sheet No.

A-3.5



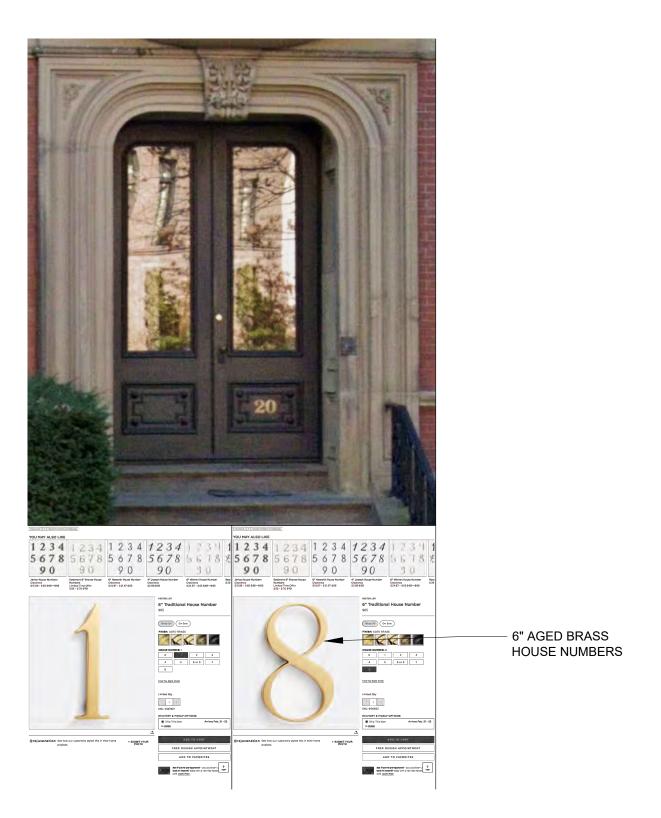

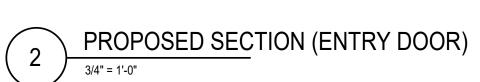

PROPOSED 18 COMMON BOSTON, MA

One Billings Road Quincy, MA 02171 617-786-7727 fax 617-786-7715



Revision Date


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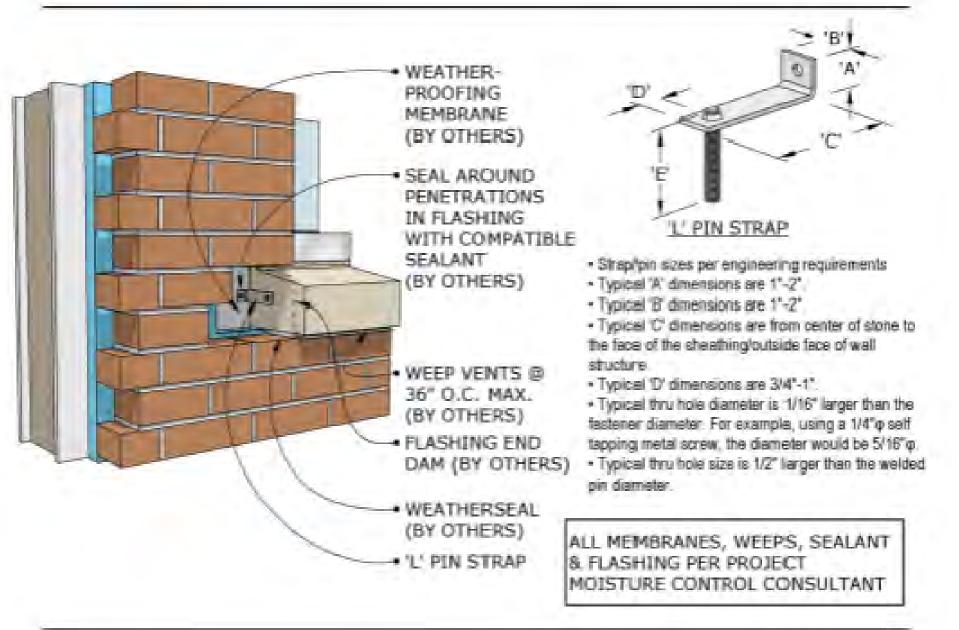
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Drawn By: DF

PROPOSED ENTRY DOOR **ELEVATION &** SECTION

Sheet No.



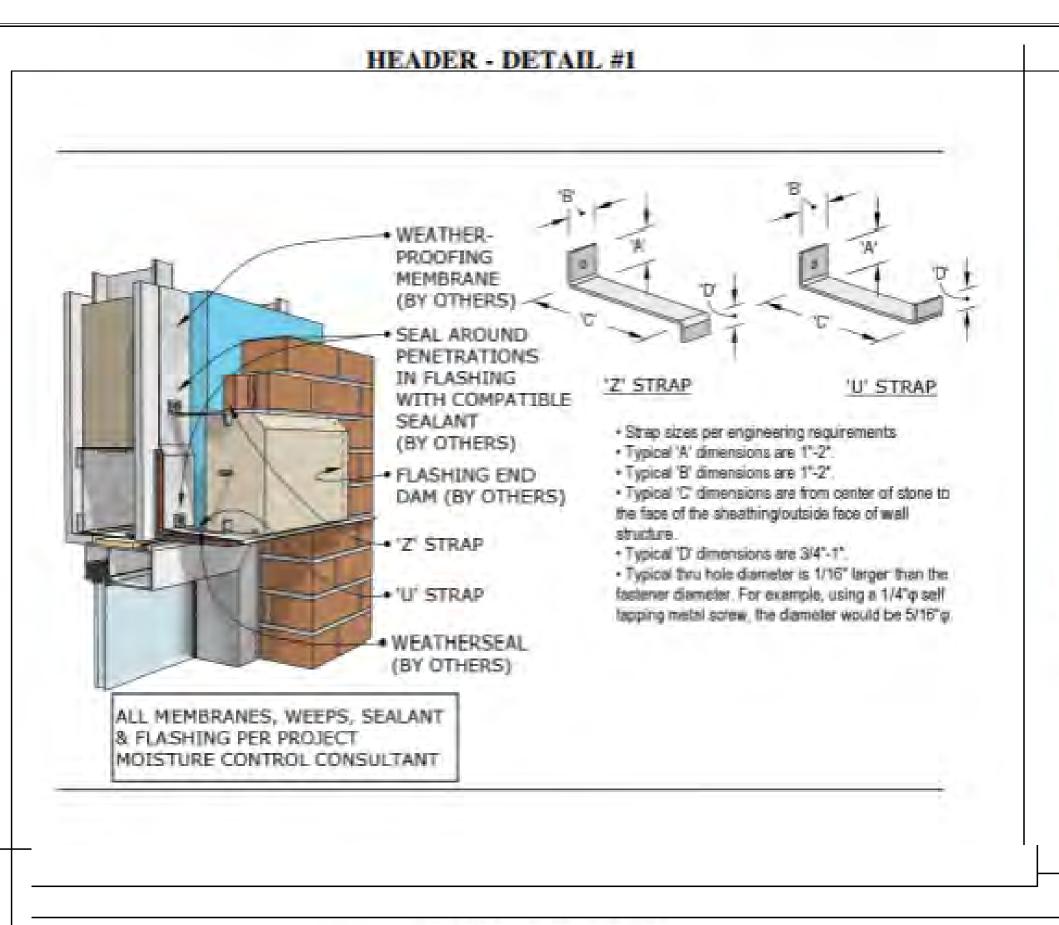

SILL - DETAIL #1



Location





Revision Date


Project No: 2024121

Scale: AS NOTED 02-12-2025 Drawn By:

Drawing Name

GENERAL SLATE AND **MASONRY DETAILS**

Sheet No.

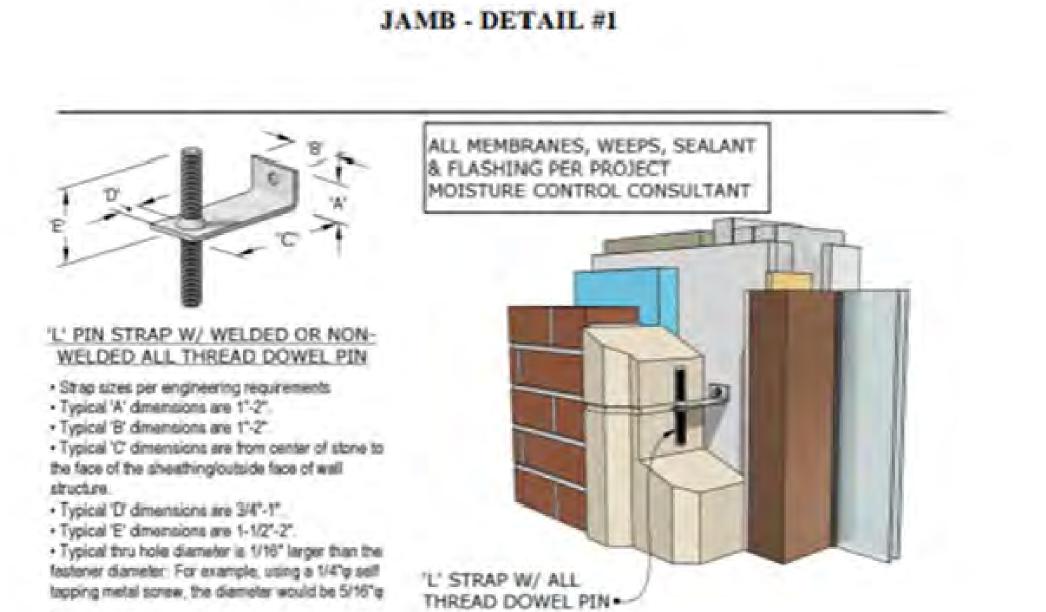

SLATES EAVES AND UNDEREAVES BATTENS INSULATION OMITTED FOR CLARITY VENTILATION SPACER TILTING FILLET - WALL PLATE UNDERLAY CARRIED INFO GUTTER CAVITY CLOSER CAVITY INSULATION Code 5 lead flashing over slate and under water proof roof covering by a minimum of 100mm AIR FLOW STEEL COLUMN SOFFIT VENTILATION 10MM GAP _50mm wide copper straps at 300 - 500mm centres depending on WITH 1HR RATED SPRAY-APPLIED FIREPROOFING WRAP **BOTTOM 14" IN CONCRETE TYPICAL** fixing in accordance with manufacturer's printed instructions, BS5534 part 1, BS8000 part 6 1990 and H62 / 210 and 275 1. FIX THE UNDERLAY TO EXTEND OVER THE TILTING FILLET AND FASCIA BOARD INTO THE GUTTER. THE UNDERLAY SHOULD OVERHANG THE FASCIA BOARD BY AT LEAST 50MM.
2. FIX THE FIRST FULL COURSE BATTEN (EAVES BATTEN) SO THAT THE TAILS OF THE SLATES IN THE EAVES AND THE UNDEREAVES COURSES ALIGN. FIX THE UNDEREAVES BATTEN IMMEDIATELY BELOW THE EAVES BATTEN.
3. LAY THE SLATES FORMING THE UNDERCOURSE ON THEIR BACKS AND HEAD NAIL THEM TO THE UNDEREAVES BATTEN.
4. FIX THE EAVES COURSE WITH THE TAILS OF THE SLATES ALIGNING WITH THE TAILS OF THE SLATES IN THE UNDEREAVES COURSE.

SLATING AS STANDARD EAVES DETAIL-

CODE 5 LEAD APRON FLASHING FIXING IN ACCORDANCE WITH MANUFACTURER'S PRINTED INSTRUCTIONS, BS EN 12588:206

S PRINTED 1990 AND H62 /

TILTING FILLET


COMPLETE SLATING LOWER SLOPE AS FOR STANDARD ROOF UPPER EDGE.
 FIX LAYER BOARDS TO RAFTERS AT THE INTERSECTION OF THE TWO ROOFS, EQUAL IN THICKNESS TO THE BATTENS.
 FIX A TILTING FILLET TO THE TOP EDGE OF THE UPPER LAYER BOARD, EQUAL IN THICKNESS TO THE BATTENS.
 FIX CODE 5 LEAD APRON FLASHING OVER THE TILTING FILLET AND DRESS DOWN OVER THE HEADS OF THE SLATE BELOW BY AT LEAST 150MM.FIX COPPER STRAPS AT 300 - 500MM CENTRES.
 SLATE AND BATTEN UPPER SLOPE AS STANDARD EAVES WITH THE BOTTOM COURSE PROJECTING BELOW THE TILTING FILLET BY 50 TO 60MM.


ENLARGED SLATE SECTIONS (GENERAL)


ENLARGED SLATE SECTIONS (GENERAL)


LAYER BOARDS


Water proof roof covering Lay Code 5 x 240mm (min) girth flashing over top course of slate and onto flat roof as detail

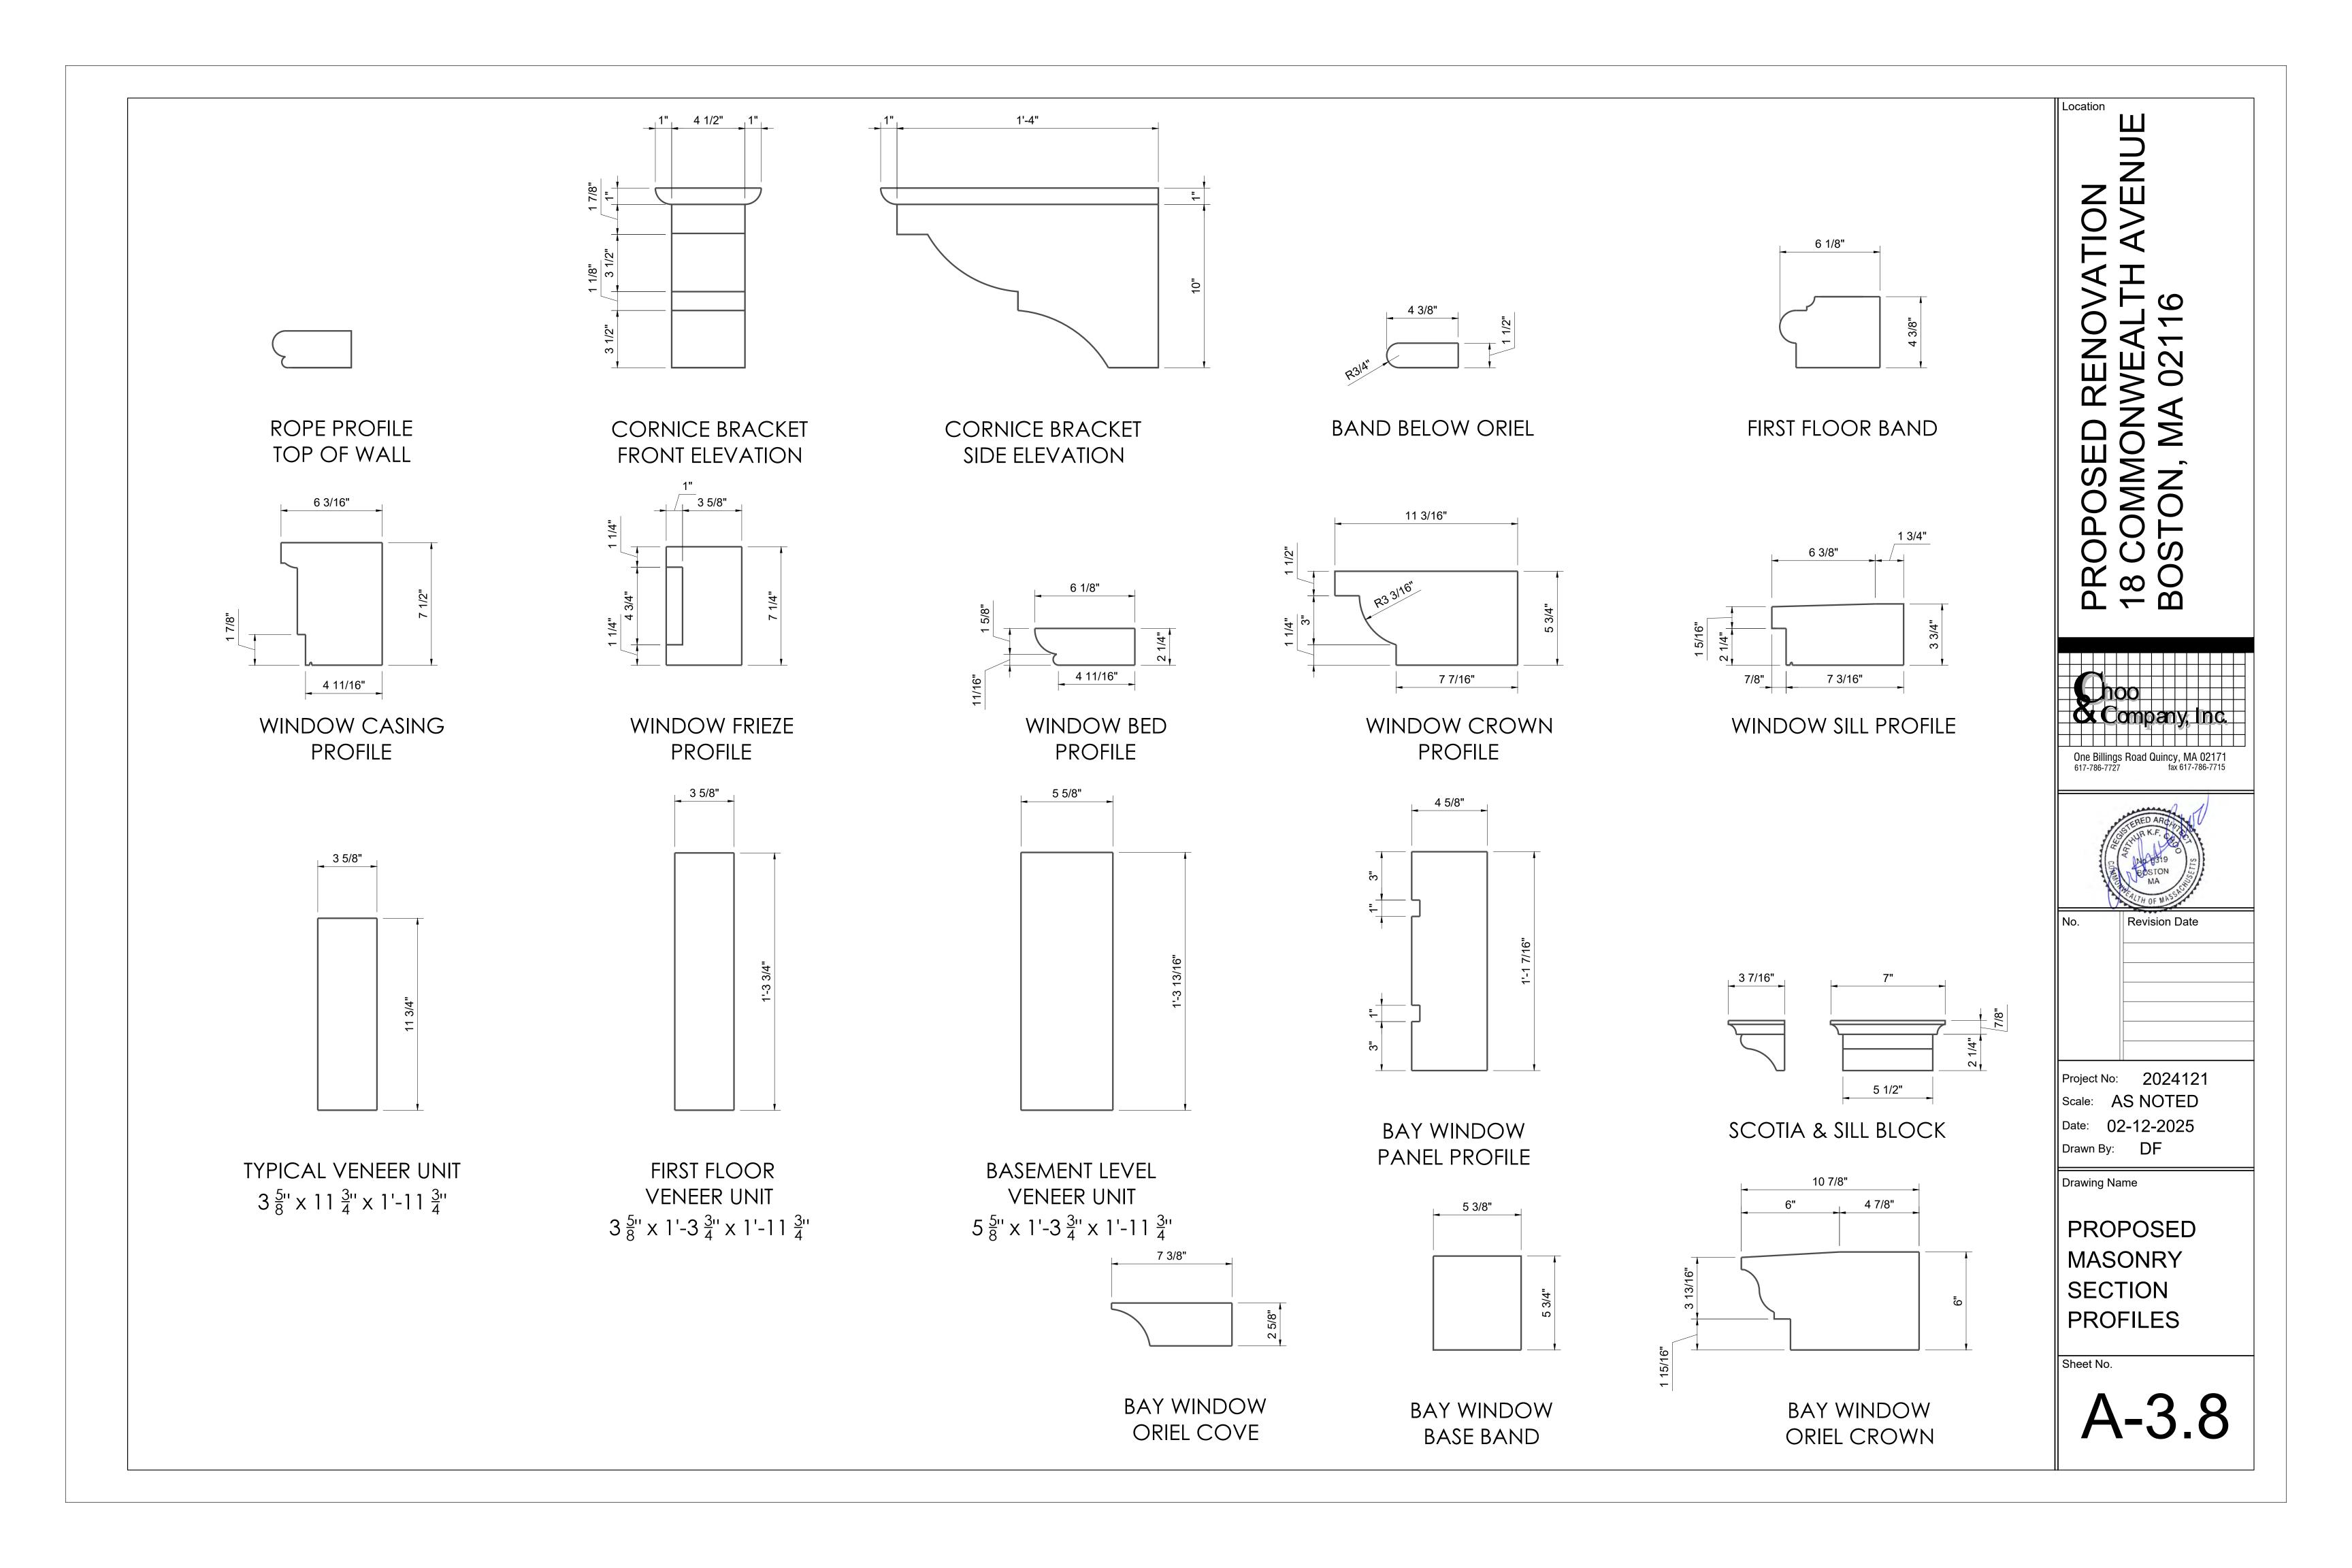


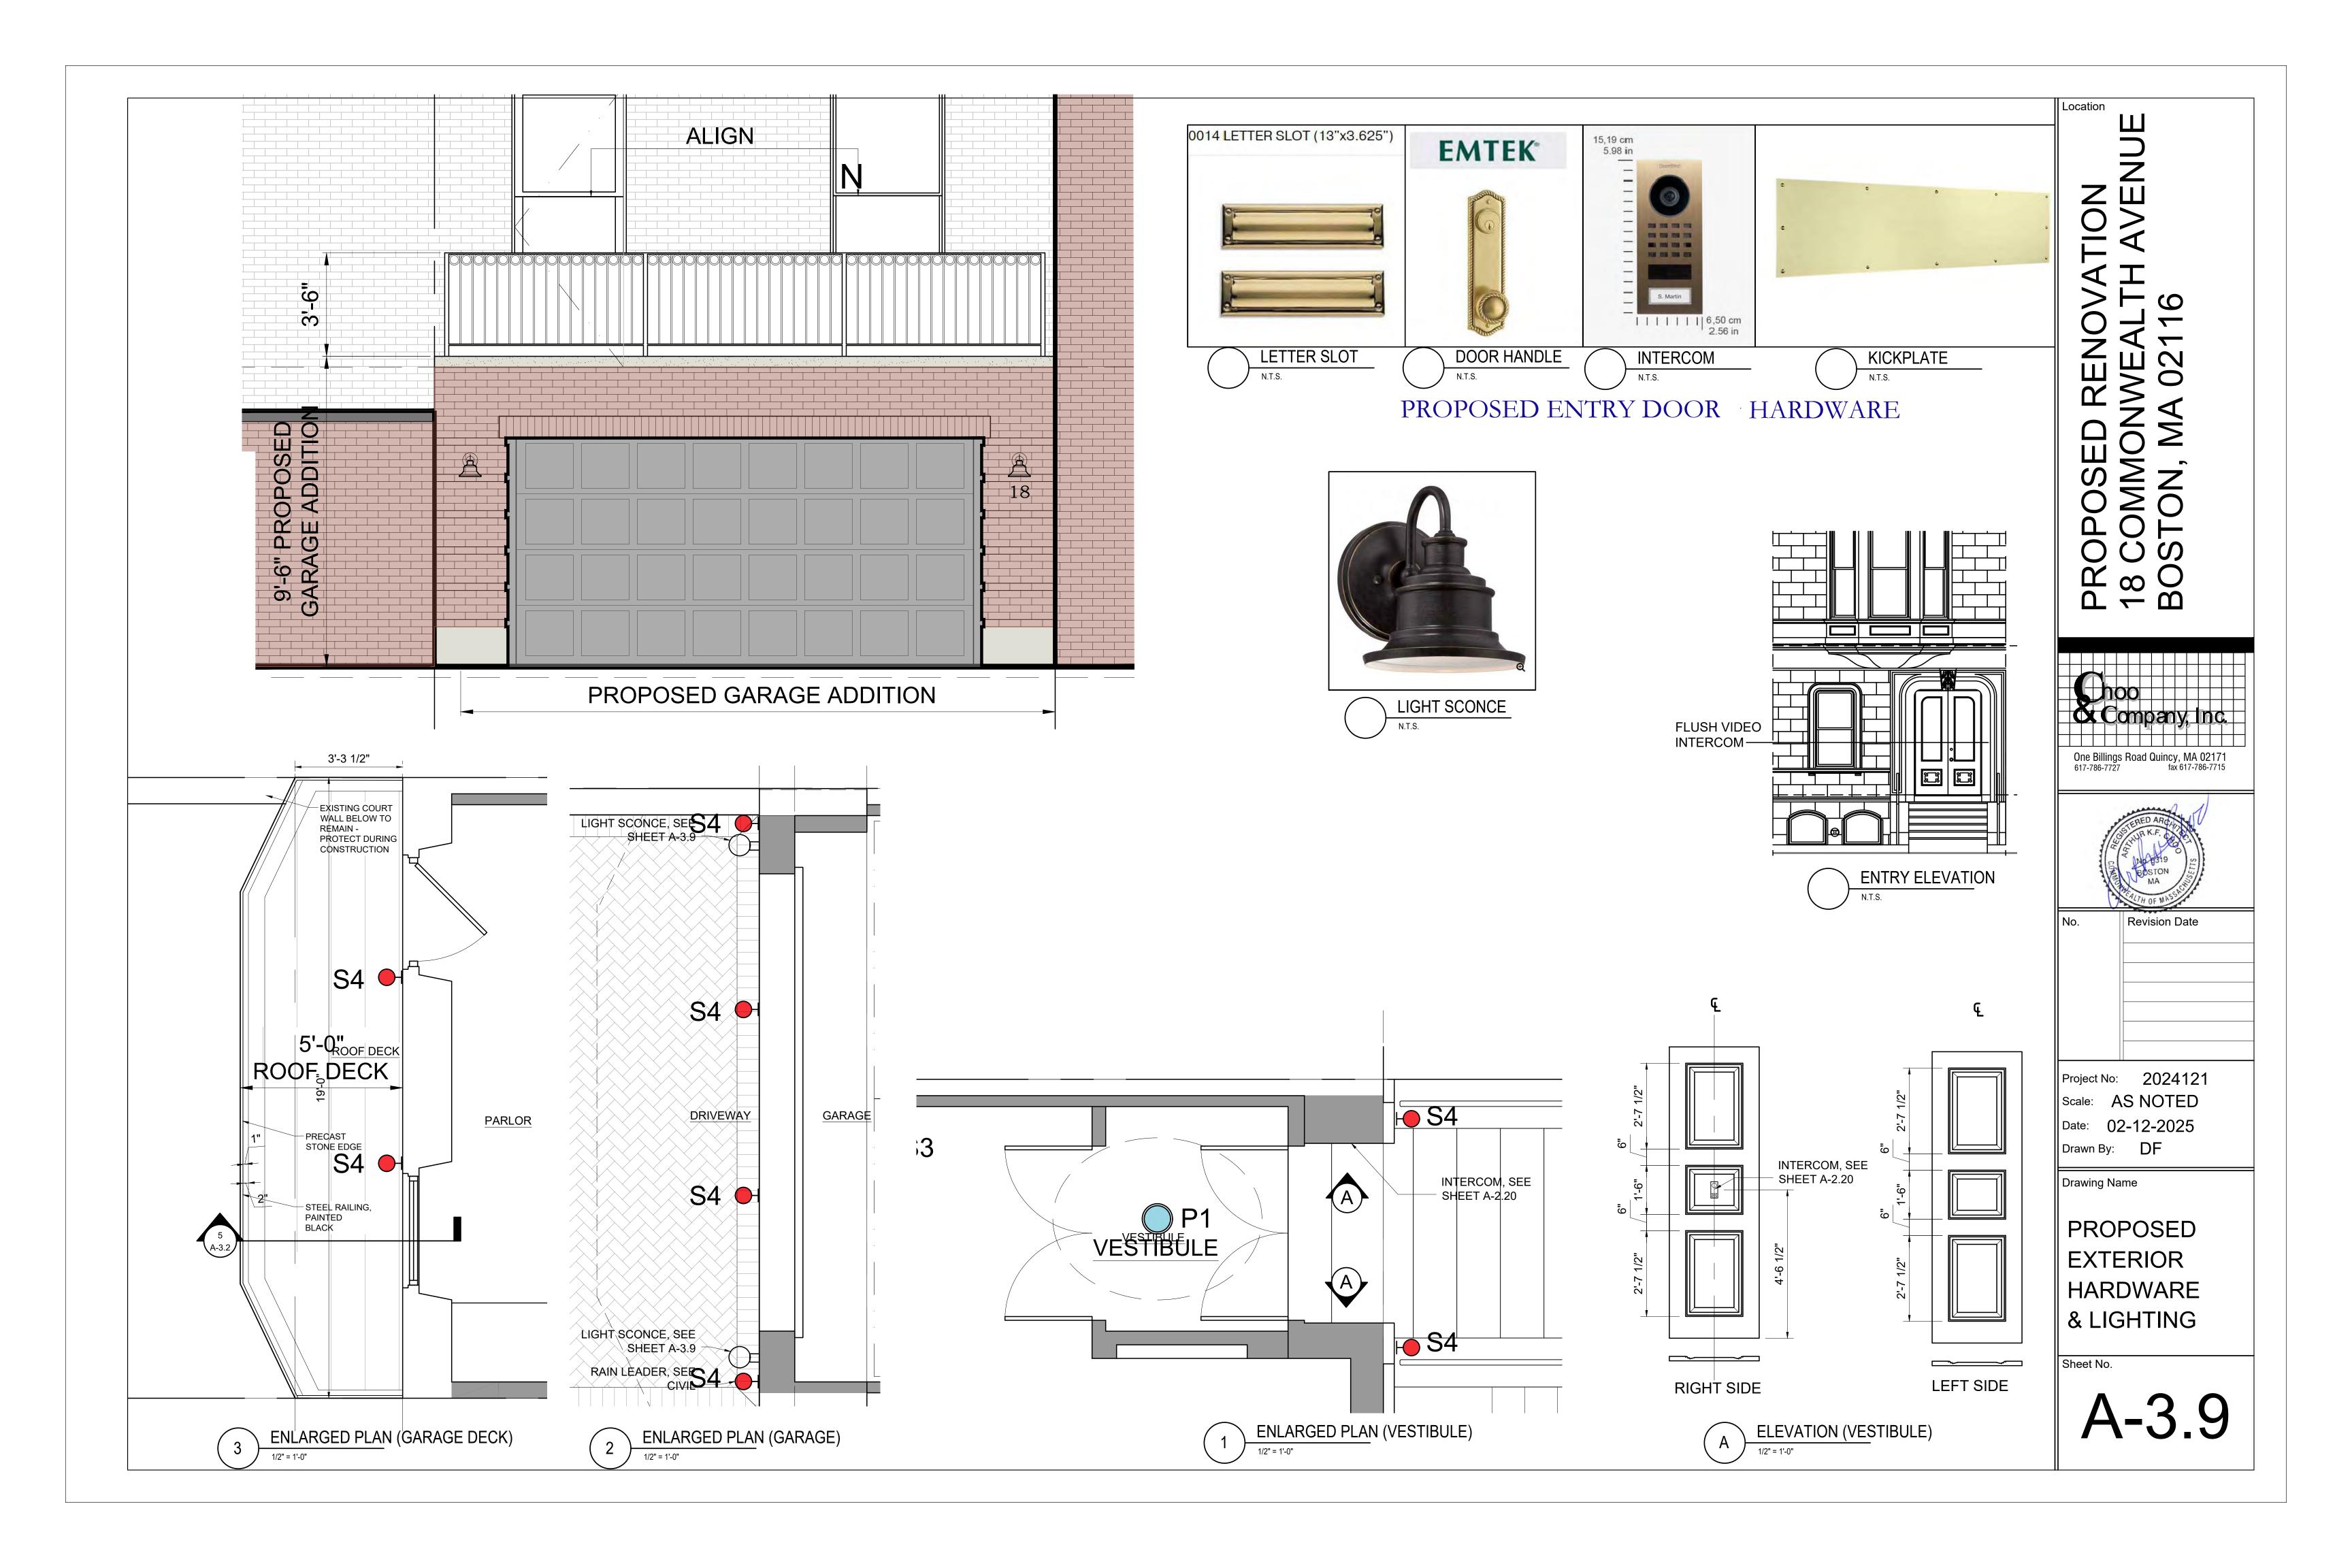

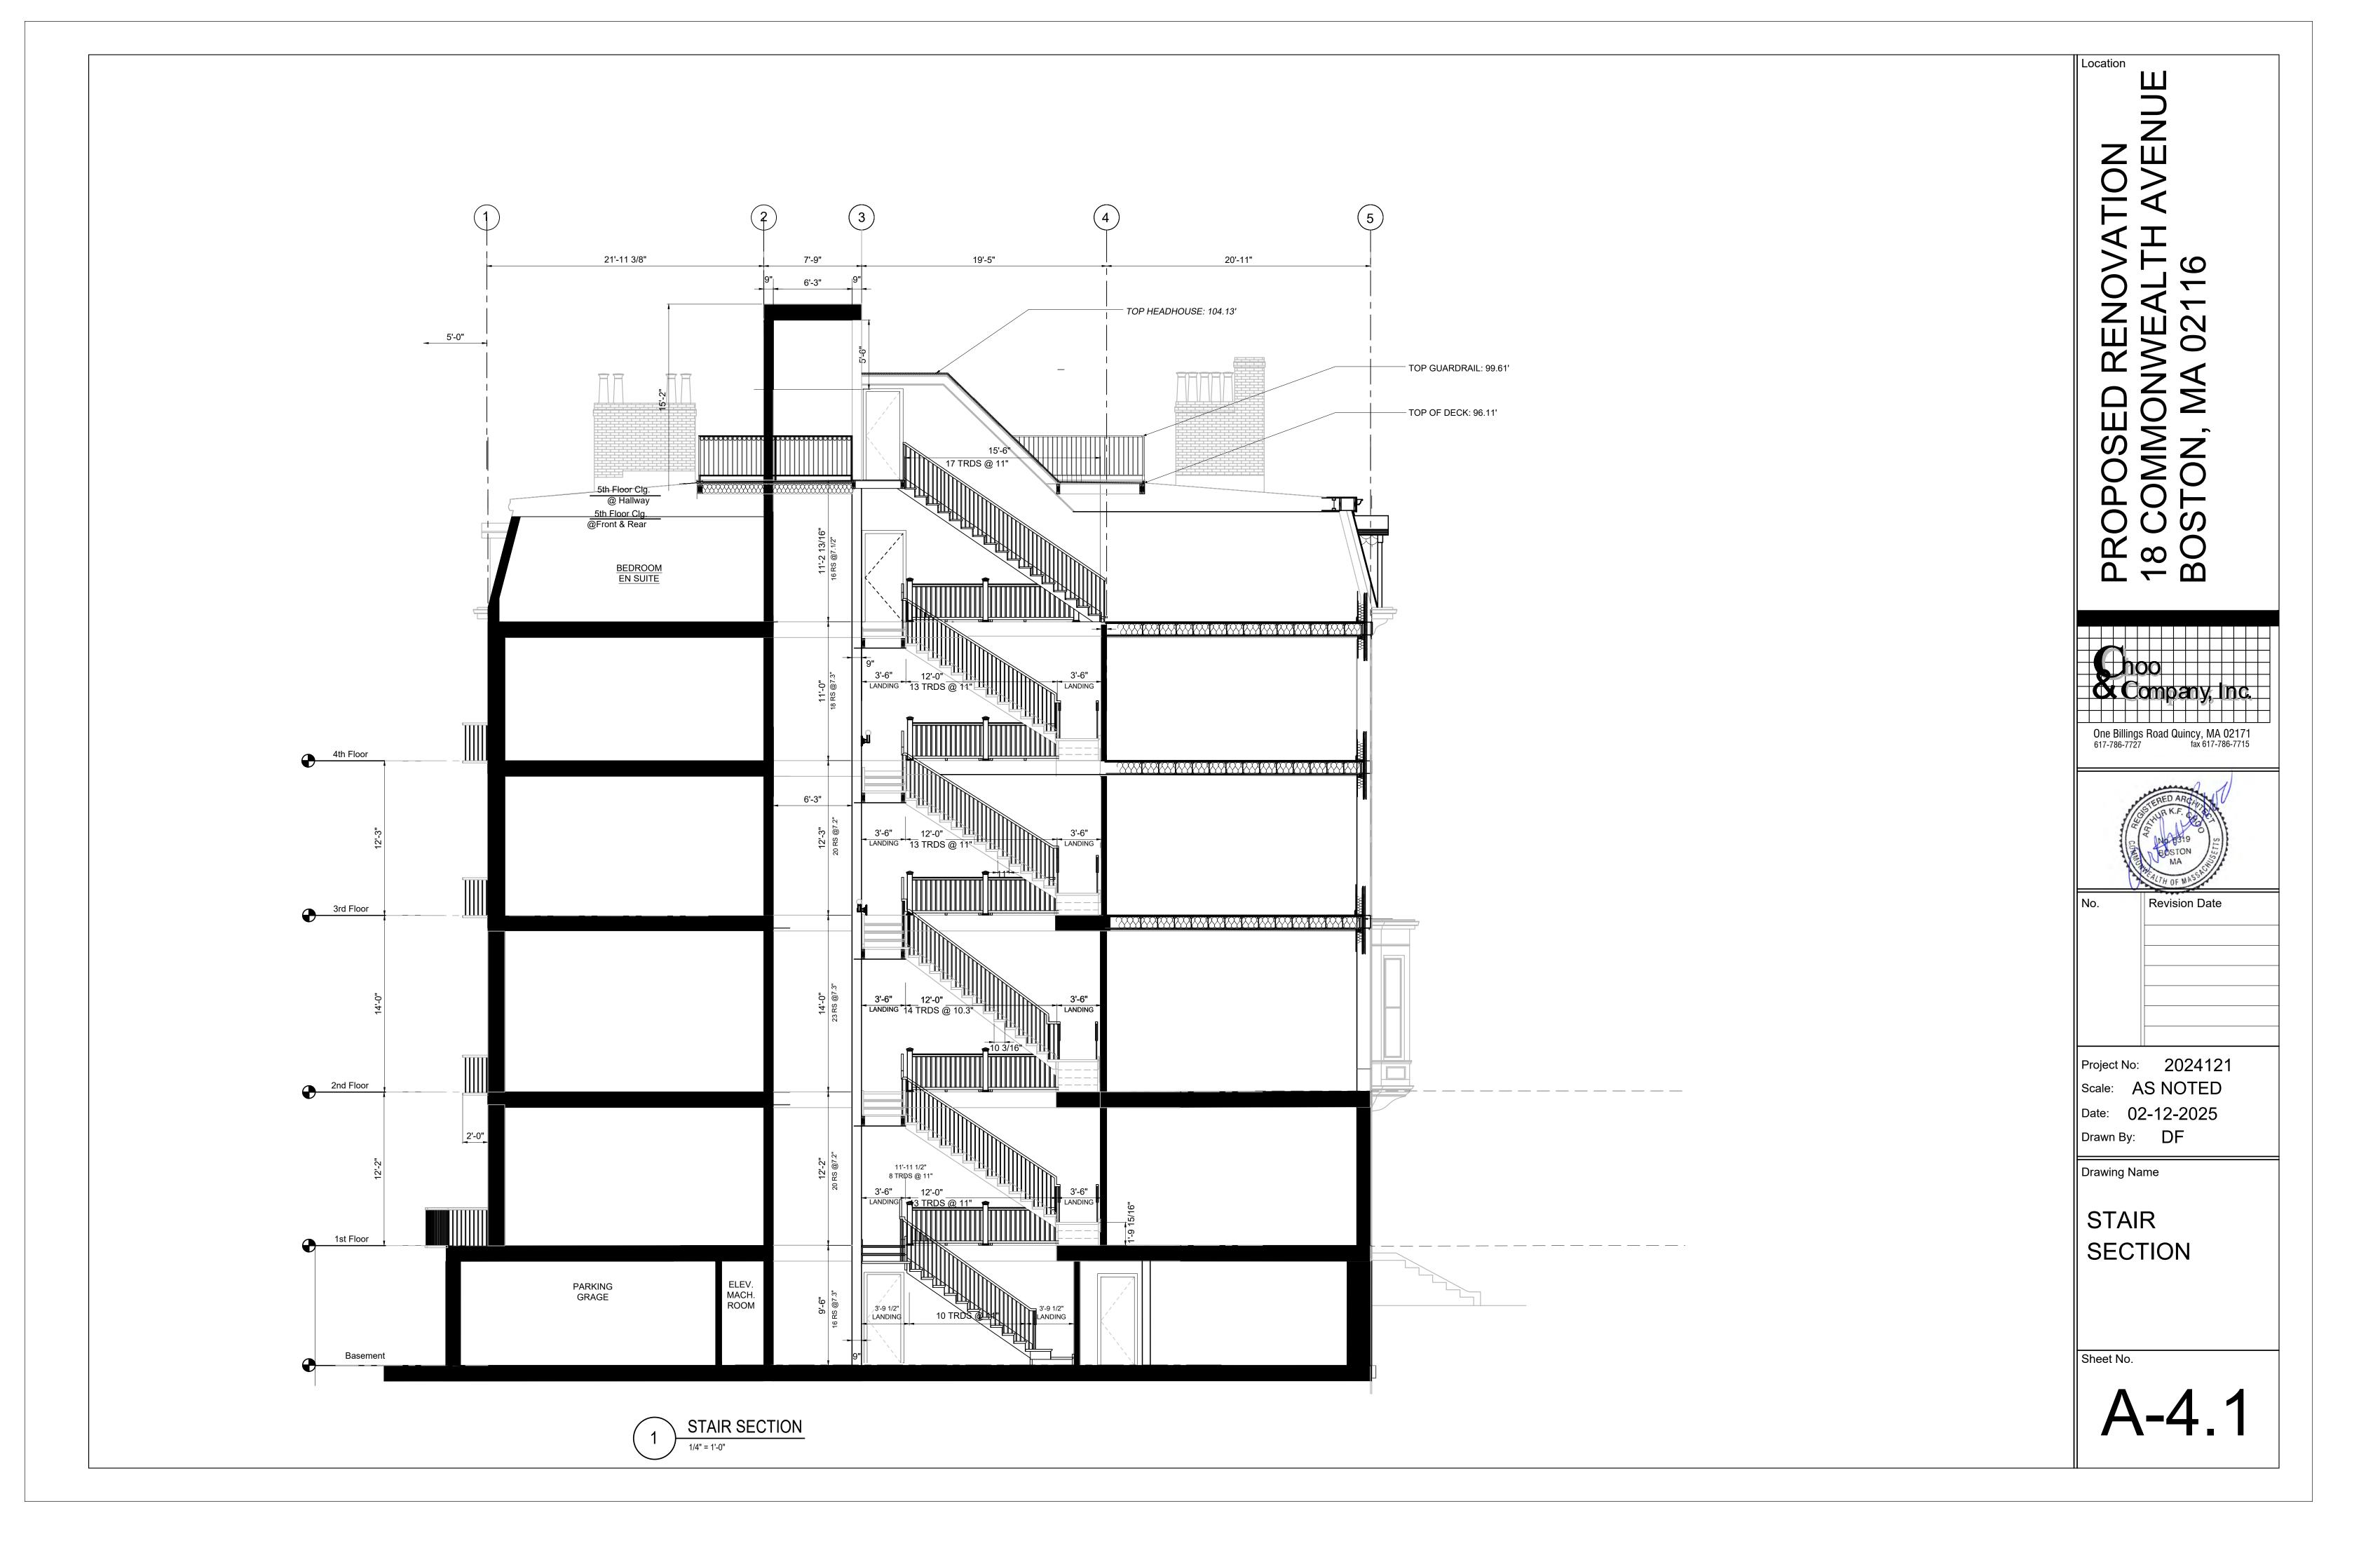

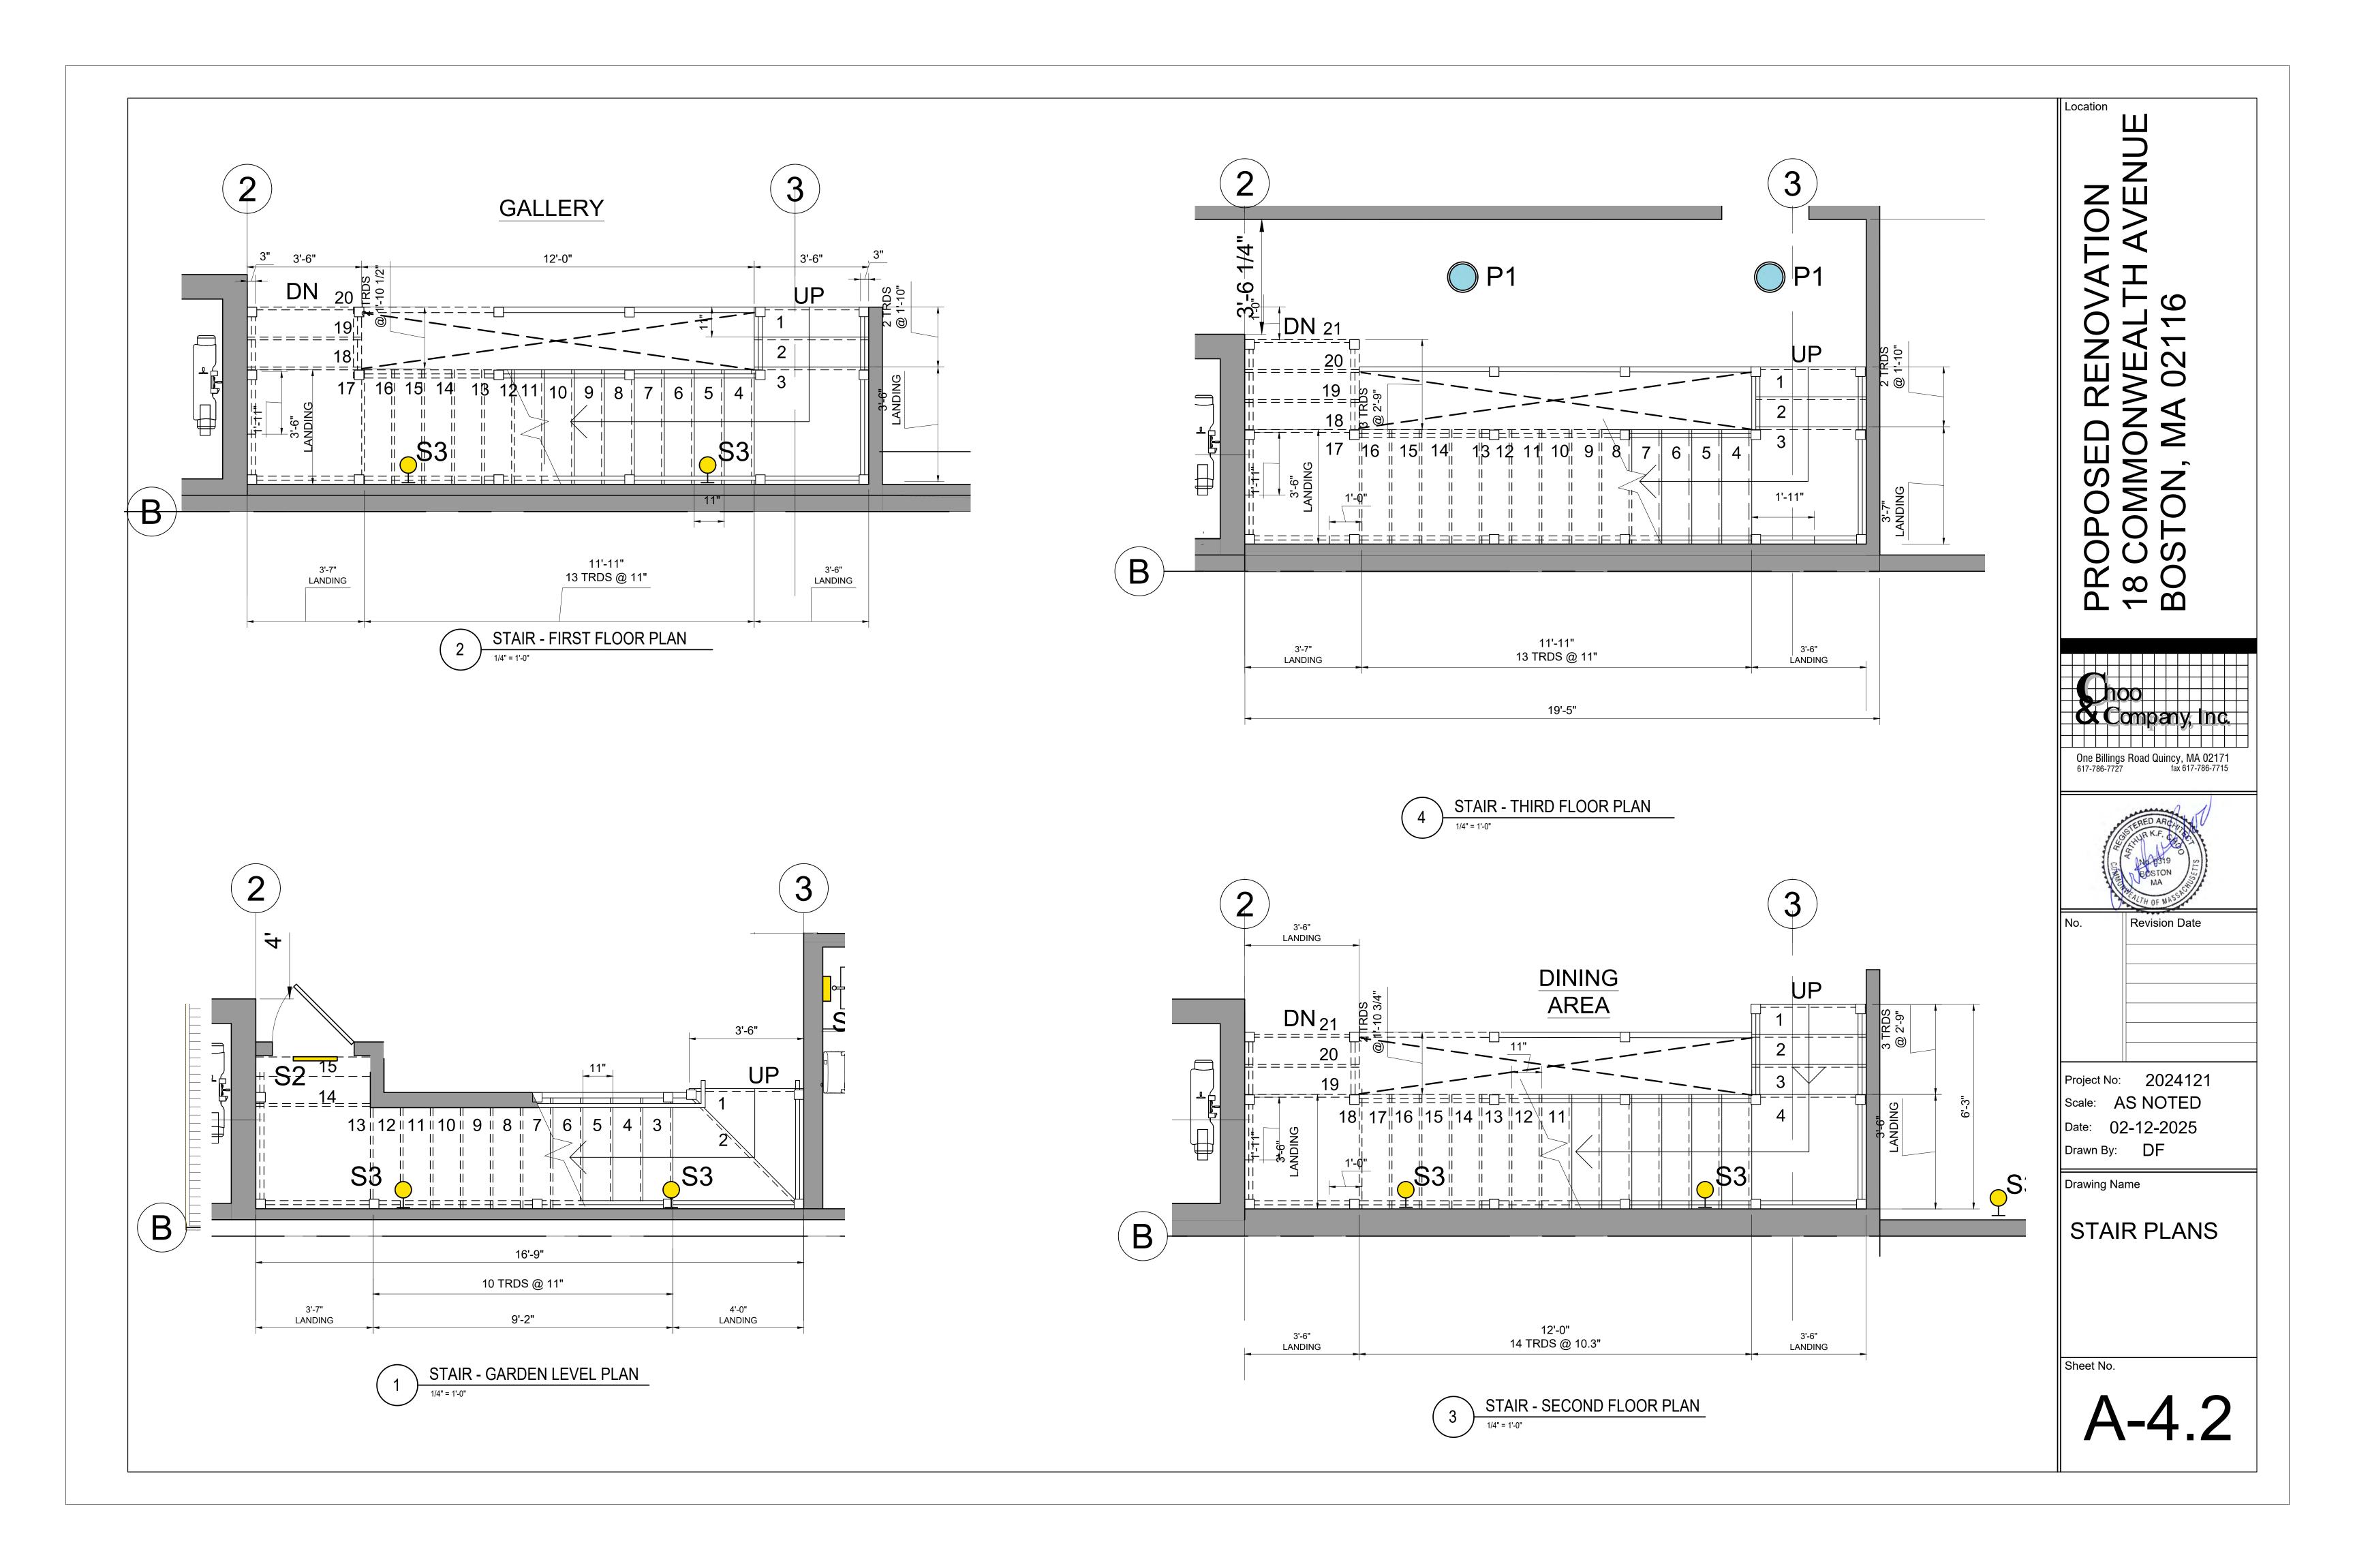


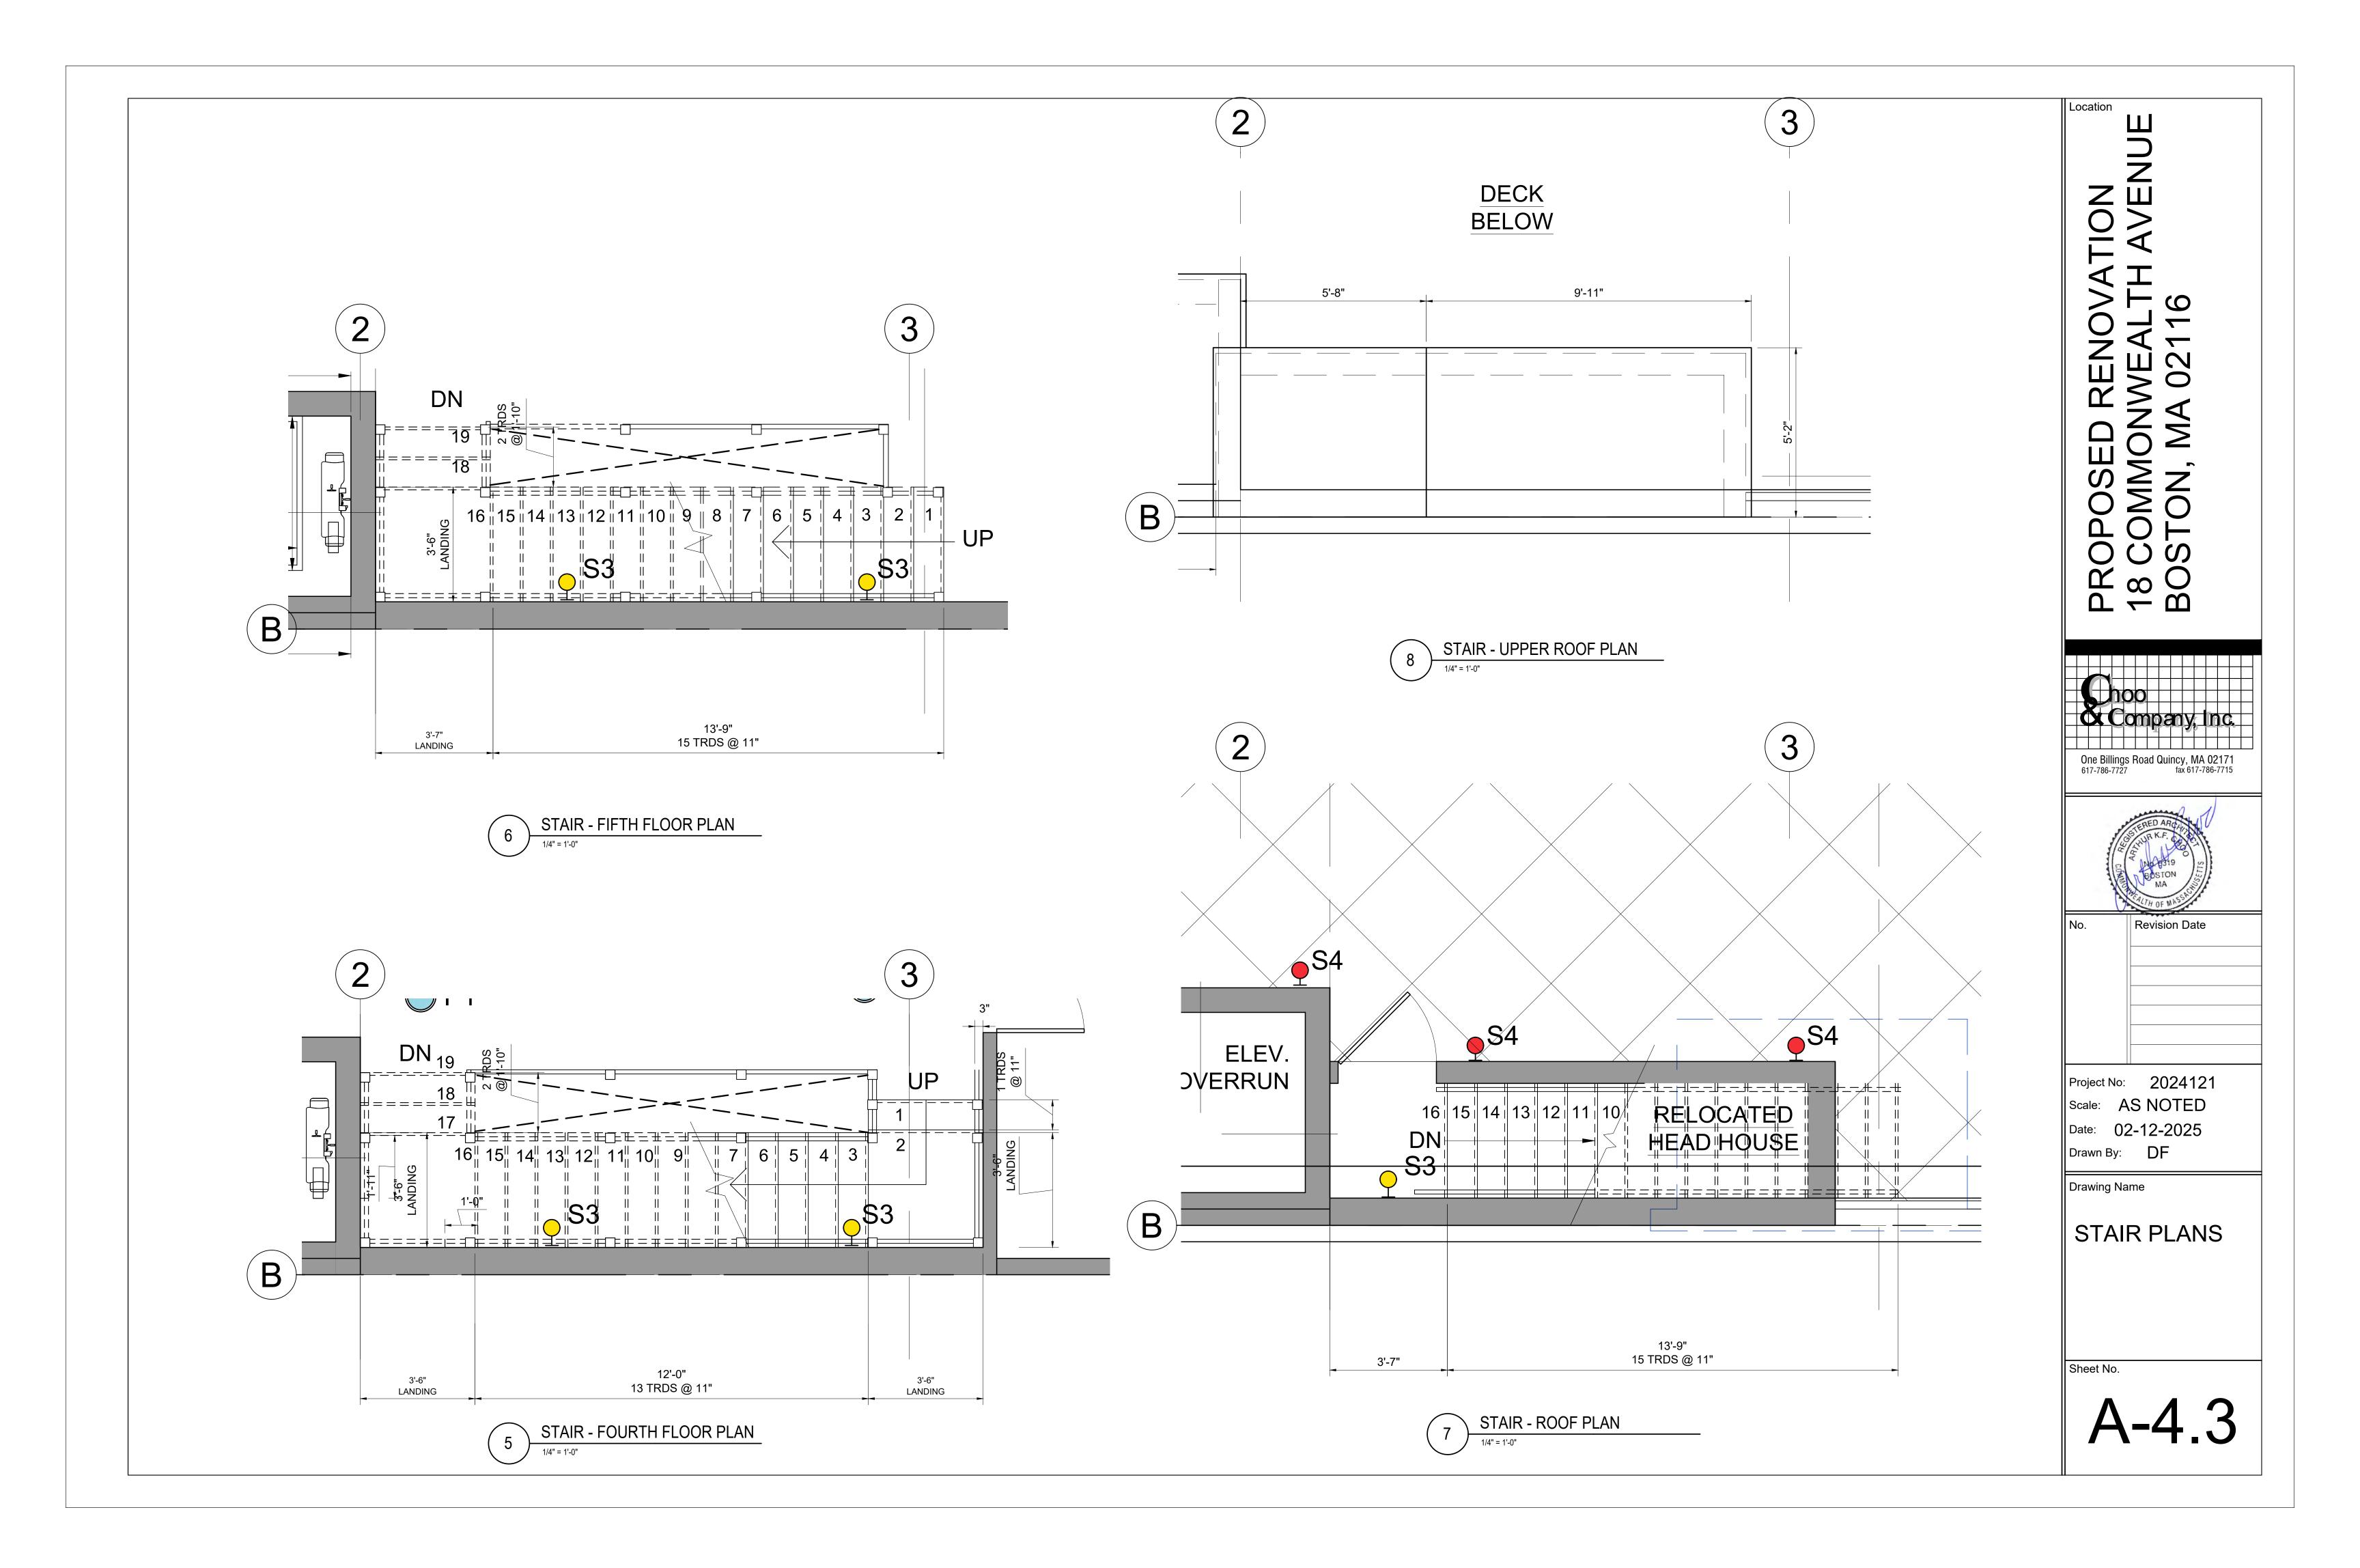

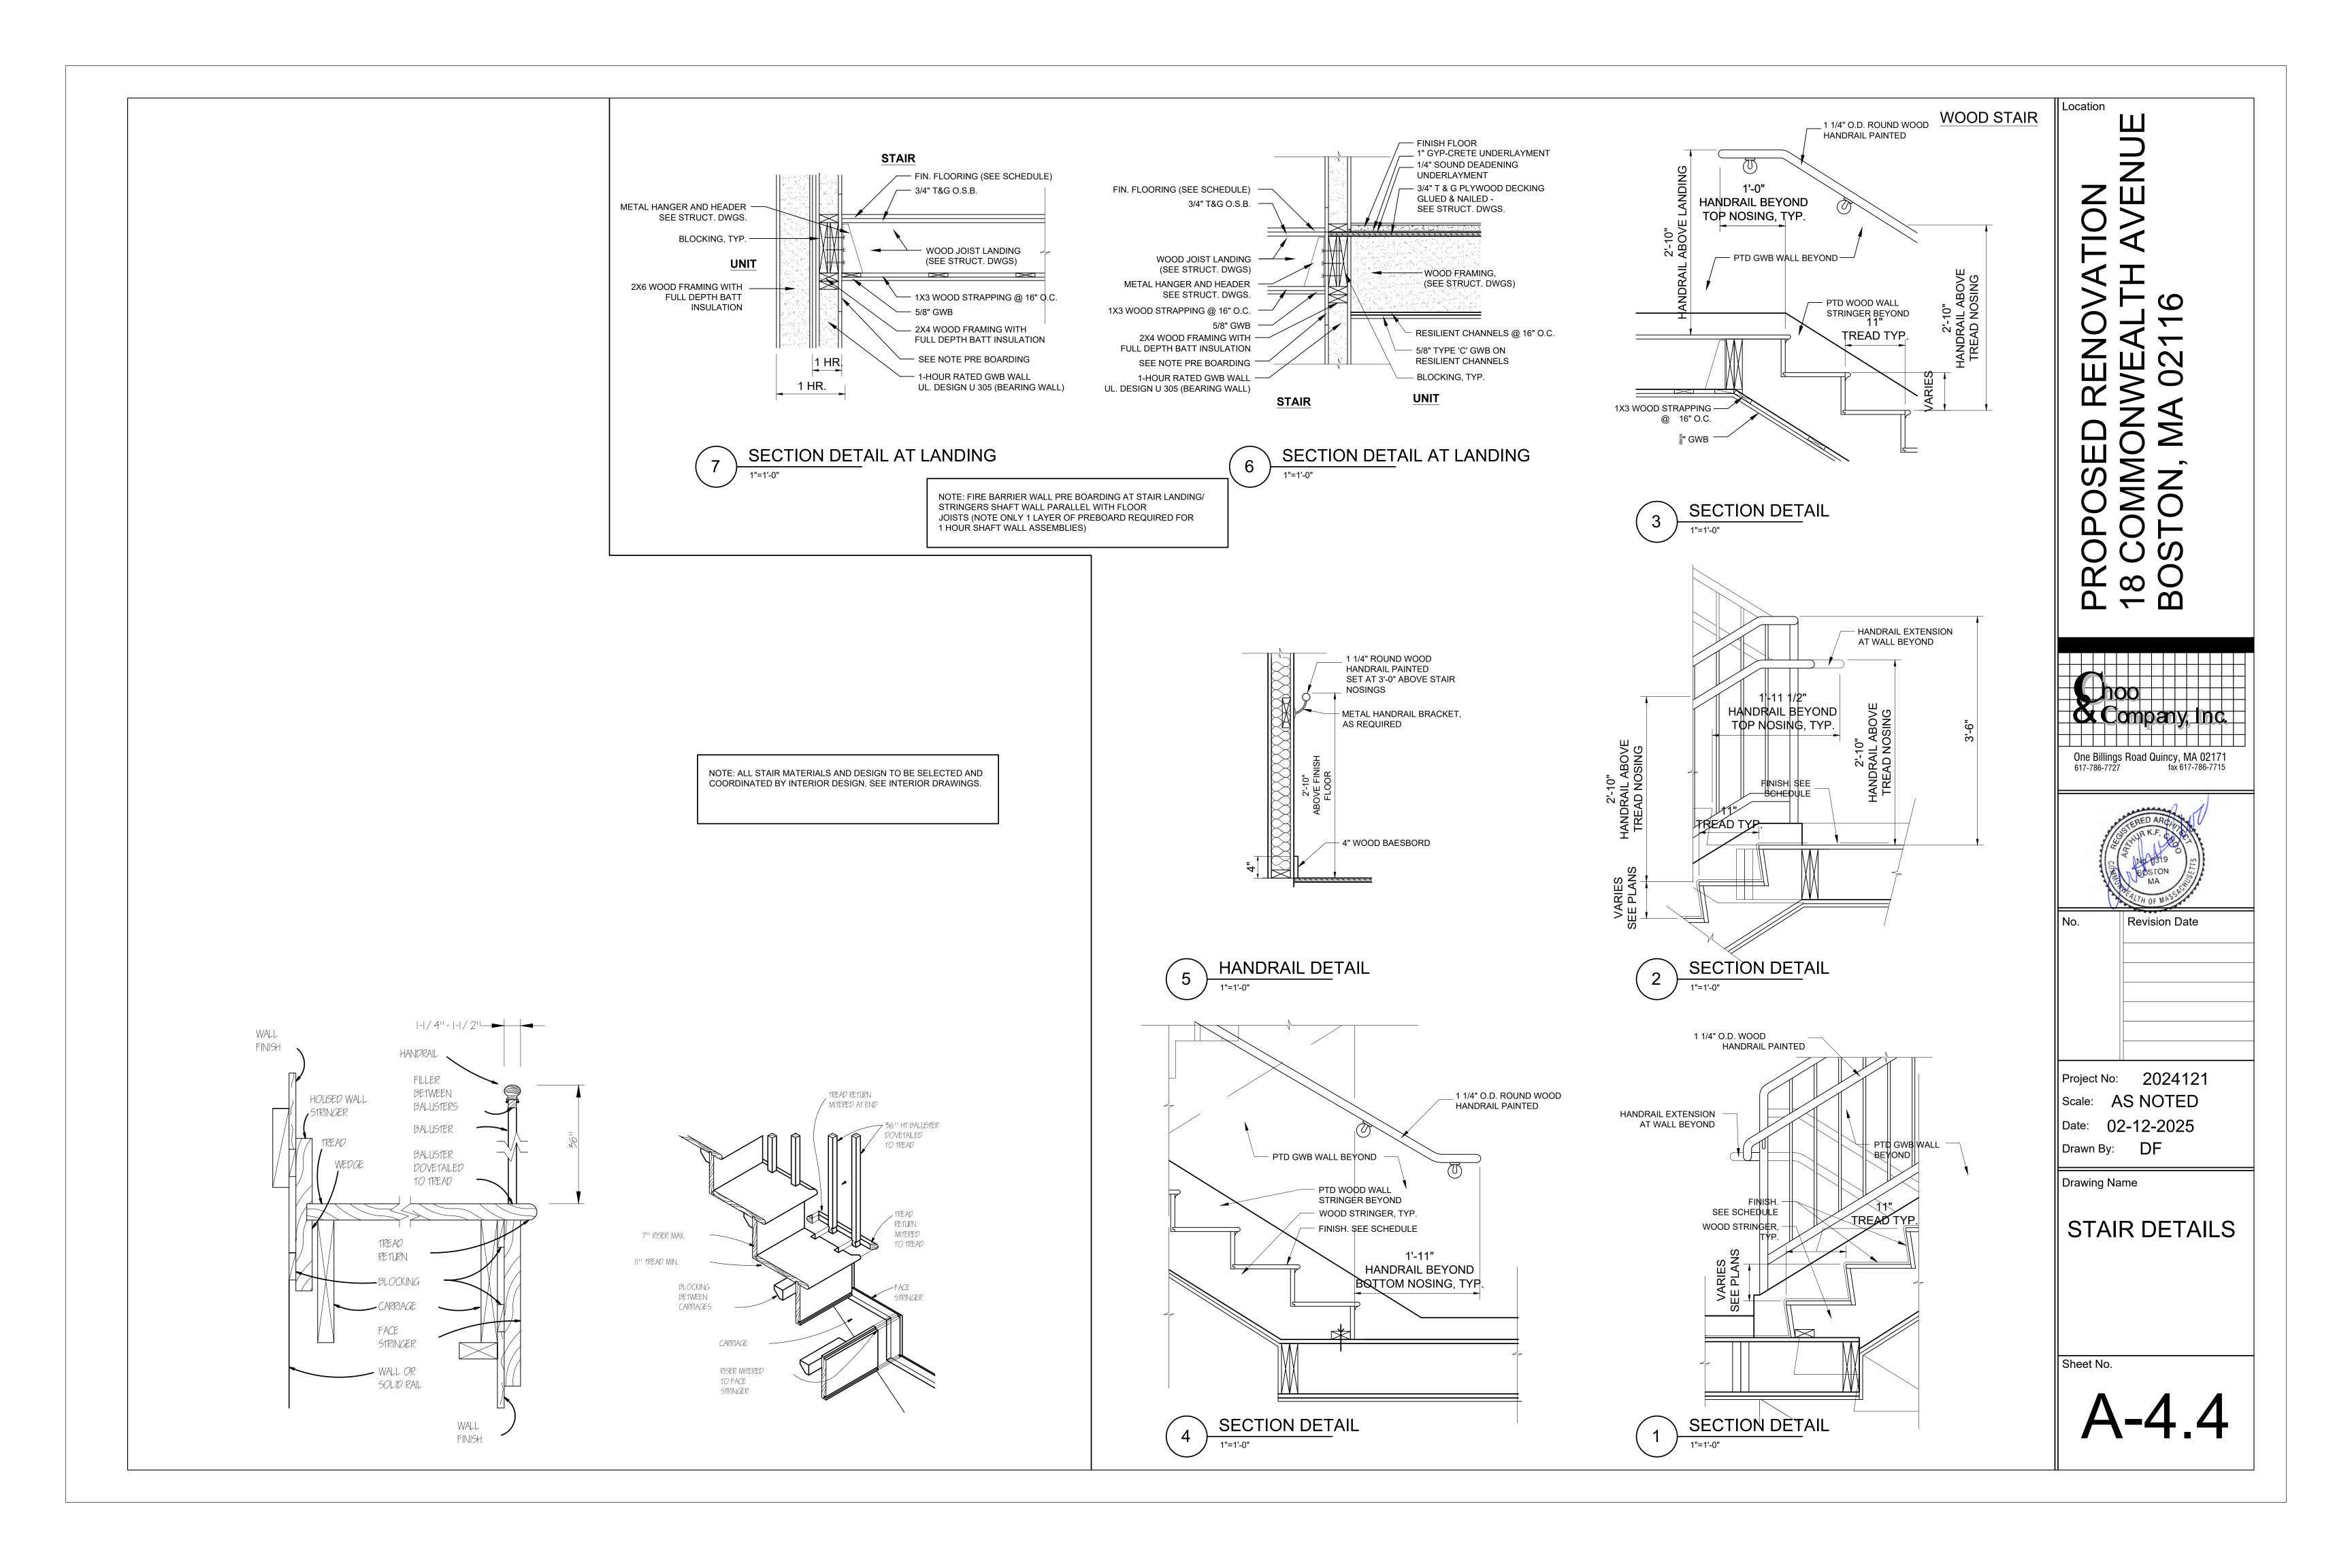


WINDOW TYPES


	WINDOW SCHEDULE					
NO.	MANUFACTURER	MODEL	QUAN.	FRAME SIZE	MATERIAL	TYPE
Α	LEPAGE MILLWORK	XL HUNG	1	2'-4" x 4' 2 1/4"	WOOD	DOUBLE HUNG WINDOW
В	LEPAGE MILLWORK	XL HUNG	1	2'-4" x 4' 2 1/4"	WOOD	DOUBLE HUNG WINDOW
С	LEPAGE MILLWORK	XL HUNG	3	2'-4" x 5'-9"	WOOD	DOUBLE HUNG WINDOW
D	LEPAGE MILLWORK	XL HUNG	3	2'-4" x 6'-5"	WOOD	DOUBLE HUNG WINDOW
Е	LEPAGE MILLWORK	XL HUNG	1	3'-0" x 7'-11 1/2"	WOOD	DOUBLE HUNG WINDOW
F	LEPAGE MILLWORK	XL HUNG	2	2'-0" x 7'-11 1/2"	WOOD	DOUBLE HUNG WINDOV
G	LEPAGE MILLWORK	XL HUNG	1	3'-0" x 6'-1 1/2"	WOOD	DOUBLE HUNG WINDOV
Н	LEPAGE MILLWORK	XL HUNG	2	2'-11" x 2'-6 1/2"	WOOD	ARCH TOP AWNING
J	LEPAGE MILLWORK	XL HUNG	2	2'-8" x 4'-10"	WOOD	DOUBLE HUNG WINDOV
K	LEPAGE MILLWORK	XL HUNG	2	3'-4" x 5'-6"	WOOD	DOUBLE HUNG WINDOV
L	LEPAGE MILLWORK	XL HUNG	2	3'-4" x 6'-6"	WOOD	DOUBLE HUNG WINDOV
М	LEPAGE MILLWORK	XL HUNG	2	3'-4" x 7'-6"	WOOD	DOUBLE HUNG WINDOV
N	LEPAGE MILLWORK	XL HUNG	1	3'-4" x 6'-8"	WOOD	DOUBLE HUNG WINDOV

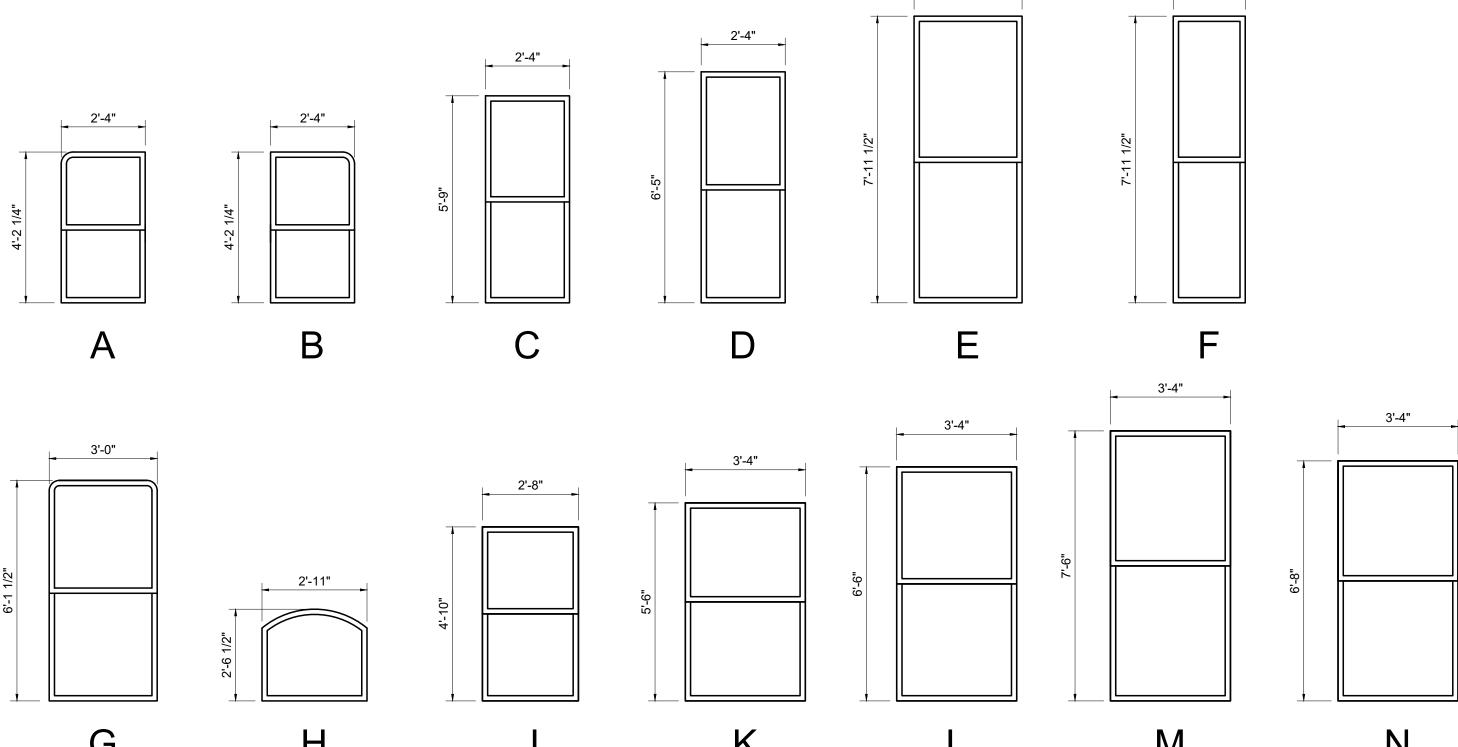

G Η K M N

PANELLED

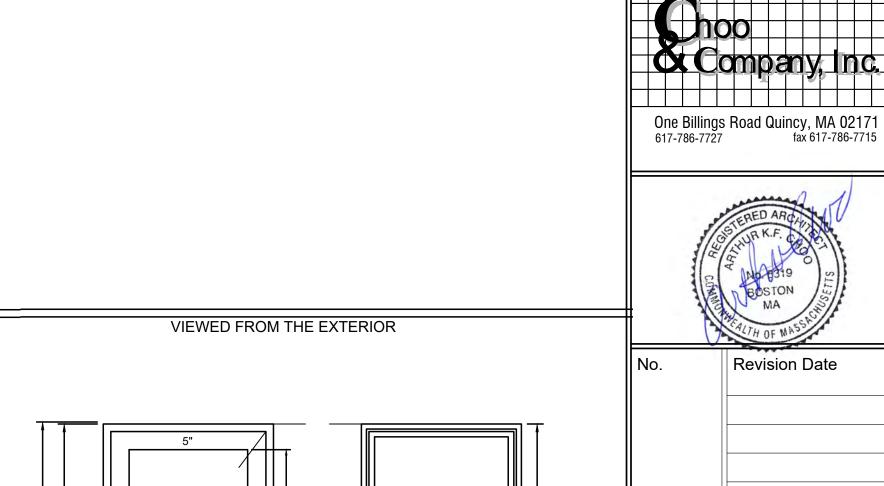

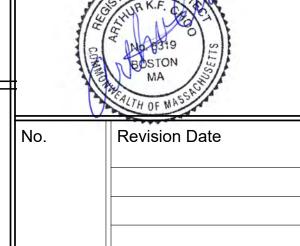


Project No: 2024121 Scale: AS NOTED Date: 02-12-2025 Drawn By: DF

Drawing Name

WINDOW TYPE & SCHEDULE

Sheet No.

DOOR SCHEDULE REMARKS NOTE: G.C. IS RESPONSIBLE TO VERIFY ALL DIMENSIONS AND UNIT QUANTITIES PRIOR TO ORDERING NO. SIZE RATING FRAME TYPE HARDWARE MATERIAL MANUFACTURER **ENTRANCE** WOOD LEPAGE MILLWORK WOOD NEW ENTRY DOOR TO MATCH EXISTING ADJACENT (2) 2'-10" x 8'-6" **ENTRANCE** 3'-4" x 8'-6" WOOD LEPAGE MILLWORK WOOD NEW ENTRY DOOR, MIDDLE RAIL ALIGNS WITH WINDOW TYPE N BED/BATH 2'-8" x 7'-0" WOOD WOOD NEW PANEL DOOR, STYLE SELECTED BY OWNER BED/BATH NEW PANEL DOOR, STYLE SELECTED BY OWNER WOOD 2'-6" x 7'-0" WOOD SINGLE DUMMY NEW PANEL DOOR, STYLE SELECTED BY OWNER WOOD TBD WOOD 2'-6" x 7'-0" SINGLE DUMMY TBD NEW PANEL DOOR, PROVIDE LOUVER AS REQ'D, STYLE SELECTED BY OWNER 2'-6" x 7'-0" WOOD WOOD NEW PAIR OF PANEL DOORS, STYLE SELECTED BY OWNER WOOD SINGLE DUMMY (2) 2'-0" x 7'-0" TBD WOOD ENTRANCE NEW FIRE-RATED PANEL DOOR & FRAME, STYLE SELECTED BY OWNER 3'-0' x 7'-0" WOOD TBD 90 MINS. WOOD STORAGE NEW PANEL DOOR, STYLE SELECTED BY OWNER WOOD TBD 2'-8" x 7'-0" WOOD 10 NOT USED **ELEVATOR** NEW FIRE-RATED PANEL DOOR & FRAME, STYLE SELECTED BY OWNER 3'-0' x 7'-0" WOOD TBD 90 MINS. WOOD 12 NOT USED 13 2'-6" x 7'-0" V.I.F. WOOD **ENTRANCE** NEW EXTERIOR FULL LITE INSULATED TEMPERED GLASS DOOR TBD WOOD 14 | 2'-8" x 7'-0"x 1 3/4" STORAGE NEW PANEL DOOR, STYLE SELECTED BY OWNER WOOD WOOD TBD **ENTRANCE** NEW PANEL DOOR, STYLE SELECTED BY OWNER, PROVIDE DEADBOLT 15 | 2'-8" x 7'-0" x 1 3/4" WOOD TBD WOOD **ENTRANCE** 16 2'-6" x 6'-0" V.I.F. EX'G OPERABLE STEEL SECURITY GRILLE TO BE RESTORED AND RE-INSTALLED STEEL **EXISTING** WOOD **ENTRANCE** 17 2'-8" x 8'-0" V.I.F. WOOD & GLASS EX'G DOOR TO BE RESTORED AND RE-INSTALLED **EXISTING** WOOD POCKET DOOR NEW PANEL DOOR, STYLE SELECTED BY OWNER - PROVIDE PRIVACY LOCK 2'-6" x 7'-0" WOOD TBD WOOD STORAGE NEW PANEL DOOR, STYLE SELECTED BY OWNER 19 WOOD 2'-6" x 7'-0" WOOD TBD -CASED OPENING 20 2'-6" x 7'-0" WOOD WOOD 21 BED/BATH NEW 3 PANEL DOOR SLIDER, STYLE SELECTED BY OWNER 8'-0" x 7'-0" WOOD & GLASS **3-PANEL SLIDER** WOOD GARAGE 22 GARAGE DOOR NEW GARAGE OVERHEAD DOOR, STYLE SELECT BY OWNER, LOW CLEARANCE 14'-0 x 7'-0" WOOD

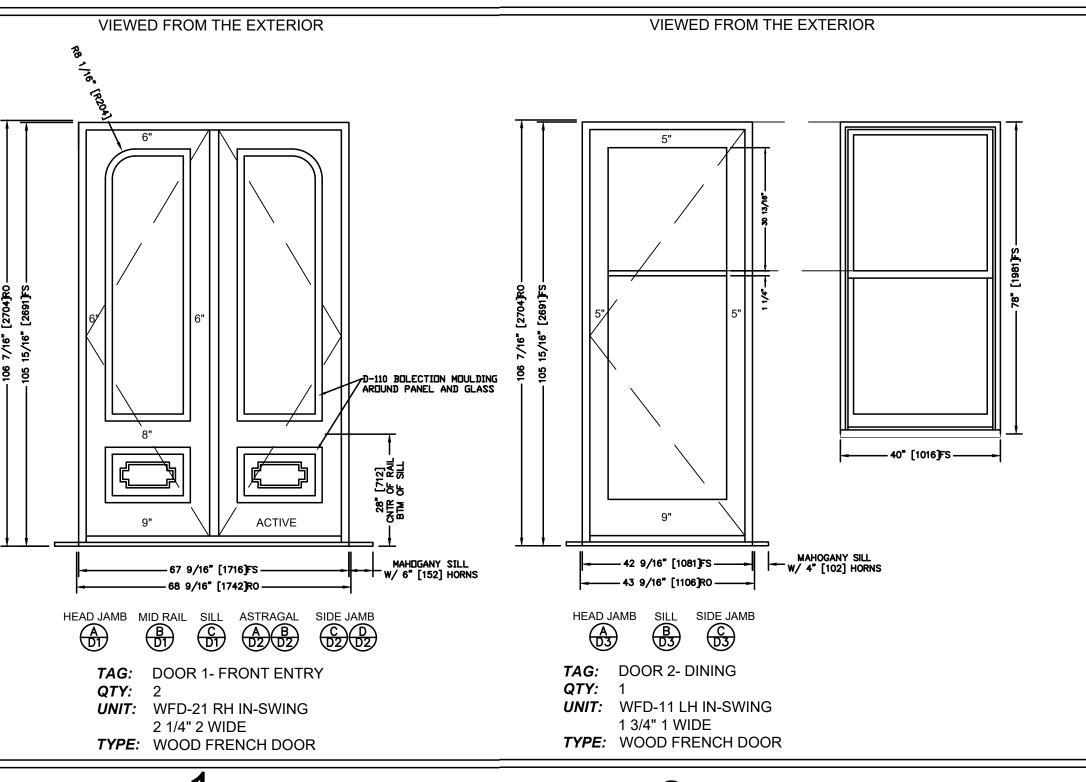

2 LITE

