# North Alley Mechanical Modifications 300 Summer Street


Fort Point Channel Landmark District Application for Design Approval

19 April 2017




## Site Plan and North Elevation Site Line Photos

Photo 1

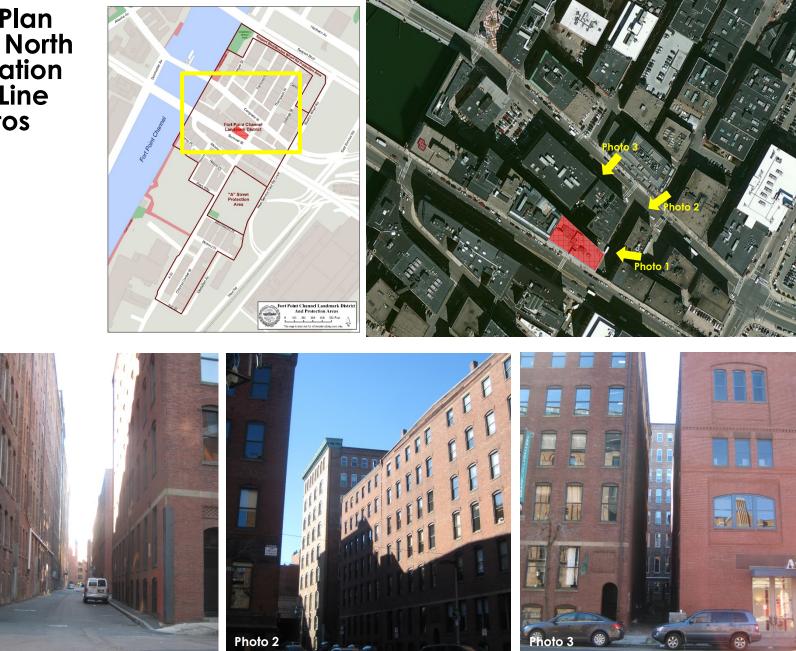

### Proposed North Elevation Mechanical Changes

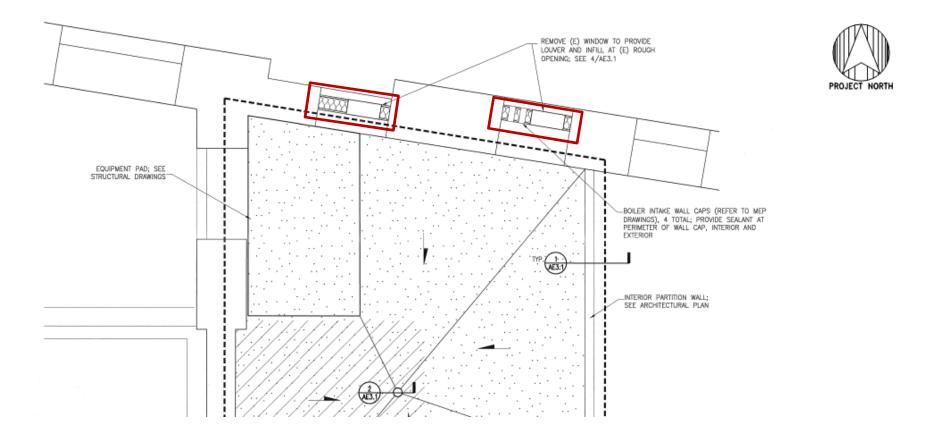

### Proposed North Elevation Mechanical Changes



INFILL WINDOW ELEVATION

4

NTS

## North Elevation Existing Conditions



#### OUTLINE SELECT MATERIAL LIST EXTERIOR REPAIRS AND MECHANICAL PENTHOUSE ADDITION 300 SUMMER STREET, BOSTON, MA

Prepared For: The Artist Building 300 Summer Street Boston, MA 02210

Simpson Gumpertz & Heger Inc. 41 Seyon Street Building 1, Suite 500 Waltham, MA 02453

19 April 2017 Landmark Commission Submission

SGH Project 160933

Below is a list of select materials which will be part of the visible construction. This is not a complete material list.

#### 1.0 METAL PANELS AND FLASHING; MISC. METALS

- A. Metal Panels and Flashing: Coated aluminum, 0.040 in. thickness. Provide in shapes and layout as noted on the Drawings and as follows:
  - 1. Mezzanine Window Infill Panels: Flat-seam coated aluminum panels. Match color and style of North Elevation panels at 4<sup>th</sup> through 7th floors.

#### 2.0 JOINT SEALANTS

- A. Exterior Sealants:
  - 1. Provide urethane sealant (Type 1) as described below unless otherwise specified as Type 2 sealant. Provide sealant that demonstrates good adhesion to stucco, masonry, wood and metal substrates as determined by field adhesion testing. Sealant to provide a minimum of ± 50% joint movement capacity. Color to be chosen by the Owner from the manufacturer's standard colors, except at window perimeter where it should match custom green color. Multiple colors will be required for use in different areas of the project.
    - a. Type 1 Sealant: Nonstaining, one-part urethane sealant, meeting the requirements of ASTM C920 – Standard Specification for Elastomeric Joint Sealants Type S, Grade NS, Class 35.
    - b. Type 2 Sealant: Nonstaining, neutral-cure silicone sealant meeting ASTM C920, Type S, Grade NS, Class 25

#### 3.0 LOUVERS


A. Mechanical Louver: In size and style as required to meet Mechanical specifications; color to match surrounding metal panels.

Exterior Repairs and Mechanical Upgrades 300 Summer Street Boston, MA


# HISTORIC COMMISSION SUBMISSION THE ARTIST BUILDING 300 SUMMER STREET, BOSTON, MA

# 04/19/2017

DRAWING INDEX: AE0.0 COVER SHEET AE1.2 MEZZANINE BOILER ROOM FLOOR PLAN AE2.2 NORTH WALL METAL PANEL LAYOUT AE3.1 BOILER ROOM FLOORING AND LOUVER DETAILS

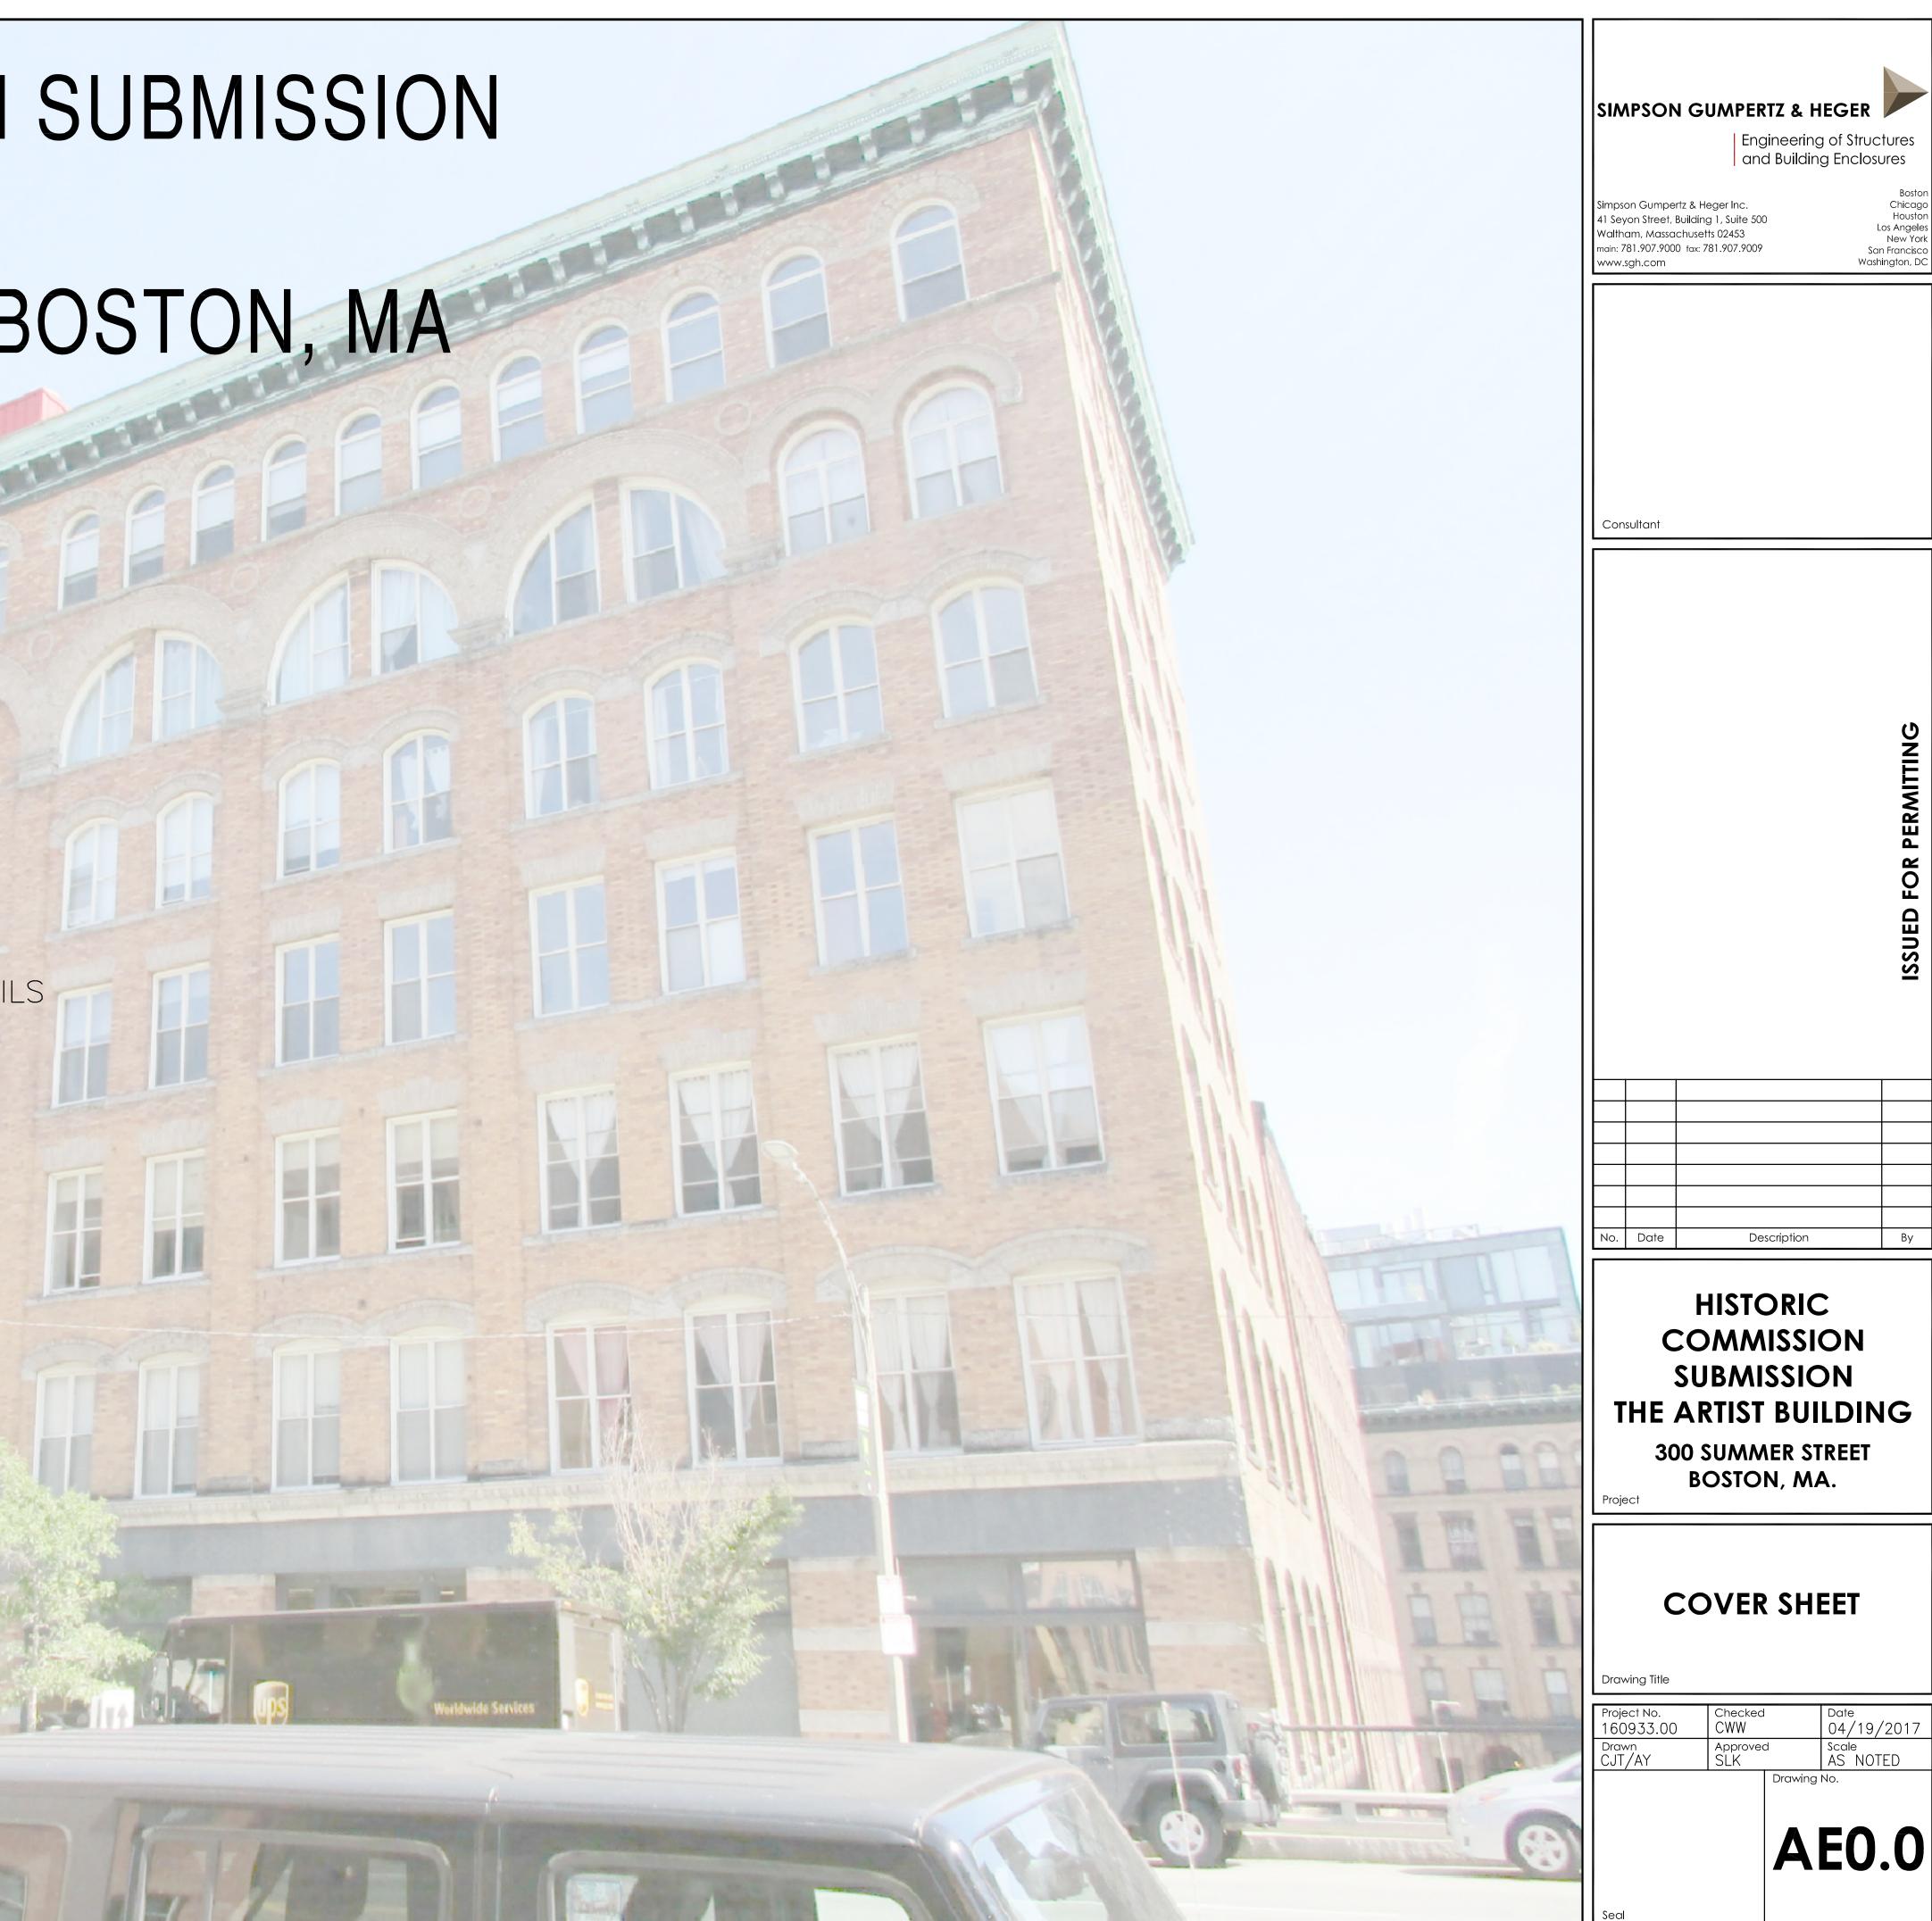

	LEGEND:			
	SLOPE TO DRAIN ½" PER FT. MIN.			
	O FLOOR DRAIN; COORDINATE WITH STRUCTURAL AND MEP LAYOUT. SEE 2/AE3.1, TYP.			
	CONCRETE INFILL OVER (E) METAL DECK; COORDINATE WITH STRUCTURAL DRAWINGS			
	APPROXIMATE EXTENTS OF (N) BOILER ROOM			
REMOVE (E) WOOD FLOORING. PROVIDE CONCRETE TOPPING				
<u>NO</u> 1.	ES: FLOORING: Remove (E) hardwood floor within (N) boiler room. Provide concrete topping with ½" per ft. slope to drain, 3" min. at drain. Provide concrete equipment pad below (N) boilers and pumps; see Structural Drawings. Coat concrete topping with epoxy system. Broadcast sand into system Provide supplemental framing below mezzanine floor; see Structural Drawings.			
2.	BOILERS: Provide boilers and related mechanical, equipment, and plumbing equipment on the mezzanine level as shown; see MEP Drawings.			
3.	LOUVERS: Remove two windows at locations noted. Provide infill partition in rough opening, sized to accommodate louver; see AE3.1. Provide louvers within partition wall as noted on MEP Drawings.			

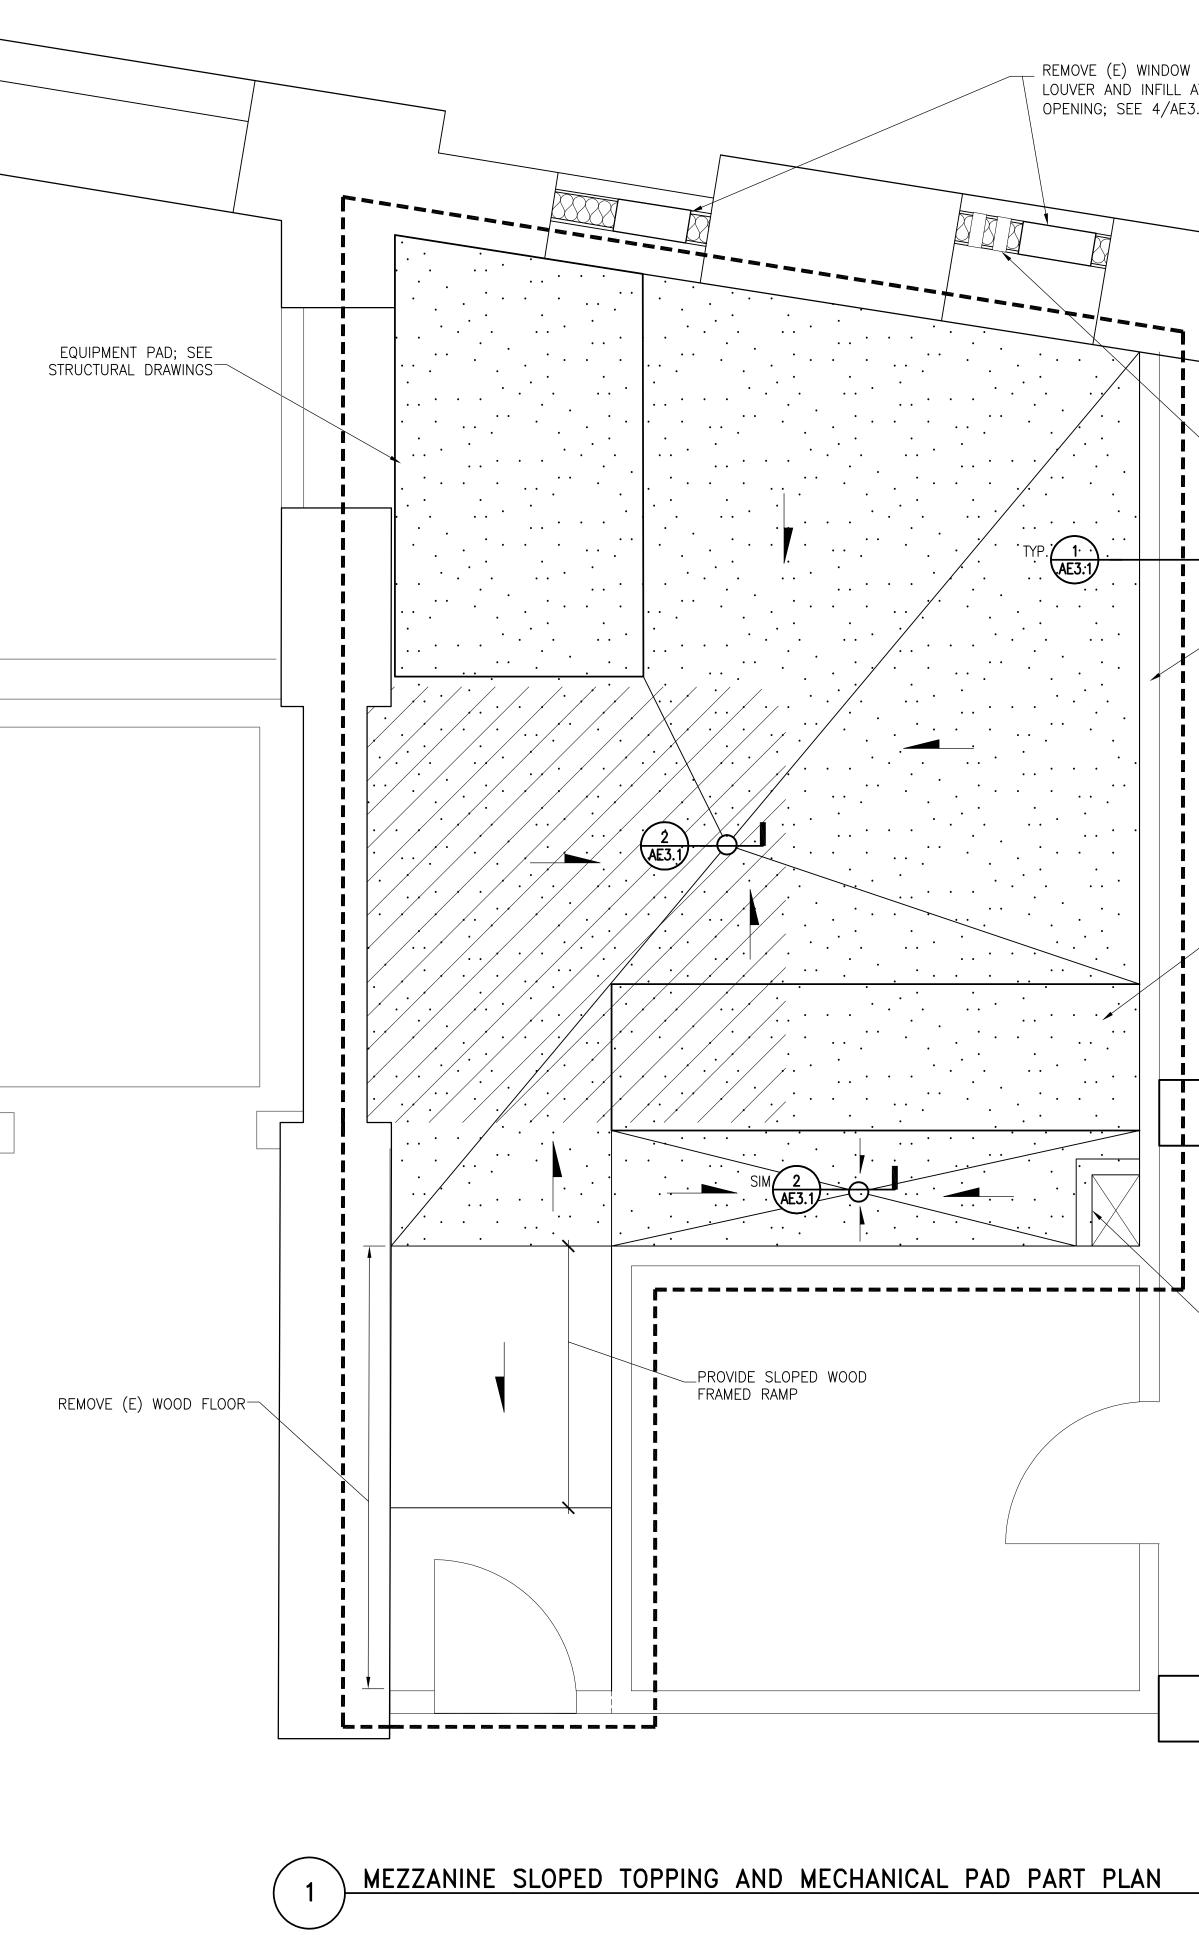

N TO PROVIDE AT (E) ROUGH	SIMPSON GUMPERTZ & HEGER Engineering of Structures and Building Enclosures
E3.1	BostonSimpson Gumpertz & Heger Inc.Chicago41 Seyon Street, Building 1, Suite 500HoustonWaltham, Massachusetts 02453Los AngelesWaltham: 781.907.9000 fax: 781.907.9009San Franciscowww.sgh.comWashington, DC
BOILER INTAKE WALL CAPS (REFER TO MEP DRAWINGS), 4 TOTAL; PROVIDE SEALANT AT PERIMETER OF WALL CAP, INTERIOR AND EXTERIOR	Consultant
INTERIOR PARTITION WALL; SEE ARCHITECTURAL PLAN	
	R PERMITING
EQUIPMENT PAD; SEE STRUCTURAL DRAWINGS	ISSUED FOR
CURB AT OPENING	No. Date Description By
	HISTORIC COMMISSION SUBMISSION THE ARTIST BUILDING 300 SUMMER STREET
	BOSTON, MA. Project MEZZANINE
	BOILER ROOM FLOOR PLAN Drawing Title
1/2" = 1'-0"	Project No.CheckedDate160933.00CWW04/19/2017DrawnApprovedScaleCJT/AYSLKAS NOTEDDrawing No.
	Seal AE1.2



SIMPSON	-	HEGER Ing of Structures		
Waltham, Massa	Building 1, Suite 500	Boston Chicago Houston Los Angeles New York San Francisco Washington, DC		
Consultant				
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HISTORIC COMMISSION SUBMISSION SUBMISSION THE ARTIST BUILDING 300 SUMMER STREET BOSTON, MA.				
NORTH WALL METAL PANEL LAYOUT				
Project No. 160933.00 Drawn CJT/AY	Approved SLK Drawi	Date 04/19/2017 Scale AS NOTED ing No.		
		<b>E2.2</b>		

